

PUBLIC WORKS DEPARTMENT ENGINEERING DIVISION 156 S. BROADWAY, SUITE 150

156 S. BROADWAY, SUITE 150 TURLOCK, CA 95380 PHONE: (209) 668-5520 FAX: (209) 668-5563 TDD: (800) 735-2929 engineering@turlock.ca.us

Addendum No. 1 April 26, 2024

City Project No.: 23-031, Package 2
Roads Program Capital Improvement Project

Plan holders:

This addendum includes revisions to Plans and Specifications and provides clarifications and answers to questions submitted to the City.

Revisions to Plans and Specifications

The following additions, deletions or modifications shall become part of the Contract Documents:

Strikethrough text (text) indicates deletions.

Bold Italicized text (text) indicates additions.

Item No. 1:

Revise Bid Schedule, Bid Item 15, Roadway Excavation:

Item	Description
15	Roadway Excavation (F)

Definition of (F) is added after Bid Item Table as:

(F) Denotes Final Pay Item Per Section 9-1.02C of The State Standard Specifications.

Item No. 2:

Revise Bid Schedule, Updated Quantities per Item No. 6:

ltem	Description	Quantity
11	Remove Concrete (Curb and Gutter)	4 070 4260
12	Remove Concrete (Pathway)	4 10 445
15	Roadway Excavation (F)	600 610

20	Hot Mix Asphalt (Type A)	10560 10580
24	Minor Concrete (Curb and Gutter)	6010 6200
27	Minor Concrete (Pathway)	4 10 445
30	Minor Concrete (Driveway)	4 850 5045
34	Remove and Replace Monument	67

Item No. 3:

Delete Pages 7 through 11 of the Specifications ("Bidding Form")

Add Pages 7 through 11 as attached to the Addendum. Changes reflect the revisions from Item No. 1 and No. 2 and the revised sheets identified in Item No. 6.

Item No. 3:

Revise Special Provisions, Section 5 General, as follows:

Section 5.20, Progress Schedule:

Contractor shall furnish City with a Critical Path Method progress schedule at the preconstruction meeting. Progress Schedules will be required for this contract and shall conform to the provisions in Section 7-5.01, "Progress Schedule" of the State Standard Specifications. If Contractor falls more than 10 working days behind the schedule, the Contractor shall submit an accelerated schedule to show how the work will be completed by the project Completion Date identified in the Agreement. The progress schedule shall show the construction activities extending for the duration of the working days. Any deviation from the outline must be approved by Engineer. Contractor shall not be allowed to start construction activities until the progress schedule is accepted by Engineer. Payment for the progress schedule shall be included under the Miscellaneous Facilities and Operations Jobsite Management bid item.

Section 5.22, Order of Work (5th Paragraph):

- Project No. 23-031, Roads Program Capital Improvement Project, Package 2-1
- Project No. 23-032, City of Turlock Roads Program Capital Improvements Project

Section 5.24, Surveying (1st Paragraph):

Construction survey staking shall be provided by the Contractor and shall comply with Chapter 12 of the Caltrans Surveys Manual. Contractor shall provide staking sufficient for the installation and inspection of all improvements shown on the plans. Staking shall remain in place for the inspection of all improvements and shall not be removed prior to obtaining permission from the Engineer.

Section 5.25, Testing (2nd Paragraph):

Unless otherwise noted, the Contractor shall provide all acceptance Quality Control Testing including compaction testing for the native soil. Acceptance testing will be performed by the City. Coordination of said testing is the responsibility of Contractor. The Contractor shall provide at least 48 hours' notice to the Engineer in advance of all testing. All costs associated with Quality Control Testing shall be included in the unit prices for the various contract items. No separate payment will be made therefore.

Section 5.35, Utility Verification (3rd Paragraph):

Within the first 10 working days, the Contractor shall physically verify all locations of existing utilities, and certify, in writing, that there are no conflicts with planned improvements. If there are conflicts, the Contractor shall indicate in writing, the specific conflict and allow the Engineer 10 working days to provide a response. The Contractor shall include a schedule activity for potholing (the Contractor's responsibility), and notification to the Engineer in the baseline schedule. The 10 working days for Engineer review shall be identified as an City-owned activity in the Contractor's baseline schedule. If there are no conflicts identified, this activity will then be shown as City-owned float. The Contractor shall not proceed with any other construction activities until written acceptance of the Contractor's utility conflict certification letter is granted by the Engineer.

Item No. 4:

Revise Special Provisions, Section 8 Prosecution and Progress, as follows:

Section 8.01, Start of Jobsite Activities (5th Paragraph): The Contractor may enter the jobsite *prior to the first working day* only to:

Item No. 5:

Revise Special Provisions, Section 10 Technical Special Provisions, as follows:

Construction Area Signs (delete 2nd Paragraph and replace):

The cost for lead compliance plan and implementation shall be considered as included in the various other bid items and no additional compensation will be made therefore.

Temporary advance notification signs on Type III barricades shall be placed at all work zone entry points a minimum of 7 days prior to the start of construction at each roadway section. The signs must be 48" x 60" and include the anticipated construction start and completion dates. Reference City Standard Specification Section 11-13.

Traffic Control System (3rd Paragraph):

Notify adjacent residents and business in writing 14 calendars day before the scheduled street closure. Include the closure schedule and duration of closures in the notification. Local access must be maintained at all times for traffic to all residences, businesses, and driveways within the construction zone. This includes, but is not limited to, waste management

(Turlock Scavenger), delivery (USPS, FedEx, etc.), and other City provided services. If the contractor's operations impact the providers' regularly scheduled services, alternative accommodations must be provided to the satisfaction of the Engineer at the Contractor's expense.

Portable Changeable Message Sign (2nd Paragraph):

Portable changeable message signs will be measured by the unit from actual count *provided for the entire duration of construction.* The contract unit price paid for portable changeable message sign shall include full compensation for furnishing all labor, materials, tools, equipment, and incidentals, and for doing all the work involved in furnishing, placing, operating, maintaining, repairing, replacing, transporting from location to location and removing the portable changeable message signs, as shown on the plans, as specified in City Standard Specifications and these Special Provisions, and as directed by the Engineer.

Storm Water Pollution Prevention Plan (SWPPP) (7th Paragraph):

Measurement and payment for prepare SWPPP, as described herein, shall be made at the contract Lump Sum price stated in the proposal. Full compensation for all work involved in the preparation, completion, and revision, including submitting permit registration documents **and paying all fees**, will be considered as included in the lump sum price paid for prepare SWPPP.

Earthwork (6th Paragraph):

Roadway excavation will be measured and paid by the cubic yard and the volume is determined from the average end areas and the distance between them. *This item will be a final pay item.* See section 9-1.02C of the State Standard Specifications.

Full Depth Reclamation – Cement (4th Paragraph):

The cement content must be 5 percent by dry weight of FDR—cement with a dry unit weight of 4.4 lb/sf, except an increase or decrease in the cement content may be ordered based on your mix design. *The mix designs shall be submitted to and authorized by the Engineer prior to cold planning the AC pavement*. During progress of the work, if you encounter an isolated area that requires more cement than described in the mix design for that area, notify the Engineer before applying the cement.

Minor Concrete (8th Paragraph):

Prior to installation of all form work, you shall be required to notify the Engineer a minimum of 48 hours in advance of scheduled formwork activities. The Engineer shall review the survey results and determine if the preparation of the building pad area is in conformance with the project plans and specifications. You shall not proceed with installing formwork until after it is determined that the building pad area formwork is in conformance with the project plans and specifications. After formwork is in place and prior to pouring any concrete, you shall notify the Engineer a minimum of 48 hours in advance for a survey of form work. Upon completion of the survey, the Engineer may either approve or disapprove of the form work. You shall not proceed with pouring concrete until after the Engineer has certified that the area is in compliance with the project plans and specifications. You shall be required to correct this work in a manner acceptable to the Engineer if found to not be in conformance with the project plans and specifications at your expense.

Install Roadside Sign (1st and 2nd Paragraph):

Contractor shall install sign panels, sign posts and foundations in accordance with *City Standard ST-11 and ST-12* Stanislaus County Standard Plate No. 3-12 and these Special Provisions.

Sign panels must comply with the lates version of the California Uniform Traffic Control Devices (CA MUTCD) and **City** Stanislaus County Standard Plates. All signs shall be high intensity prismatic.

Item No. 6:

Delete sheets 1 (T-1), 6 (X-1), 12 (DM-5), 19 (L-1), 20 (L-2), 23 (L-5), 51 (CD-22), 59 (G-1), 60 (G-2), 63 (G-5), 67 (G-9), 69 (G-11), 70 (G-12), 71 (G-13), 72 (G-14), 73 (G-15), 79 (G-21), 81 (G-23), 82 (G-24), 83 (G-25), 84 (TH-1), 97 (TH-14), and 98 (TH-15).

Replace sheets with 1 (T-1), 6 (X-1), 12 (DM-5), 19 (L-1), 20 (L-2), 23 (L-5), 51 (CD-22), 59 (G-1), 60 (G-2), 63 (G-5), 67 (G-9), 69 (G-11), 70 (G-12), 71 (G-13), 72 (G-14), 73 (G-15), 79 (G-21), 81 (G-23), 82 (G-24), 83 (G-25), 84 (TH-1), 97 (TH-14), and 98 (TH-15) attached to this addendum.

Revisions consist of extending reconstruction of curb, gutter, 1 driveway and 2 pathways along El Capitan Dr. from STA 30+85 to 32+75, additional Traffic Handling Sheets for roadway segments not previously shown, and minor callout corrections.

End of Addendum No. 1

BIDDING FORM

Ci	ty of Turlock is hereinafter called the Owner.
ΒI	DDER:
Ca Pa	he work to be done and referred to herein is in City of Turlock and in Stanislaus County, State of lifornia. It is shown on a set of Plans, entitled: Roads Program Capital Improvement Project Planckage 2 and is to be constructed in accordance with the Project Specifications and contract documents ached hereto by reference.
In	submitting this Bid, Bidder represents, as set forth in the Agreement, that:
A.	Bidder has examined and carefully studied the Bidding Documents, the other related data identified in the Bidding Documents and the following Addenda, receipt of all which is hereby acknowledged.
	Addendum No. Addendum Date

B. Bidder has visited the Site and became familiar with and is satisfied as to the general, local, and Site conditions that may affect cost, progress, and performance of the Work.

The undersigned, as Bidder, declares that the only persons, or parties interested in this proposal as principals are those named herein, that this proposal is made without collusion with any other person, firm or corporation; that he has carefully examined the location of the proposed work, the Plans and Specifications referred to, the referenced proposed contract, and the Bidder proposes and agrees that, if this proposal is accepted, he will contract with the Owner to provide all necessary machinery, tools, apparatus and other means of construction, and to do all the work and furnish all the materials specified in the contract in the manner and time therein prescribed, and according to the requirements as therein set forth, and that he will take in full payment therefor the following unit prices as set forth in the Bid Schedule below.

CITY OF TURLOCK

Project No. 23-031 Roads Program Capital Improvement Project Plan Package 2

BID SCHEDULE

Item	Description	Quantity	Unit	Unit Price	Total		
	General						
1.	Potholes Existing Utilities	1	LS	\$	\$		
2.	Construction Funding Signs	6	EA	\$	\$		
3.	Traffic Control System	1	LS	\$	\$		
4.	Portable Changeable Message Sign	4	EA	\$	\$		
5.	Job Site Management	1	LS	\$	\$		
6.	Prepare Storm Water Pollution Prevention Plan	1	LS	\$	\$		
7.	Erosion and Dust Control BMPs	1	LS	\$	\$		
8.	Construction Staking	1	LS	\$	\$		
9.	Remove Concrete (Flatwork)	980	SY	\$	\$		
10.	Remove Concrete (Curb)	1870	LF	\$	\$		
11.	Remove Concrete (Curb and Gutter)	4260	LF	\$	\$		
12.	Remove Concrete (Pathway)	445	SF	\$	\$		
13.	Clearing and Grubbing	1	LS	\$	\$		
14.	Remove Tree	3	EA	\$	\$		
15.	Roadway Excavation (F)	610	CY	\$	\$		
16.	12" Reinforced Concrete Pipe	22	LF	\$	\$		

Item	Description	Quantity	Unit	Unit Price	Total
17.	Full Depth Reclamation - Cement	42200	SY	\$	\$
18.	Cement (Full Depth Reclamation - Cement)	840	TON	\$	\$
19.	Mix Design (Full Depth Reclamation - Cement)	1	LS	\$	\$
20.	Hot Mix Asphalt (Type A)	10580	TON	\$	\$
21.	Cold Planing AC Pavement	42200	SY	\$	\$
22.	Install Drainage Inlet	1	EA	\$	\$
23.	48" Precast Concrete Manhole	1	EA	\$	\$
24.	Minor Concrete (Curb and Gutter)	6200	LF	\$	\$
25.	Minor Concrete (Curb Ramp)	1070	SF	\$	\$
26.	Minor Concrete (Sidewalk)	3510	SF	\$	\$
27.	Minor Concrete (Pathway)	445	SF	\$	\$
28.	Minor Concrete (Alley)	1560	SF	\$	\$
29.	Minor Concrete (Valley Gutter)	3460	SF	\$	\$
30.	Minor Concrete (Driveway)	5045	SF	\$	\$
31.	Detectable Warning Surface (Truncated Domes)	240	SF	\$	\$
32.	Adjust Drainage Inlet to Grade	19	EA	\$	\$
33.	Adjust Manhole Frame and Cover (Utility)	19	EA	\$	\$
34.	Remove and Replace Monument	7	EA	\$	\$
35.	Adjust Frame and Cover to Grade	36	EA	\$	\$
36.	Remove Roadside Sign	7	EA	\$	\$
37.	Roadside Sign - One Post	22	EA	\$	\$
38.	Thermoplastic Traffic Stripe	4740	LF	\$	\$

Item	Description	Quantity	Unit	Unit Price	Total
39.	Thermoplastic Pavement Markings	2605	SF	\$	\$
40.	Mobilization	1	LS	\$	\$
				TOTAL BID	\$

(F) Denotes I	Final Pay Item Per Sec	ction 9-1.02C of The	State Standard Specifi	cations.
COMPANY'S	S NAME:			
BY:				
ADDRESS: _				
_	(Number)		(Street)	
	(City)	(State)	((ZIP)
CONTRACT	OR'S PHONE #:			
EXPIRATIO SIGNED BY ABOVE ITE	ON DATE, AND A Y INDIVIDUAL A	PPROPRIATE STA UTHORIZED TO AID CONTRACTO	ATEMENT REGARI	LICENSE NUMBER, DING PERJURY AND E TO INCLUDE THE JECTED.
(Company's I		, Cor	ntractor's License #	, Class
Expires		DIR #:		
	tion is true, is provide n under penalty of pe		28.15 of the Business a	nd Professions Code, and
X				

If the proposal is accepted and the undersigned shall fail to contract as aforesaid and fail to file with the City insurance certificates as required by said contract, within fourteen (14) days after the bidder has received notice from the City Engineer or his representative of the City of Turlock that the contract has

(Bidder's Signature)

(Date)

been awarded to bidder and is ready for signature, the City of Turlock may, at its option, determine that the bidder has abandoned his contract, and thereupon this proposal and the acceptance thereof shall be null and void.

Also accompanying this proposal is an affidavit of non collusion and questionnaire to general contractors, a statement of proposed sub-contractors, if any, the address of mill, shop or office of any sub-contractor, and a statement of work to be performed by sub-contractors.

The names and addresses of persons interested in the foregoing proposal as principals are as follows:

(IMPORTANT NOTICE: If bidder or other interested person is a corporation, state legal name of corporation, also names of the president, secretary, treasurer, and manager thereof; if a partnership, state true name of firm, also names of all individual co partners composing firm; if bidder or other interested person is an individual, state first and last name in full.)

Licensed in ac	cordance with an act providing for the registration of Contractors,
License No	Expiration Date
	•
DATED:	
	, <u> </u>
Address:	
Phone:	
- · · · · · · · · · · · · · · · · · · ·	
	X
	Signature of Bidder
	of Didder

NOTE: If bidder is a corporation, the legal name of the corporation shall be set forth above together with the signature of the officers authorized to sign contracts on behalf of the corporation; if bidder is a co partnership, the true name of the firm shall be set forth above together with the signature of the partner or partners authorized to sign contracts in behalf of the co partnership; and, if bidder is an individual, his signature shall be placed above. If a signature is by an agent other than an officer of a corporation or a member of the partnership, a Power of Attorney must be on file with the City Clerk prior to opening or submitted with the bid; otherwise, the bid will be disregarded as irregular and unauthorized.

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CITY OF TURLOCK

CONSTRUCTION PLANS FOR

ROADS PROGRAM CAPITAL IMPROVEMENT PROJECT

CITY PROJECT NO. 23-031

PLAN PACKAGE 2

EL CAPITAN DR: N BERKELEY AVE TO MURPHY DR

KENNETH DR: N BERKELEY AVE TO EAST END

EL CAMINO DR: EL PASEO DR TO N JOHNSON RD N JOHNSON RD TO MURPHY DR

LA LINDA CT: EL CAPITAN DR TO EL CAPITAN DR

N QUINCY RD: E CANAL DR TO MARIE DR

MURPHY DR: E CANAL DR TO MIRA FLORES DR

LA SOMBRA CT

EL CAPITAN DR

EL CAMINO DR

EAST CANAL DR

SUPPLEMENTED BY CALTRANS STANDARD PLANS AND STANDARD SPECIFICATIONS DATED 2023 & CITY OF TURLOCK ENGINEERING DESIGN STANDARD SPECIFICATIONS AND DRAWINGS DATED

SHEET INDEX

SHEET	DRAWING	TITLE
1	T-1	TITLE SHEET
2-3	GN-1 TO GN-2	GENERAL NOTES
4	PC-1	PROJECT CONTROL
5	K-1	KEY MAP
6-7	X-1 TO X-2	TYPICAL SECTION
8-18	DM-1 TO DM-11	DEMOLITION PLANS
19-29	L-1 TO L-11	LAYOUTS
30-58	CD-1 TO CD-29	CONSTRUCTION DETAILS
59-83	G-1 TO G-25	GRADING PLANS
84-98	TH-1 TO TH-15	TRAFFIC HANDLING PLANS
99-109	SS-1 TO SS-11	SIGNING AND STRIPING




CITY OF TURLOCK APPROVAL

WILLIAM D. MORRIS, P.E., P.L.S CITY ENGINEER	DATE
PUBLIC WORKS DEPARTMENT	

UTILITY CONTACTS

UTILITY	CONTACT	PHONE
AT&T	JIM JELLEY	(209) 507-1689
CHARTER COMMUNICATIONS	MITCHELL RODRIQUEZ	(408) 612-7569
TID ELECTRICAL	DAVID PORATH	(209) 605-0945
TID IRRIGATION	TODD TROGLIN	(209) 535-1882
CITY OF TURLOCK ELETRICAL	DOYLE PERRY	(209) 678-5823
CITY OF TURLOCK STORM AND SEWER	CARLOS GUERRERO	(209) 345-2169
CITY OF TURLOCK WATER	ORLANDO GUITERREZ	(209) 740-3868
PG&E	TRENT MILLSAP	(209) 561-6070

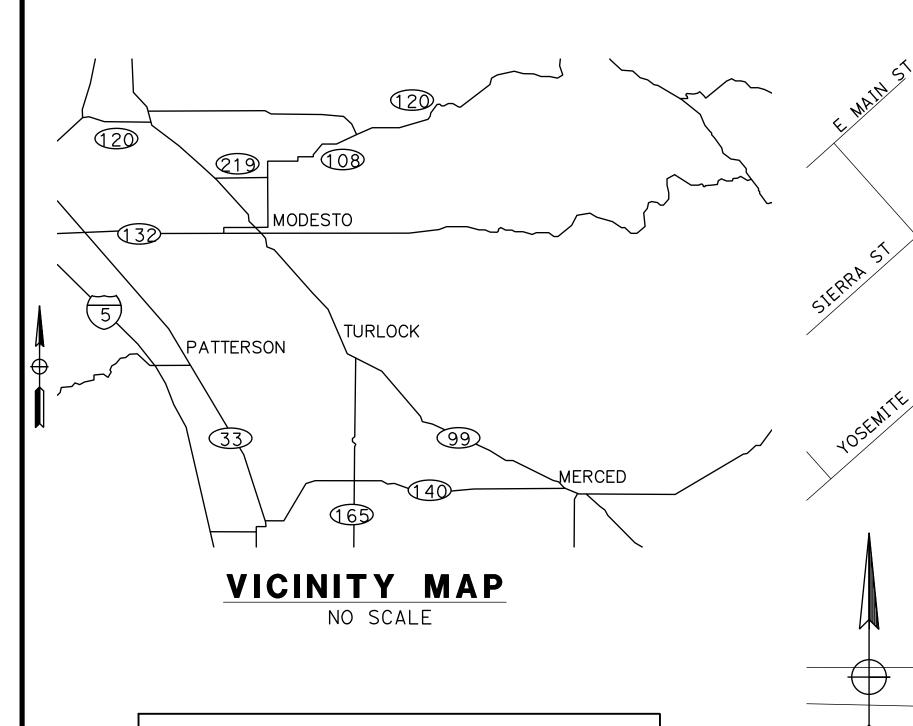

CALIFORNIA STATE MAP

NO SCALE

CITY OF TURLOCK

CALL BEFORE YOU DIG

THE CONTRACTOR SHALL CALL "UNDERGROUND SERVICE ALERT" (USA) AT 811 AT LEAST 2 WORKING DAYS PRIOR TO PERFORMING ANY EXCAVATION

PROJECT LOCATION MAP

LINDA VISTA ST

MIRA FLORES DR

LA LINDA CT


EL CAMINO DR

DESIGNED BY: ANGEL P. ANGEL P.

ALL REFERENCES AND WRITTEN DIMENSIONS SHALL SUPERCEDE ALL SCALED DISTANCES AND SHALL BE VERIFIED IN THE FIELD. ANY CHECKED BY: JON H. SCALE: AS SHOWN DISCREPANCY SHALL BE BROUGHT TO DATE: 4/2/2024 THE ATTENTION OF THE ENGINEER JOB NO.: 23-00109 PRIOR TO THE COMMENCEMENT OF WORK.



KENNETH DR

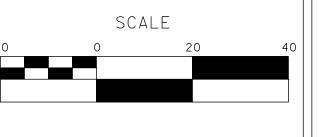






701 UNIVERSITY AVENUE, SUITE 200 SACRAMENTO, CALIFORNIÁ 95825 (916) 381-9100 FAX:(916)381-9180 markthomas.com

MARIE DR



CITY OF TURLOCK **ROADS PROGRAM - CIP**

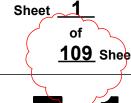

TITLE

109 Sheets

- 1. FOR COMPLETE RIGHT OF WAY AND ACCURATE ACCESS DATA SEE RIGHT OF WAY RECORD MAPS AT CITY OF TURLOCK OFFICE.
- 2. DIMENSIONS OF THE STRUCTURAL SECTIONS ARE SUBJECT TO TOLERANCES SPECIFIED IN THE STANDARD SPECIFICATIONS.
- 3. SUBGRADE CROSS SLOPE TO BE THE SAME AS TYPICAL SURFACE CROSS SLOPE UNLESS OTHERWISE NOTED.
- 4. FOR LOCATIONS OF PAVEMENT REHABILITATION, SEE LAYOUT SHEETS
- 5. CONSTRUCT 6" CURB AND GUTTER PER CITY STD C-1. FOR LOCATIONS AND LIMITS OF CURB AND GUTTER REPLACEMENT, SEE LAYOUT SHEETS
- 6. CONSTRUCT CONCRETE SIDEWALK PER CITY STD C-3. FOR LOCATIONS AND LIMITS OF SIDEWALK REPLACEMENT, SEE LAYOUT SHEETS
- 7. PAVEMENT SHALL BE REPLACED AS SHOWN. CROSS SLOPE OF PAVEMENT SHALL MAINTAIN POSITIVE DRAINAGE. THERE SHALL BE NO LOW POINTS COLLECTING SURFACE RUNOFF.
- 8. EXISTING CURB, GUTTER, SIDEWALK, AND DRIVEWAY SHALL BE PROTECTED IN PLACE, UNLESS OTHERWISE NOTED ON THE PLANS.
- 9. DIMENSIONS SHOWN IN TYPICAL SECTIONS ARE APPROXIMATE. CONTRACTOR TO VERIFY DIMENSIONS WITH THE ENGINEER IN THE FIELD.
- 10. REMOVAL OF EXISTING PAVEMENT INCLUDES ASPHALT, AGGREGATE BASE, AND SUB BASE AS NECESSARY TO ACHIEVE REQUIRED REMOVAL DEPTH.
- 11. WHERE THE ENTIRE EXISTING ASPHALT LAYER IS REMOVED, COMPACT AND PREPARE BASE/SUBGRADE PRIOR TO PLACING HMA.
- 12. SEE PLANS FOR PROPOSED PAVEMENT TREATMENT WITHIN INTERSECTION GRADING LIMITS, WHERE APPLICABLE.

DESIGN DESIGNATION:

R-VALUE = 50 - N QUINCY RD

50 - EL CAPITAN DR EAST OF N JOHNSON RD

50 - EL CAPITAN DR WEST OF N JOHNSON RD

50 - LA LINDA CT

50 - KENNETH DR

50 - EL CAMINO DR

50 - EL CAMINO DR EAST OF N QUINCY DR

50 - MURPHY DR

TI-VALUE = 8 - N QUINCY RD

8 - EL CAPITAN DR EAST OF N JOHNSON RD


8 - EL CAPITAN DR WEST OF N JOHNSON RD

7 - LA LINDA CT 7 - KENNETH DR

7 - EL CAMINO DR

7 - EL CAMINO DR EAST OF N QUINCY DR


7 - MURPHY DR

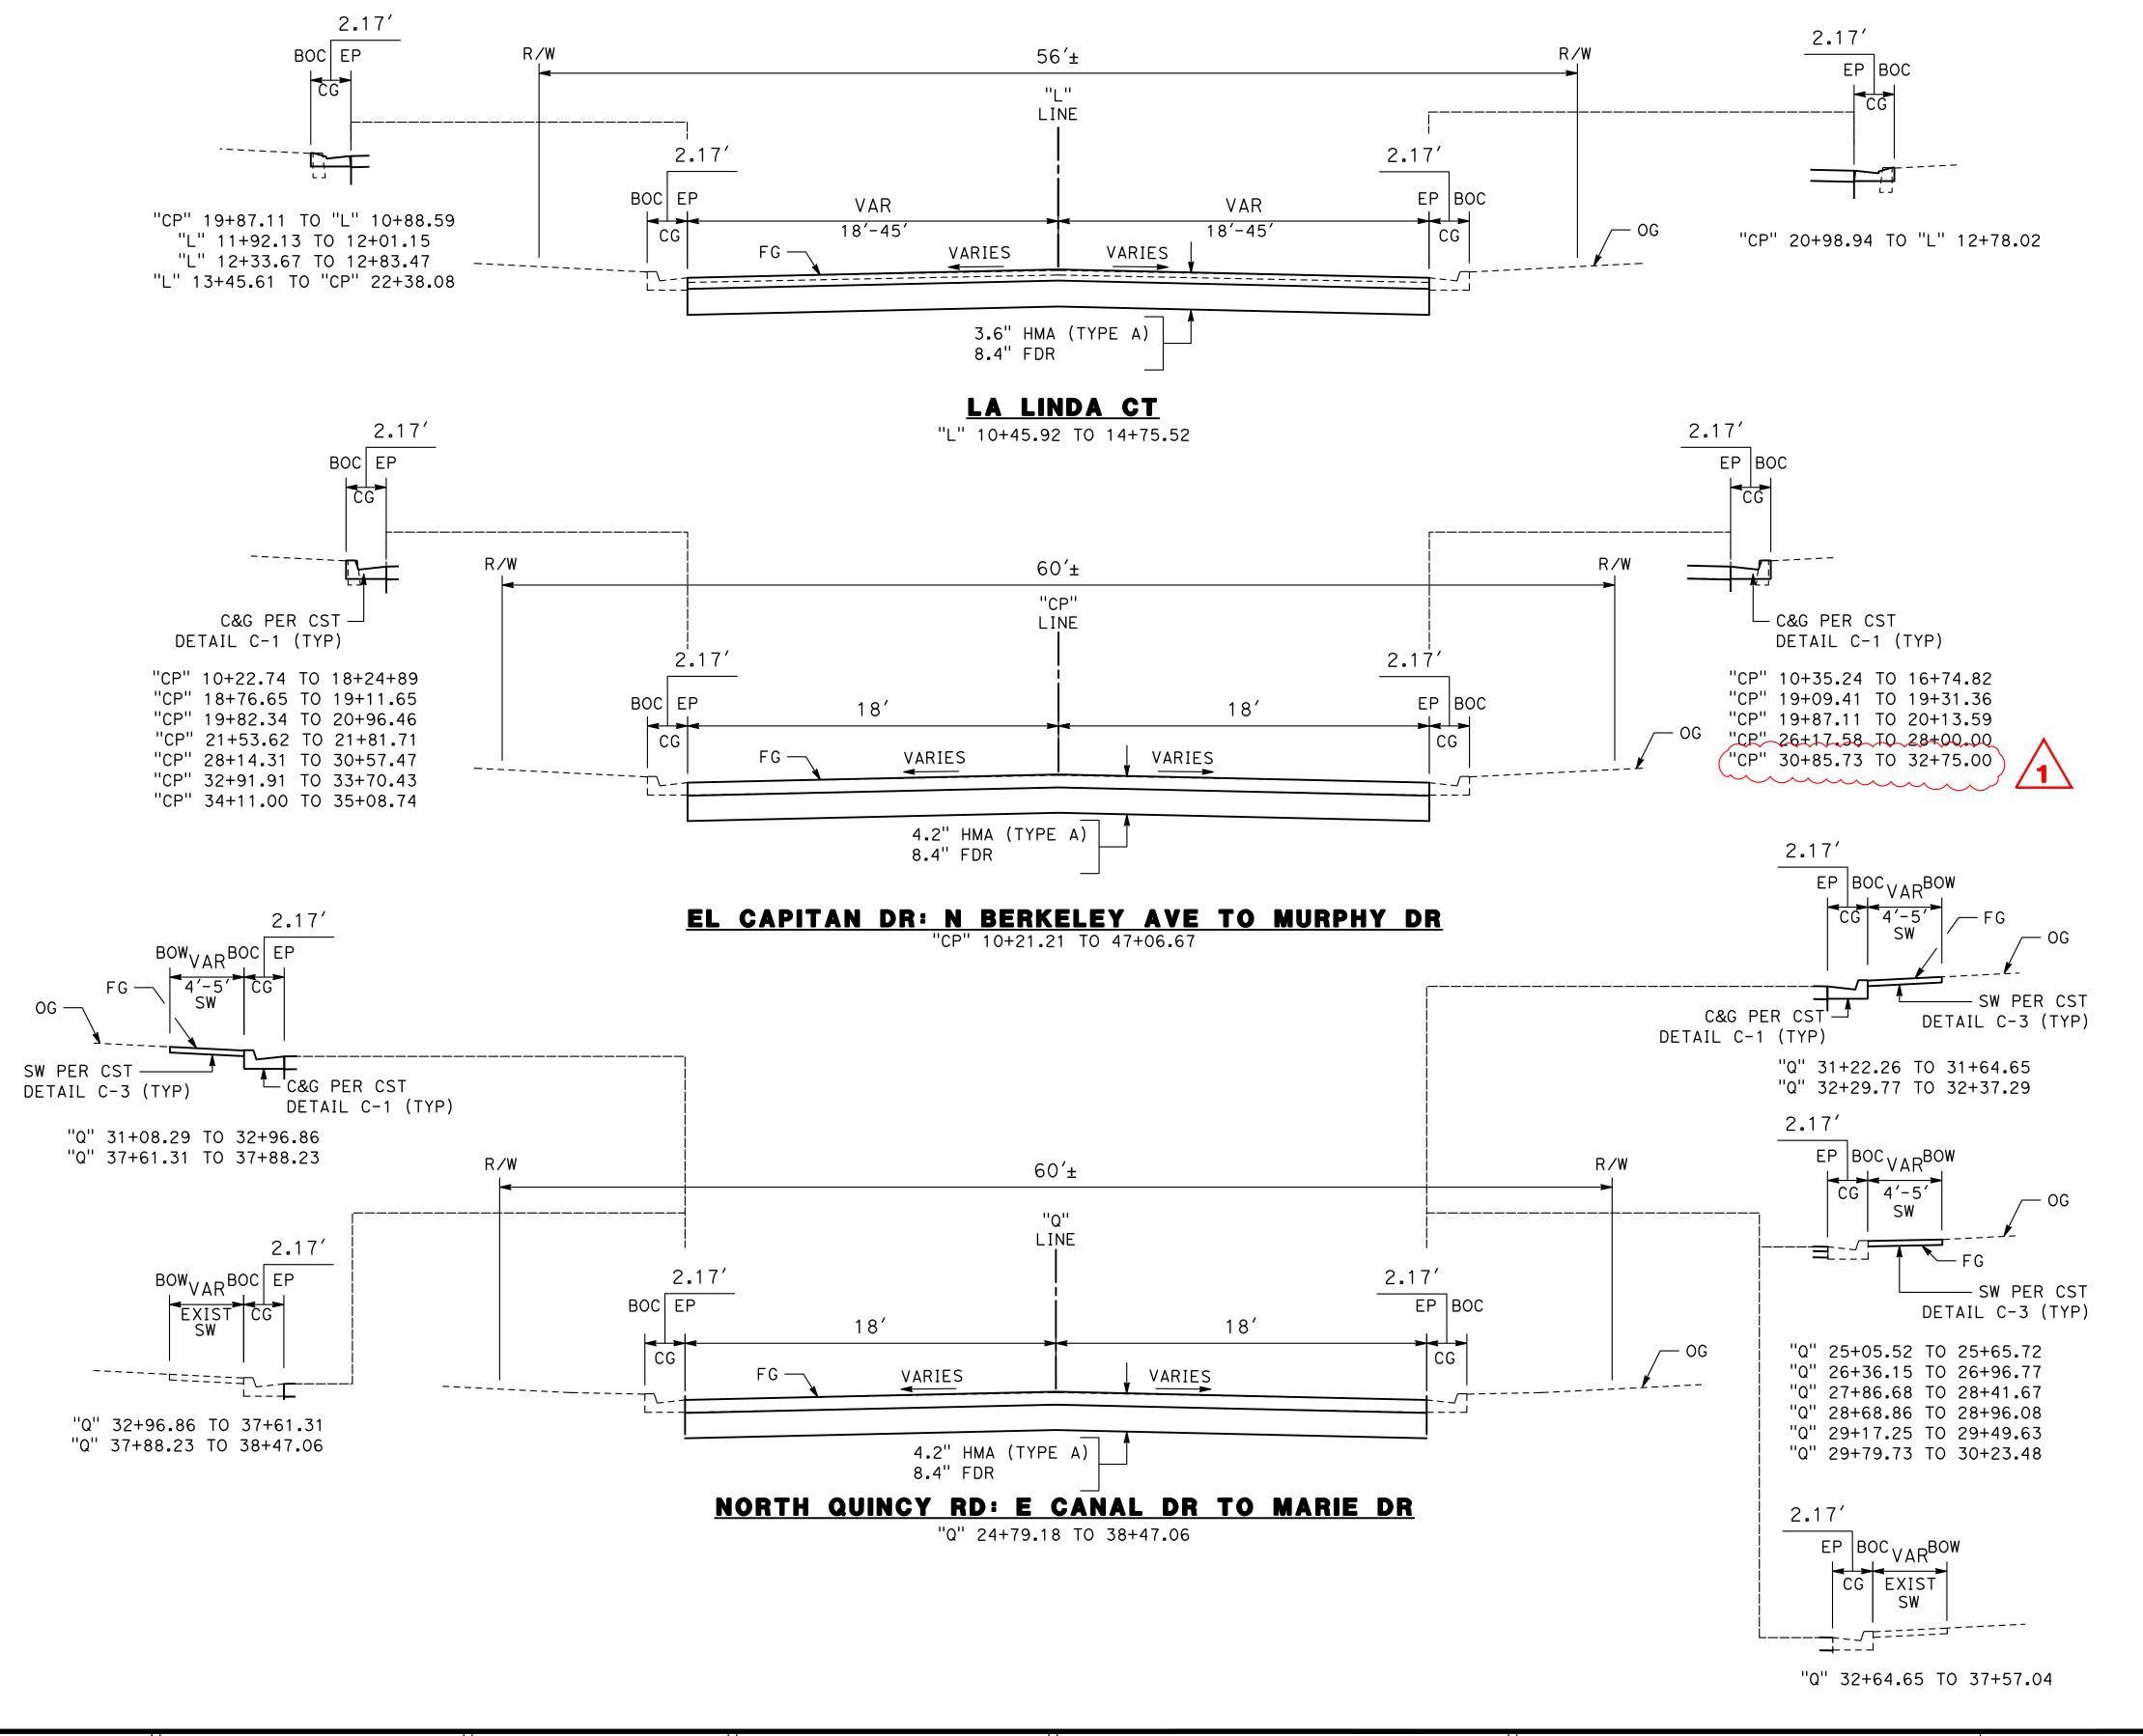

DESIGNED BY: ANGEL P. ANGEL P. DRAWN BY: CHECKED BY: JON H. SCALE: AS SHOWN

ALL REFERENCES AND WRITTEN DIMENSIONS SHALL SUPERCEDE ALL SCALED DISTANCES AND SHALL BE VERIFIED IN THE FIELD. ANY DISCREPANCY SHALL BE BROUGHT TO DATE: 4/2/2024 THE ATTENTION OF THE ENGINEER JOB NO.: 23-00109 PRIOR TO THE COMMENCEMENT OF WORK.



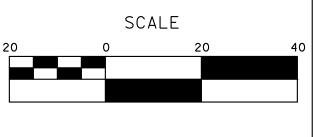



► MARK ■ ■ THOMAS


CITY OF TURLOCK PUBLIC WORKS DEPARTMENT ENGINEERING DIVISION 701 UNIVERSITY AVENUE, SUITE 200 156 S. BROADWAY SUIT 150 SACRAMENTO, CALIFORNIA 95825 (209) 668-5520 (916) 381-9100 FAX:(916)381-9180 markthomas.com




CITY OF TURLOCK ROADS PROGRAM - CIP TYPICAL CROSS SECTIONS

Sheet <u>6</u> of 109 Sheets


X-1

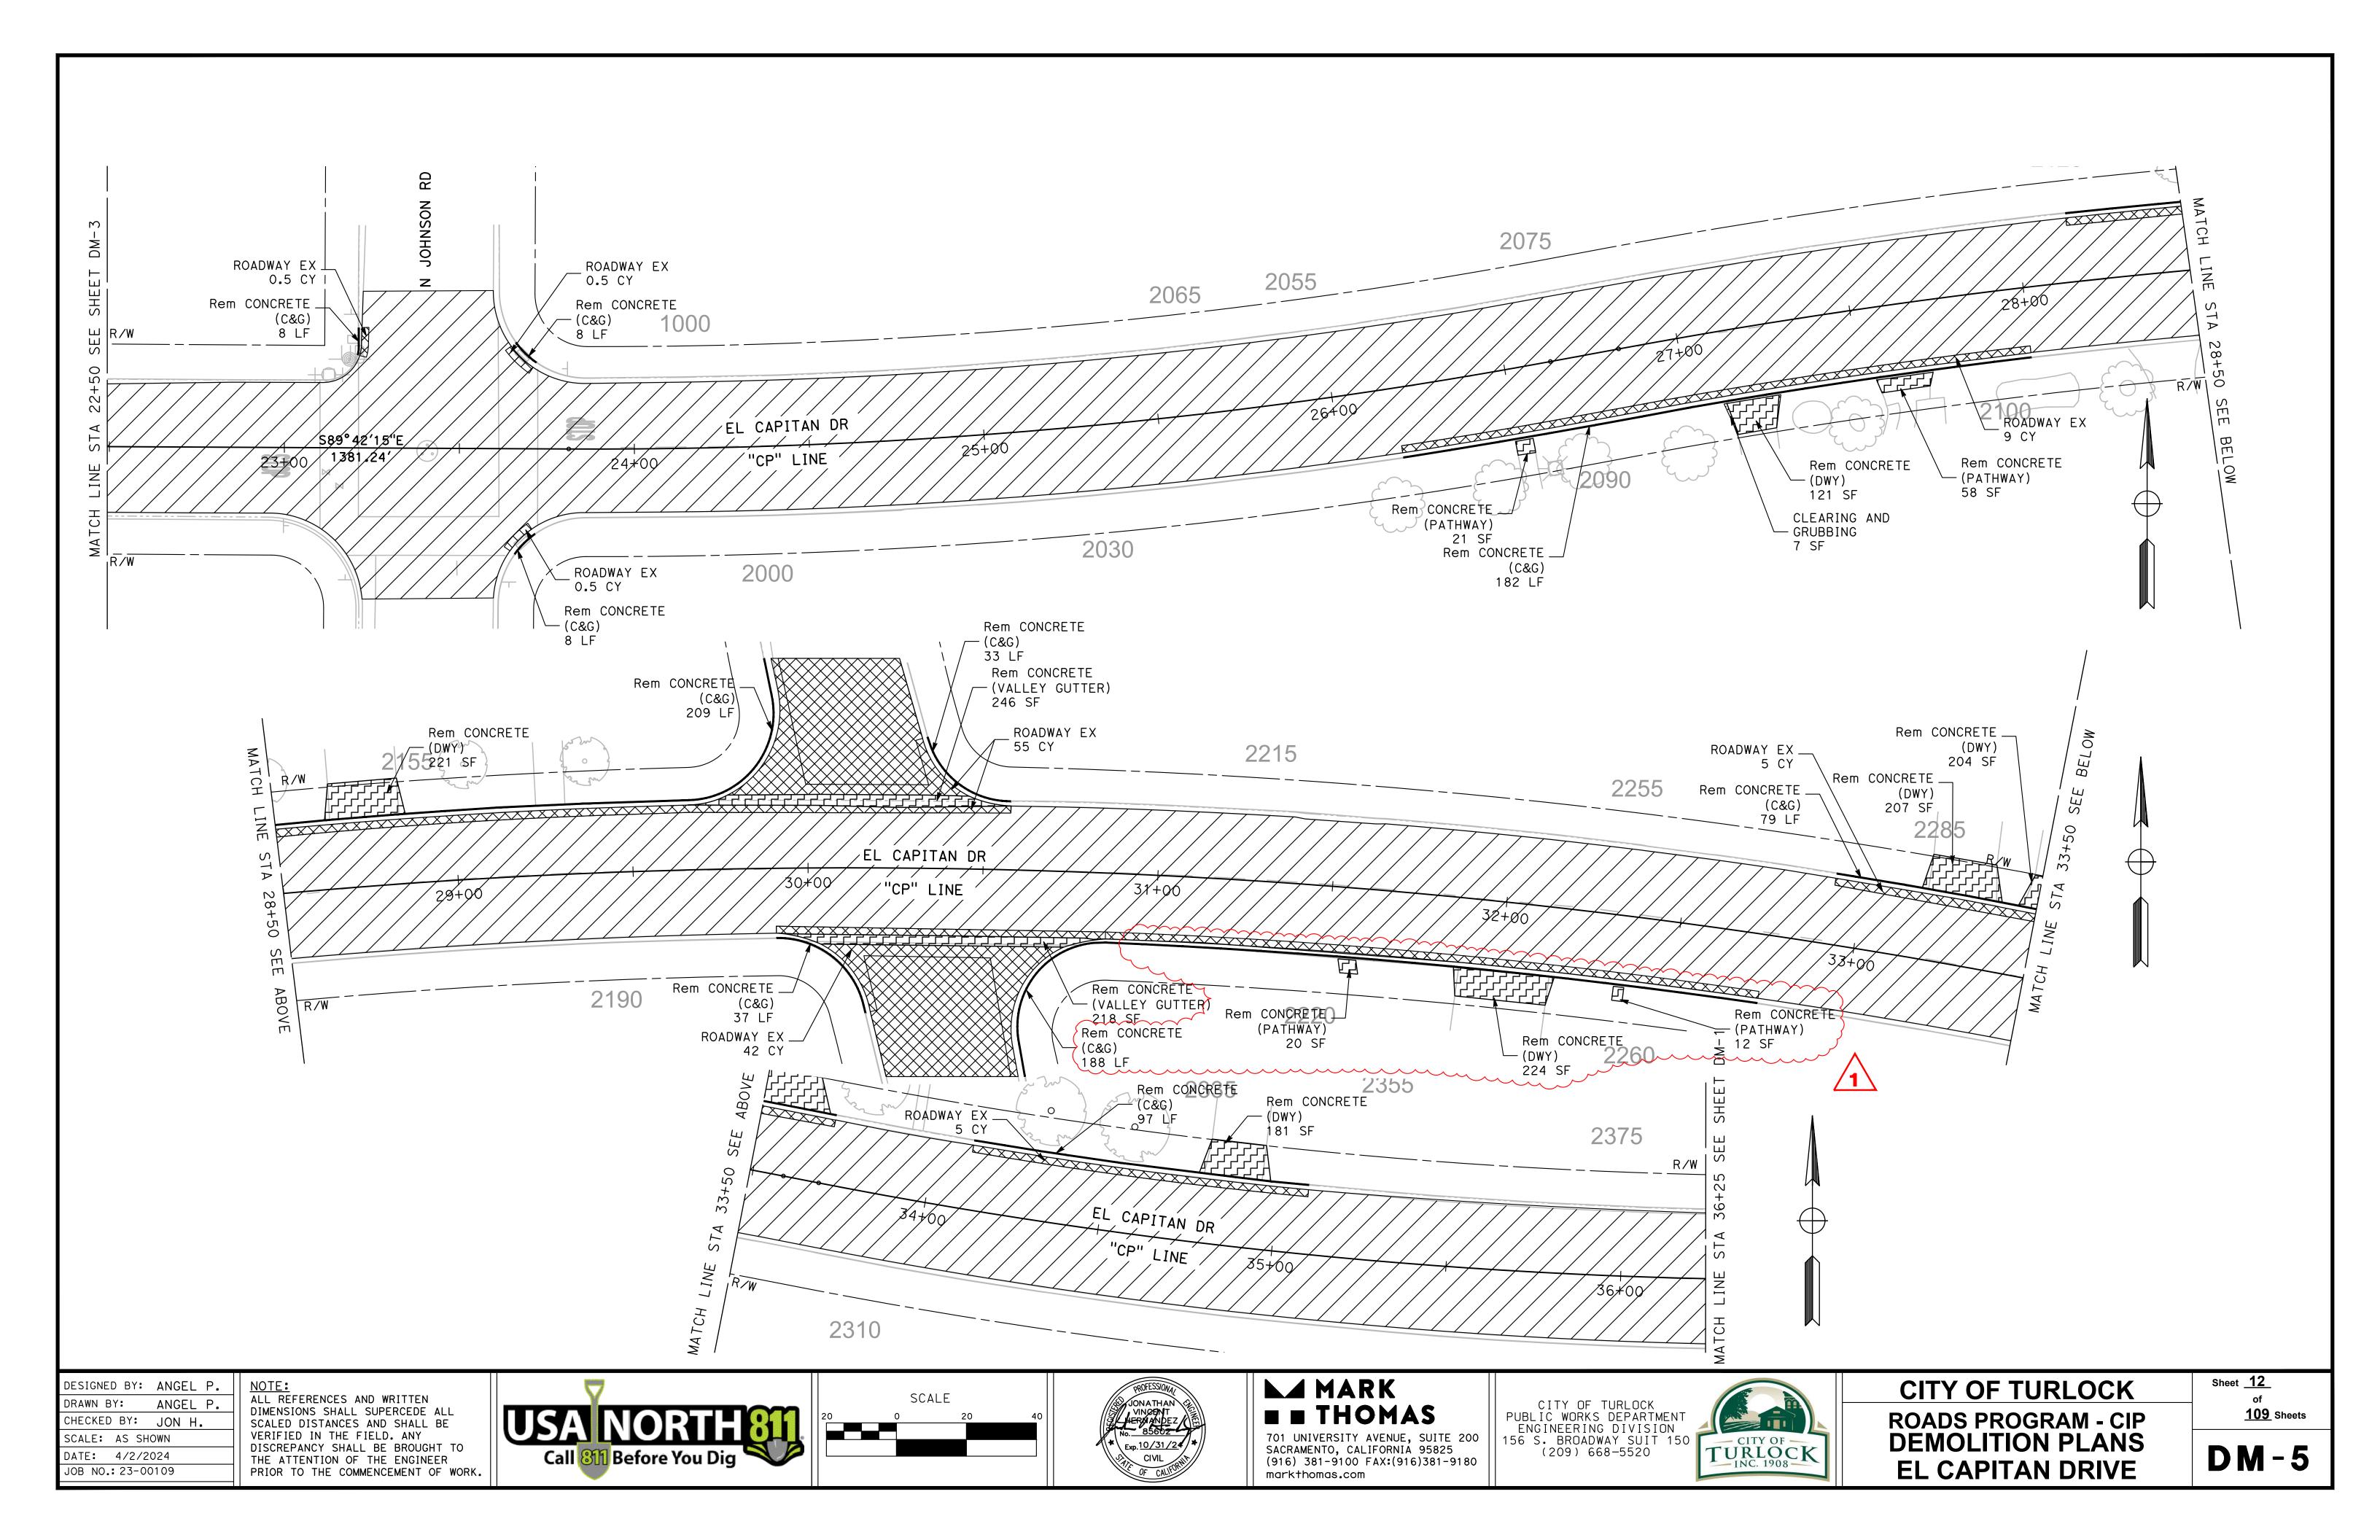

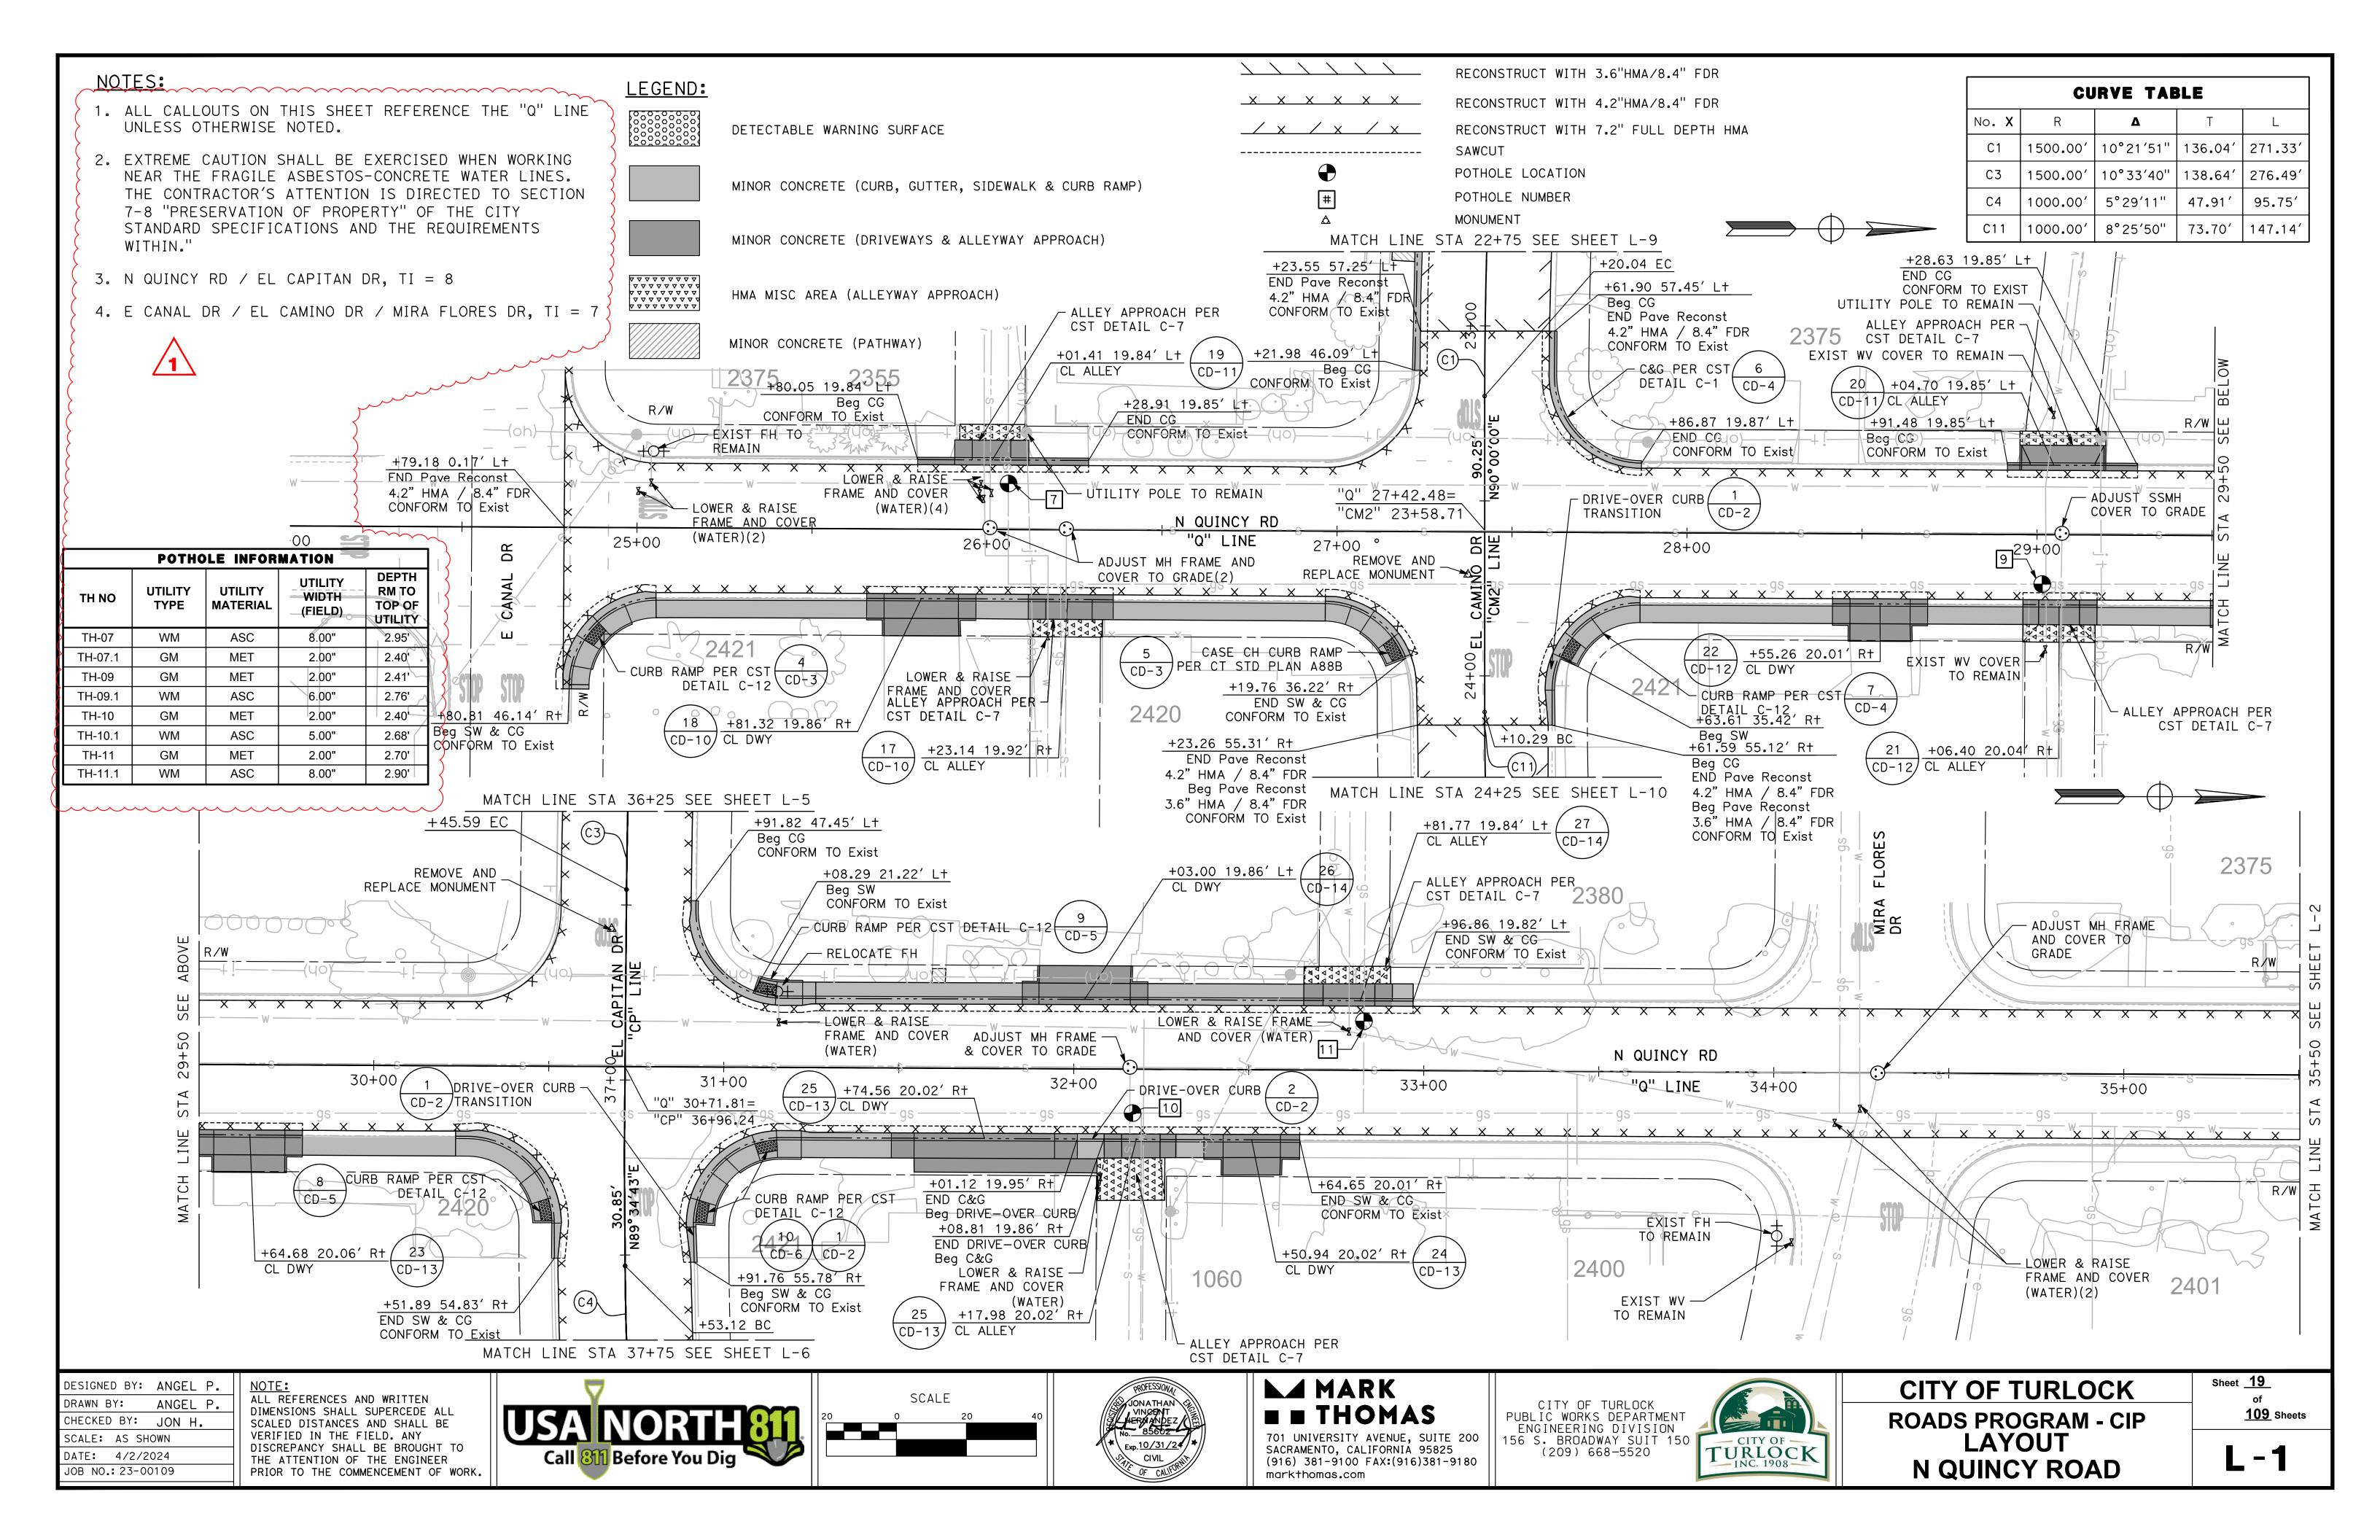

ALL CALLOUTS ON THIS SHEET REFERENCE THE "Q" LINE UNLESS OTHERWISE NOTED.

SEE LEGEND ON SHEET L-1

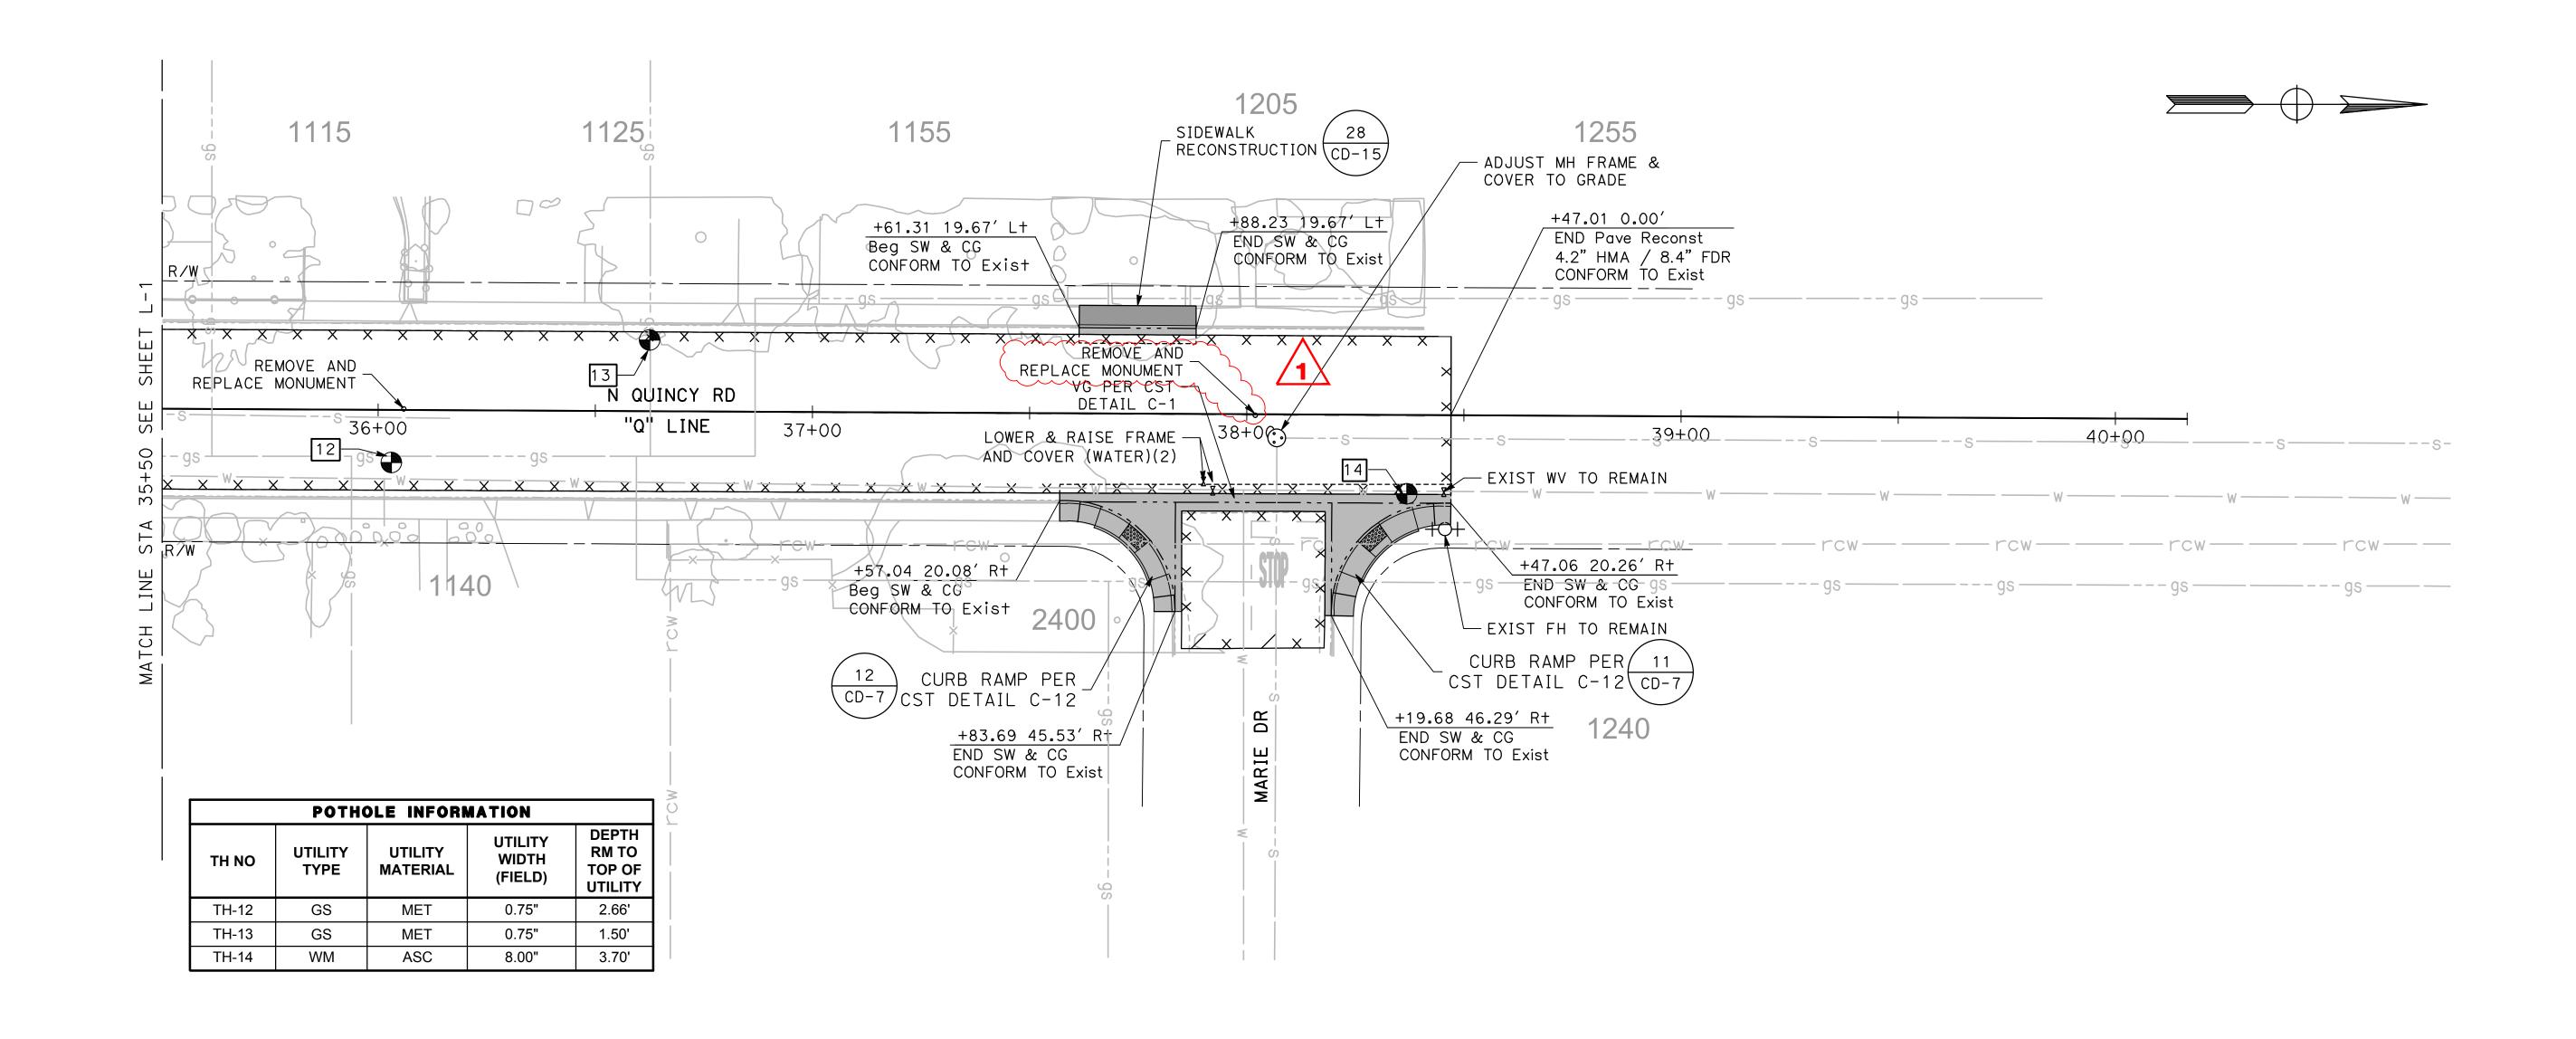


DESIGNED BY:	ANGEL P.
DRAWN BY:	ANGEL P.
CHECKED BY:	JON H.
SCALE: AS SH	OWN
DATE: 4/2/2	024

JOB NO.: 23-00109

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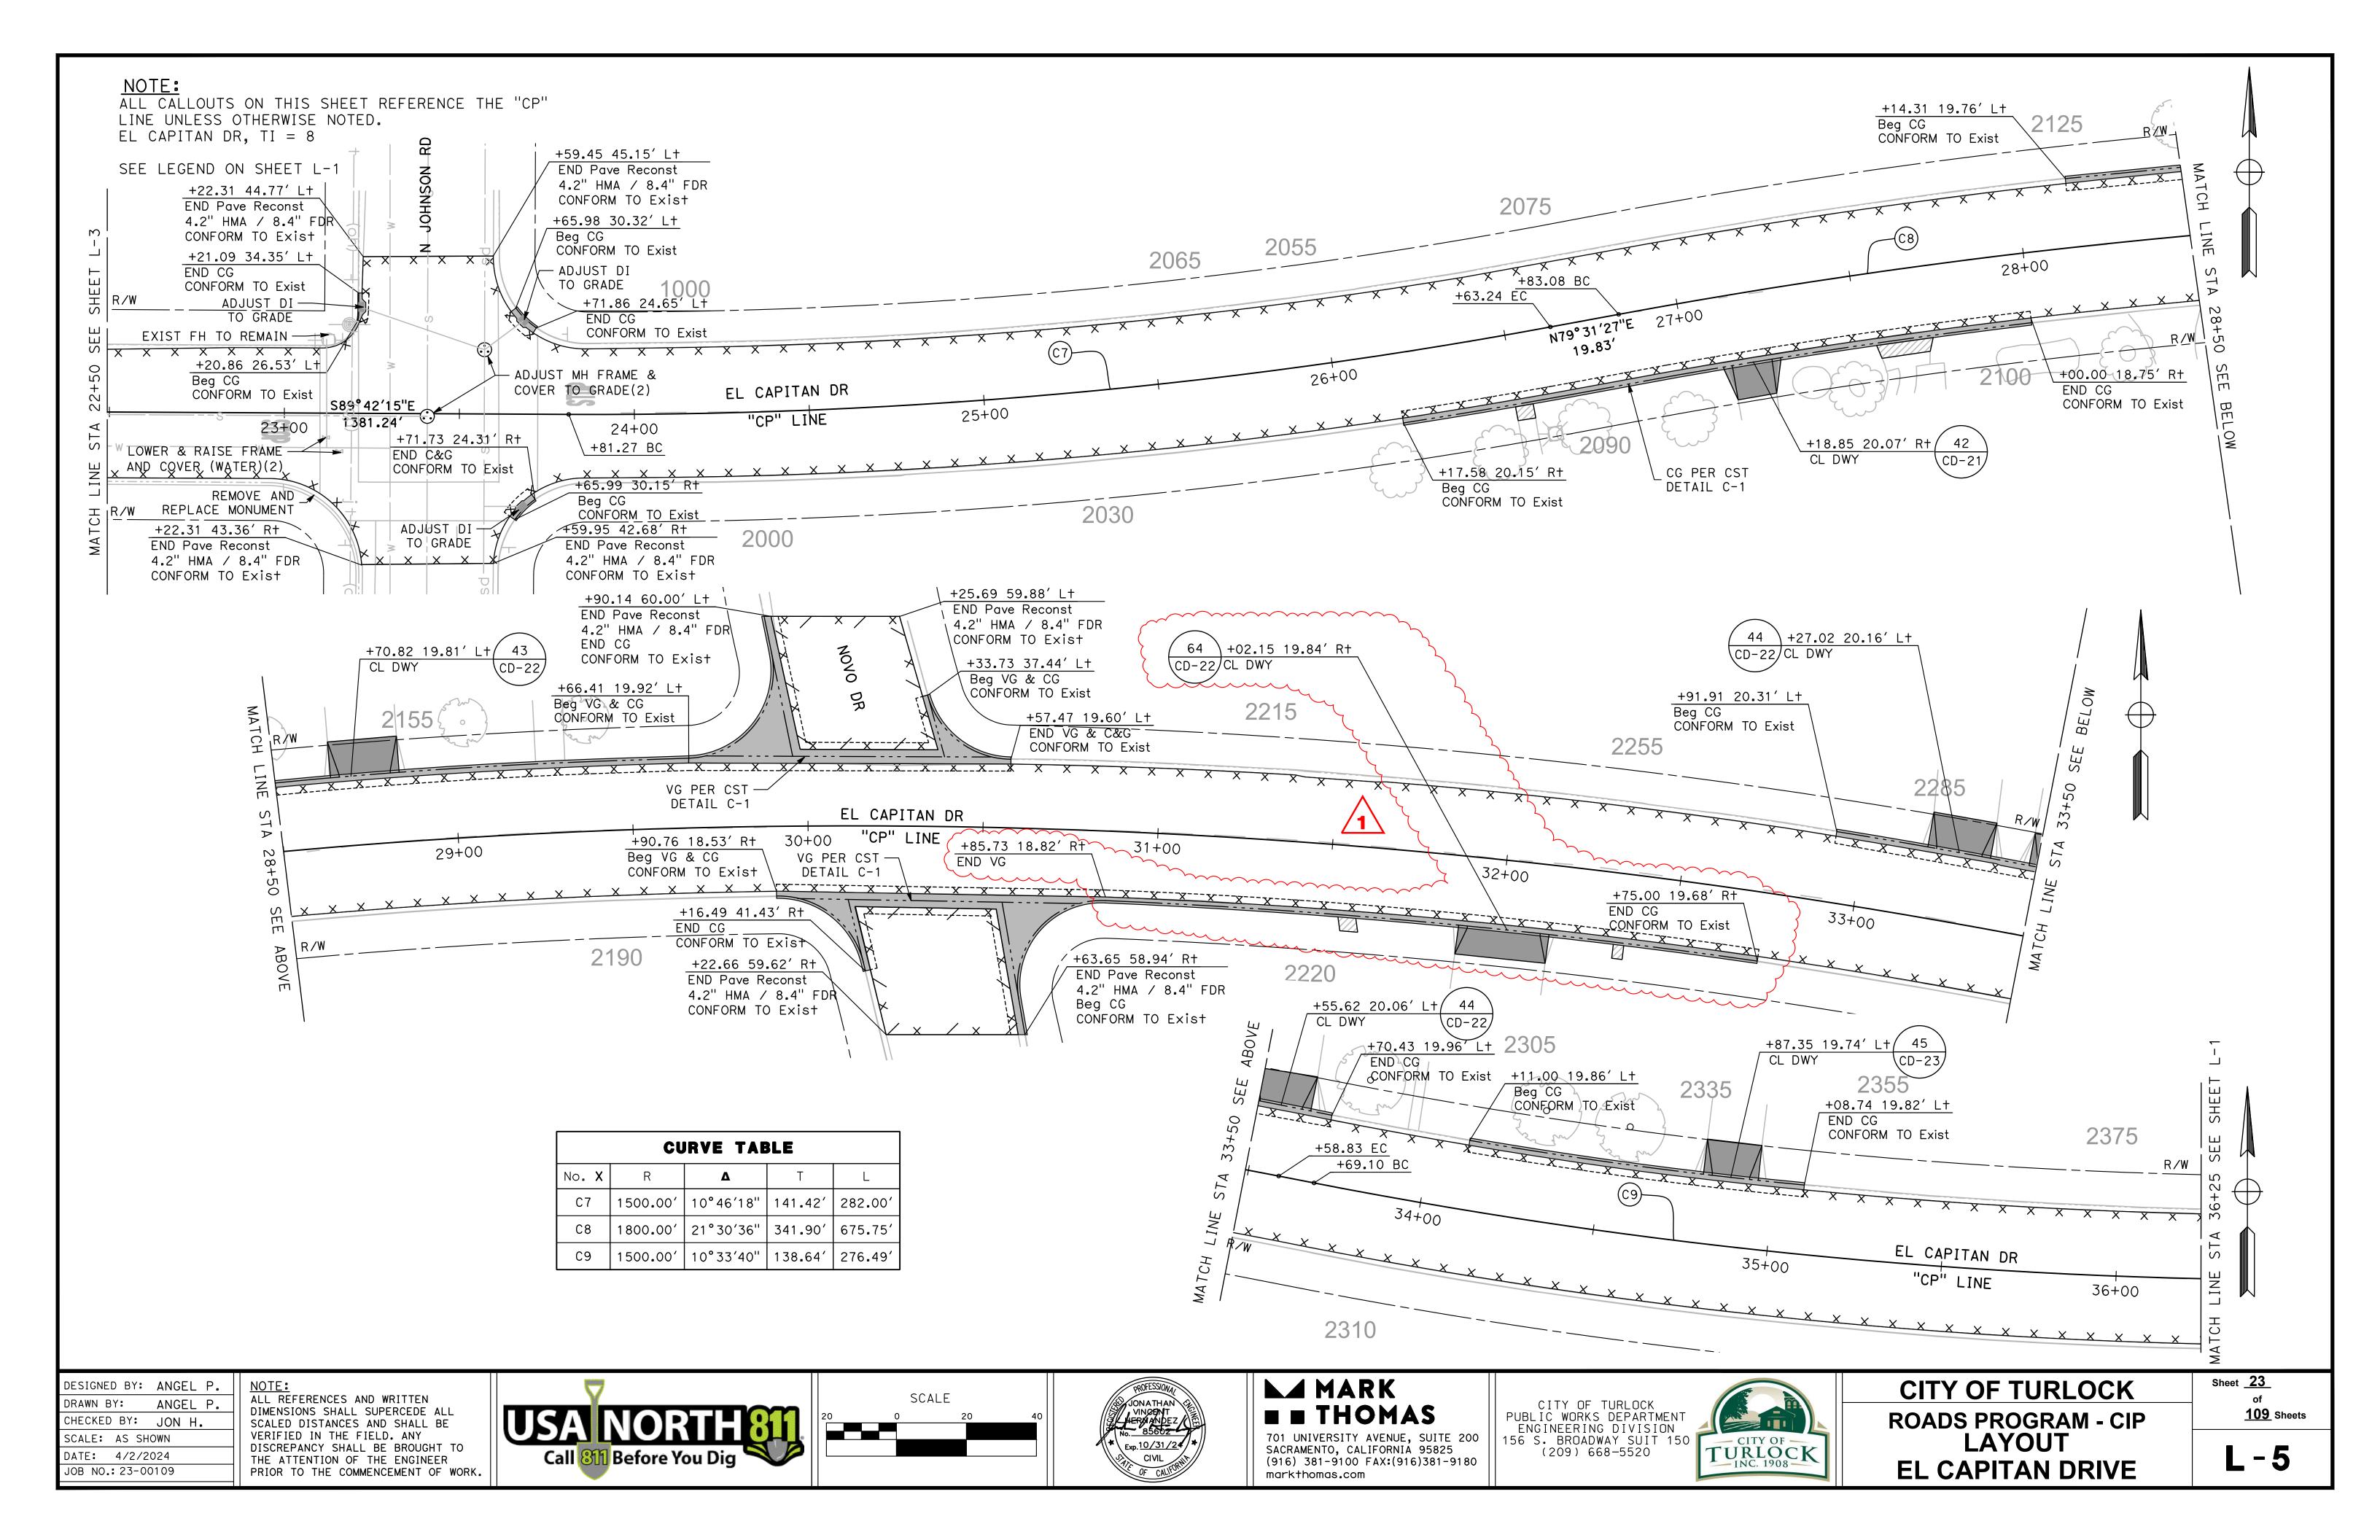



(209) 668-5520

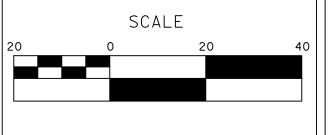
CITY OF TURLOCK ROADS PROGRAM - CIP LAYOUT N QUINCY ROAD

Sheet <u>**20**</u> of **109** Sheets

L-2



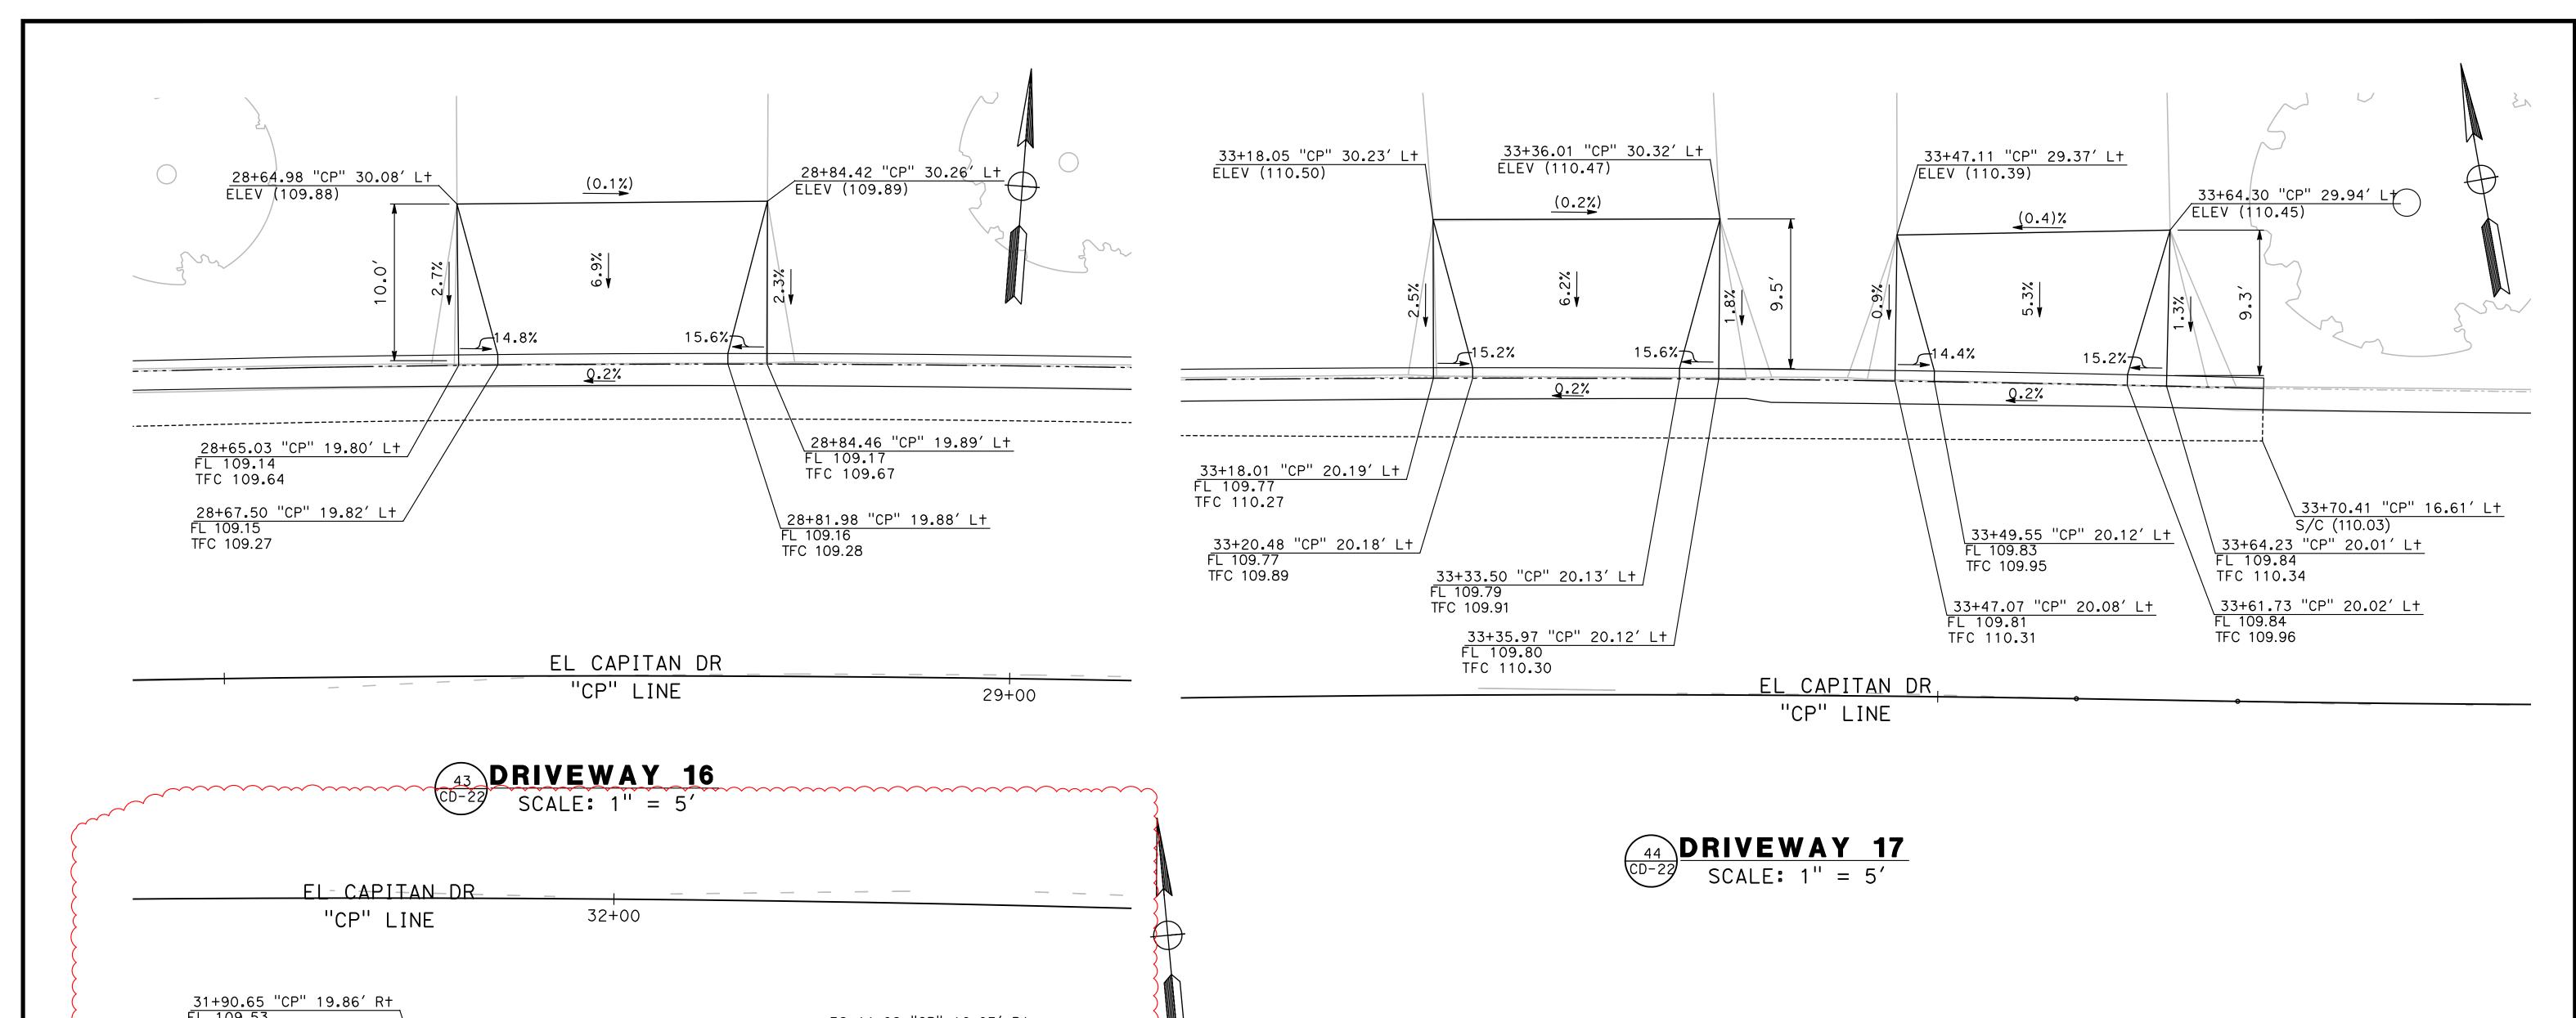

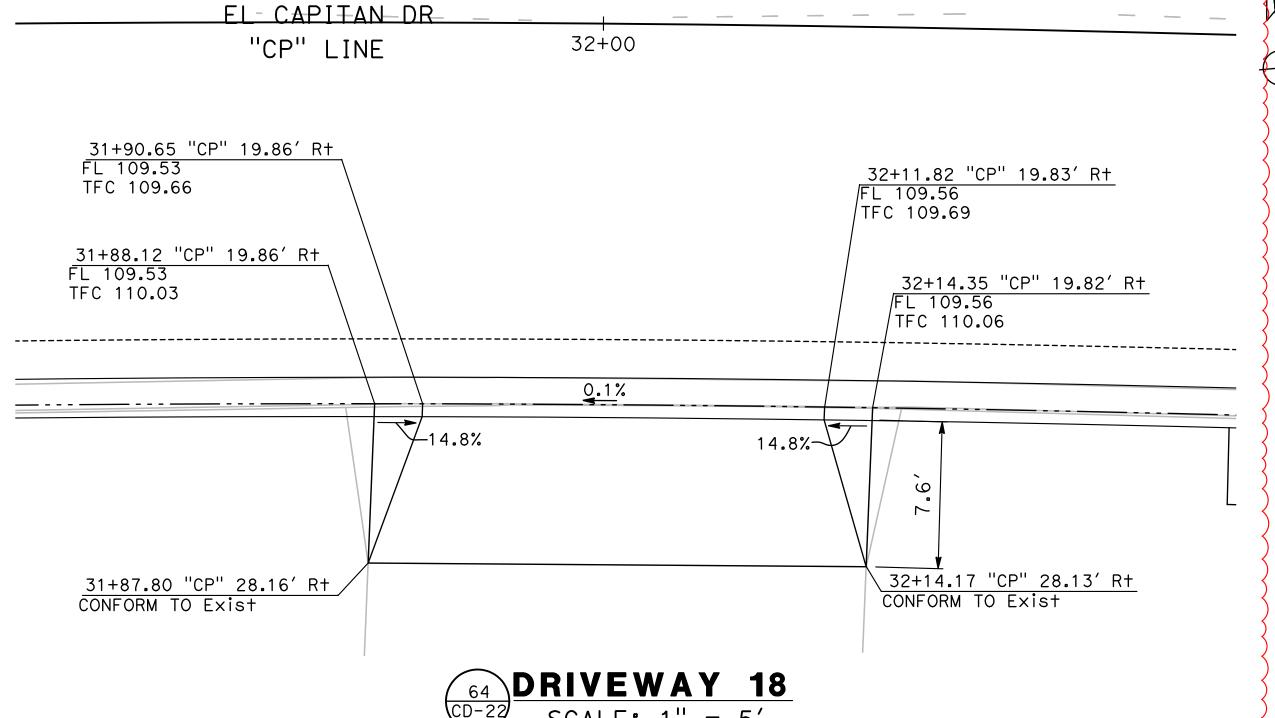



DESIGNED BY: ANGEL P. DRAWN BY: ANGEL P.

CHECKED BY: JON H. SCALE: AS SHOWN DATE: 4/2/2024 JOB NO.: 23-00109

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► MARK **THOMAS**


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(209) 668-5520

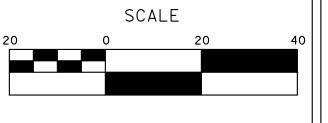
CITY OF TURLOCK ROADS PROGRAM - CIP CONSTRUCTION DETAILS | CD-22

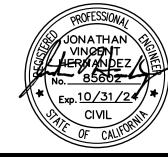Sheet <u>51</u> **109** Sheets



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SEE LEGEND ON SHEET G-1

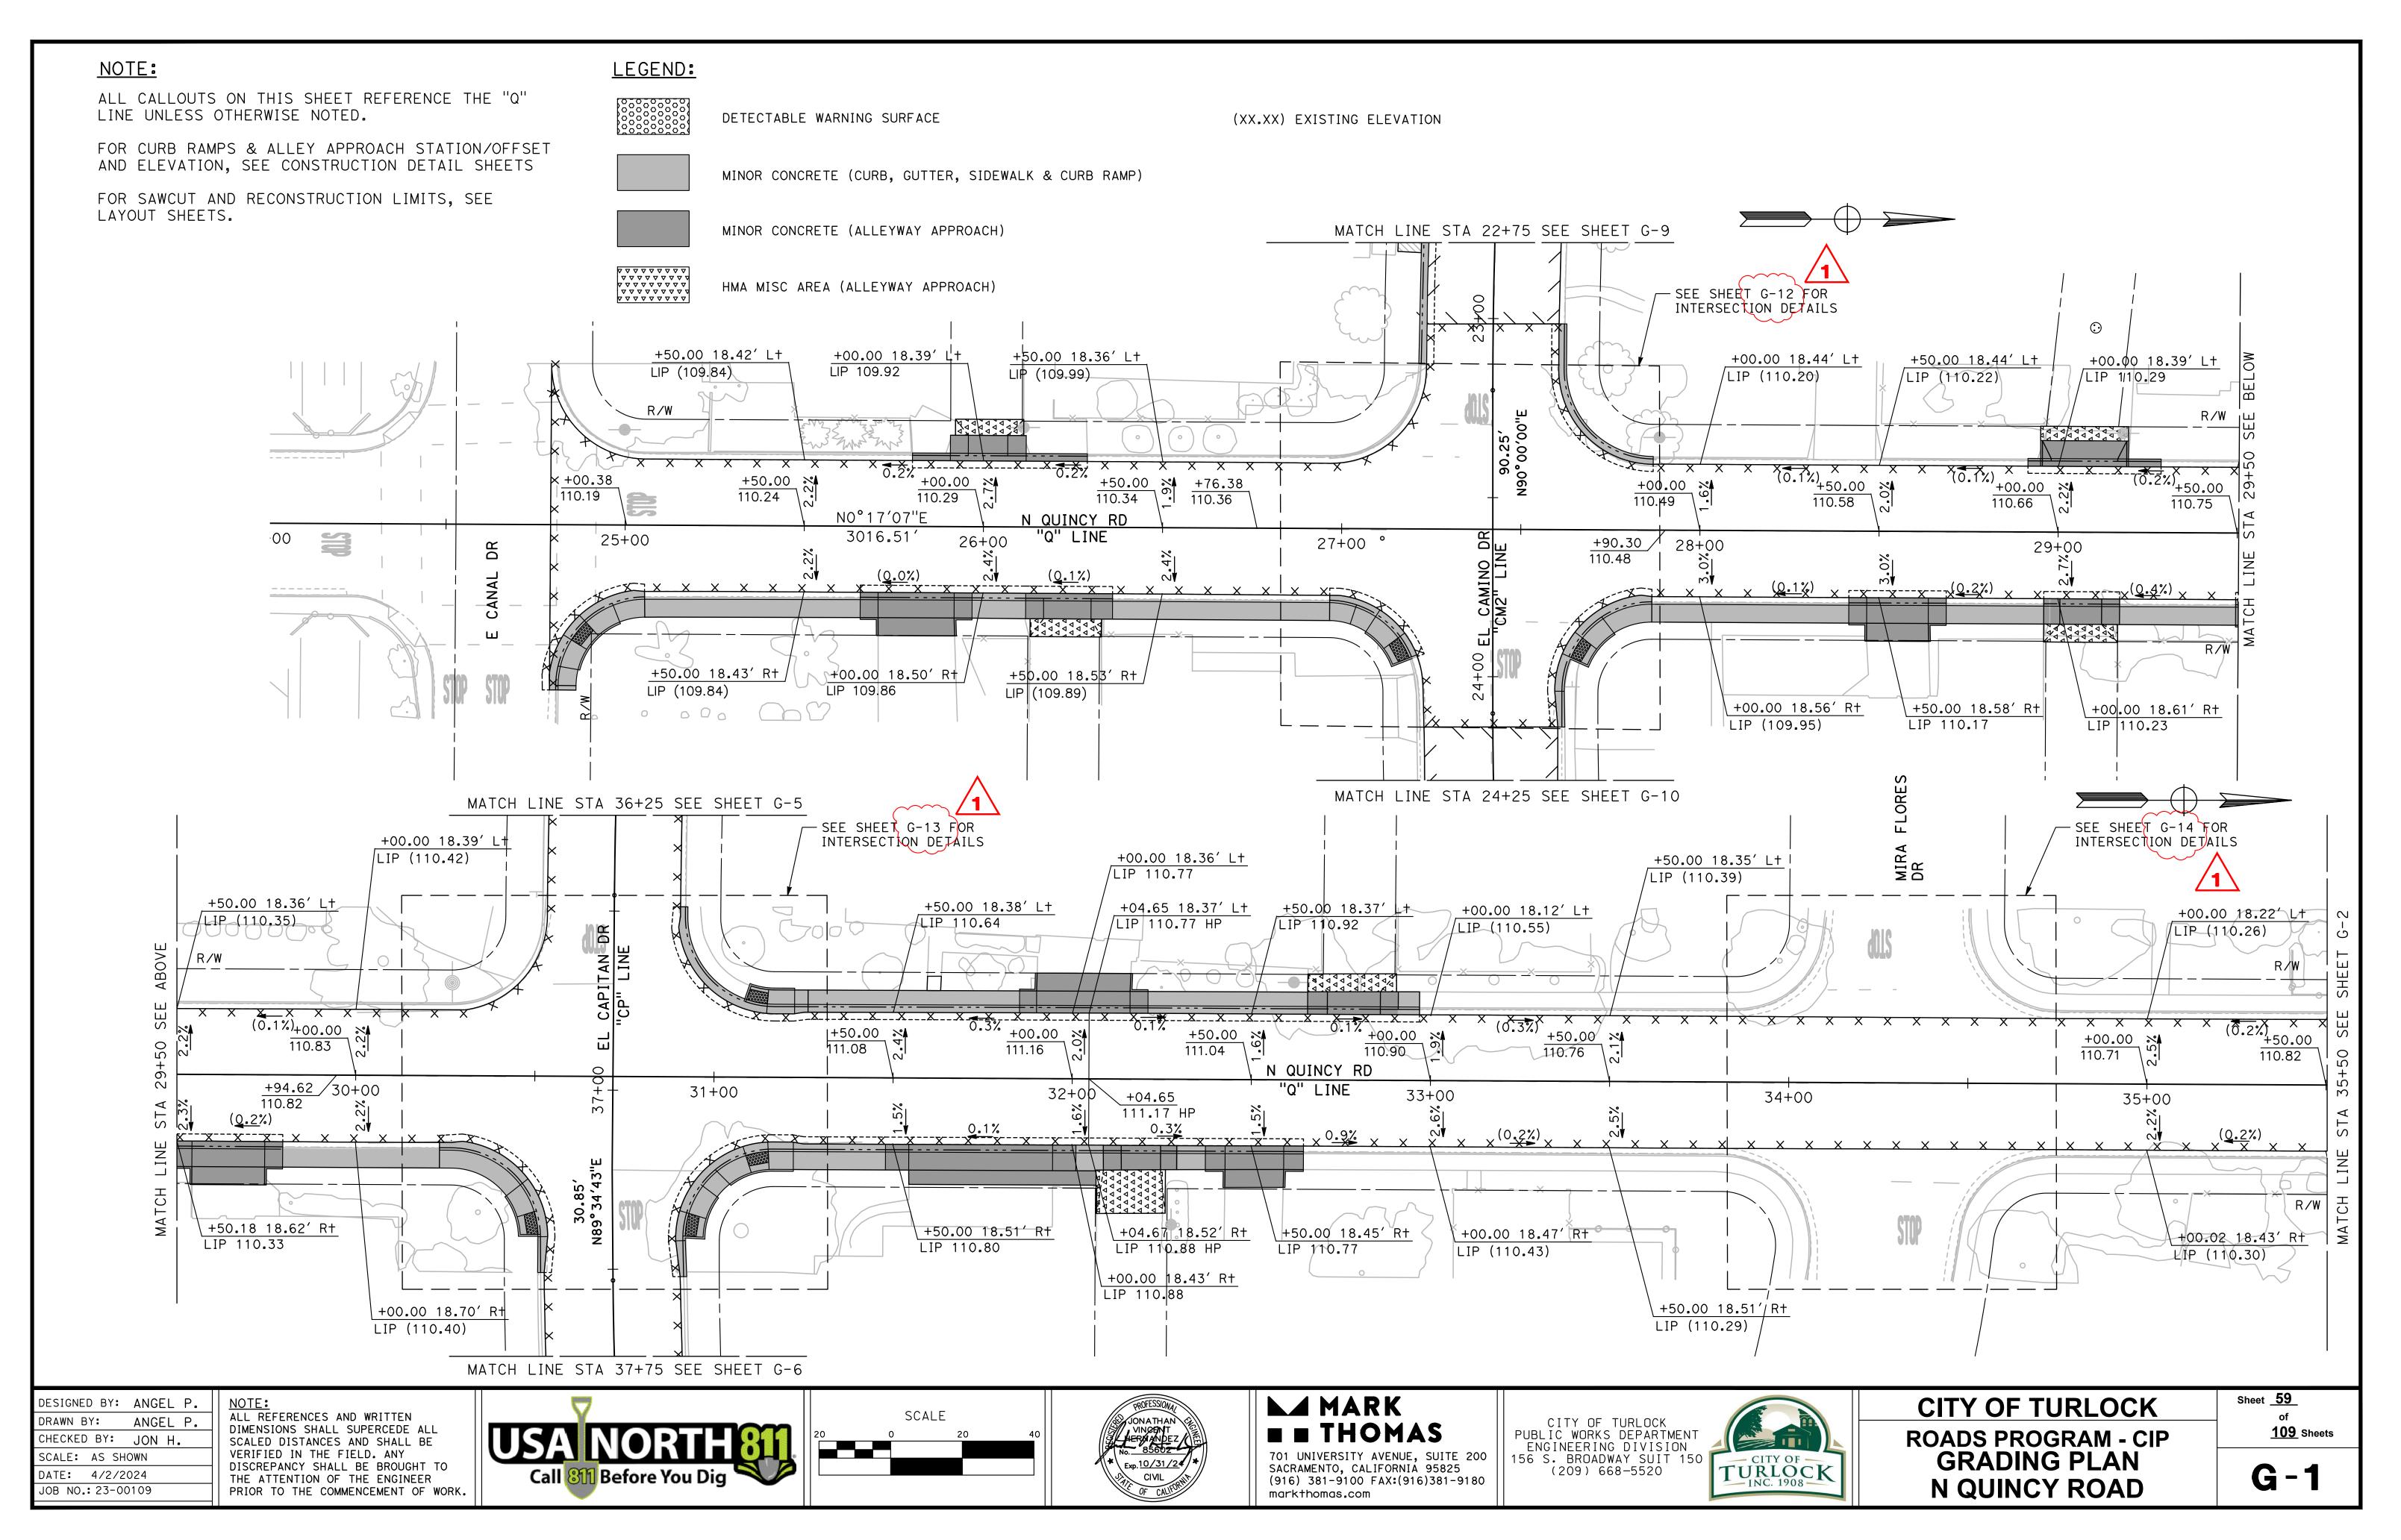


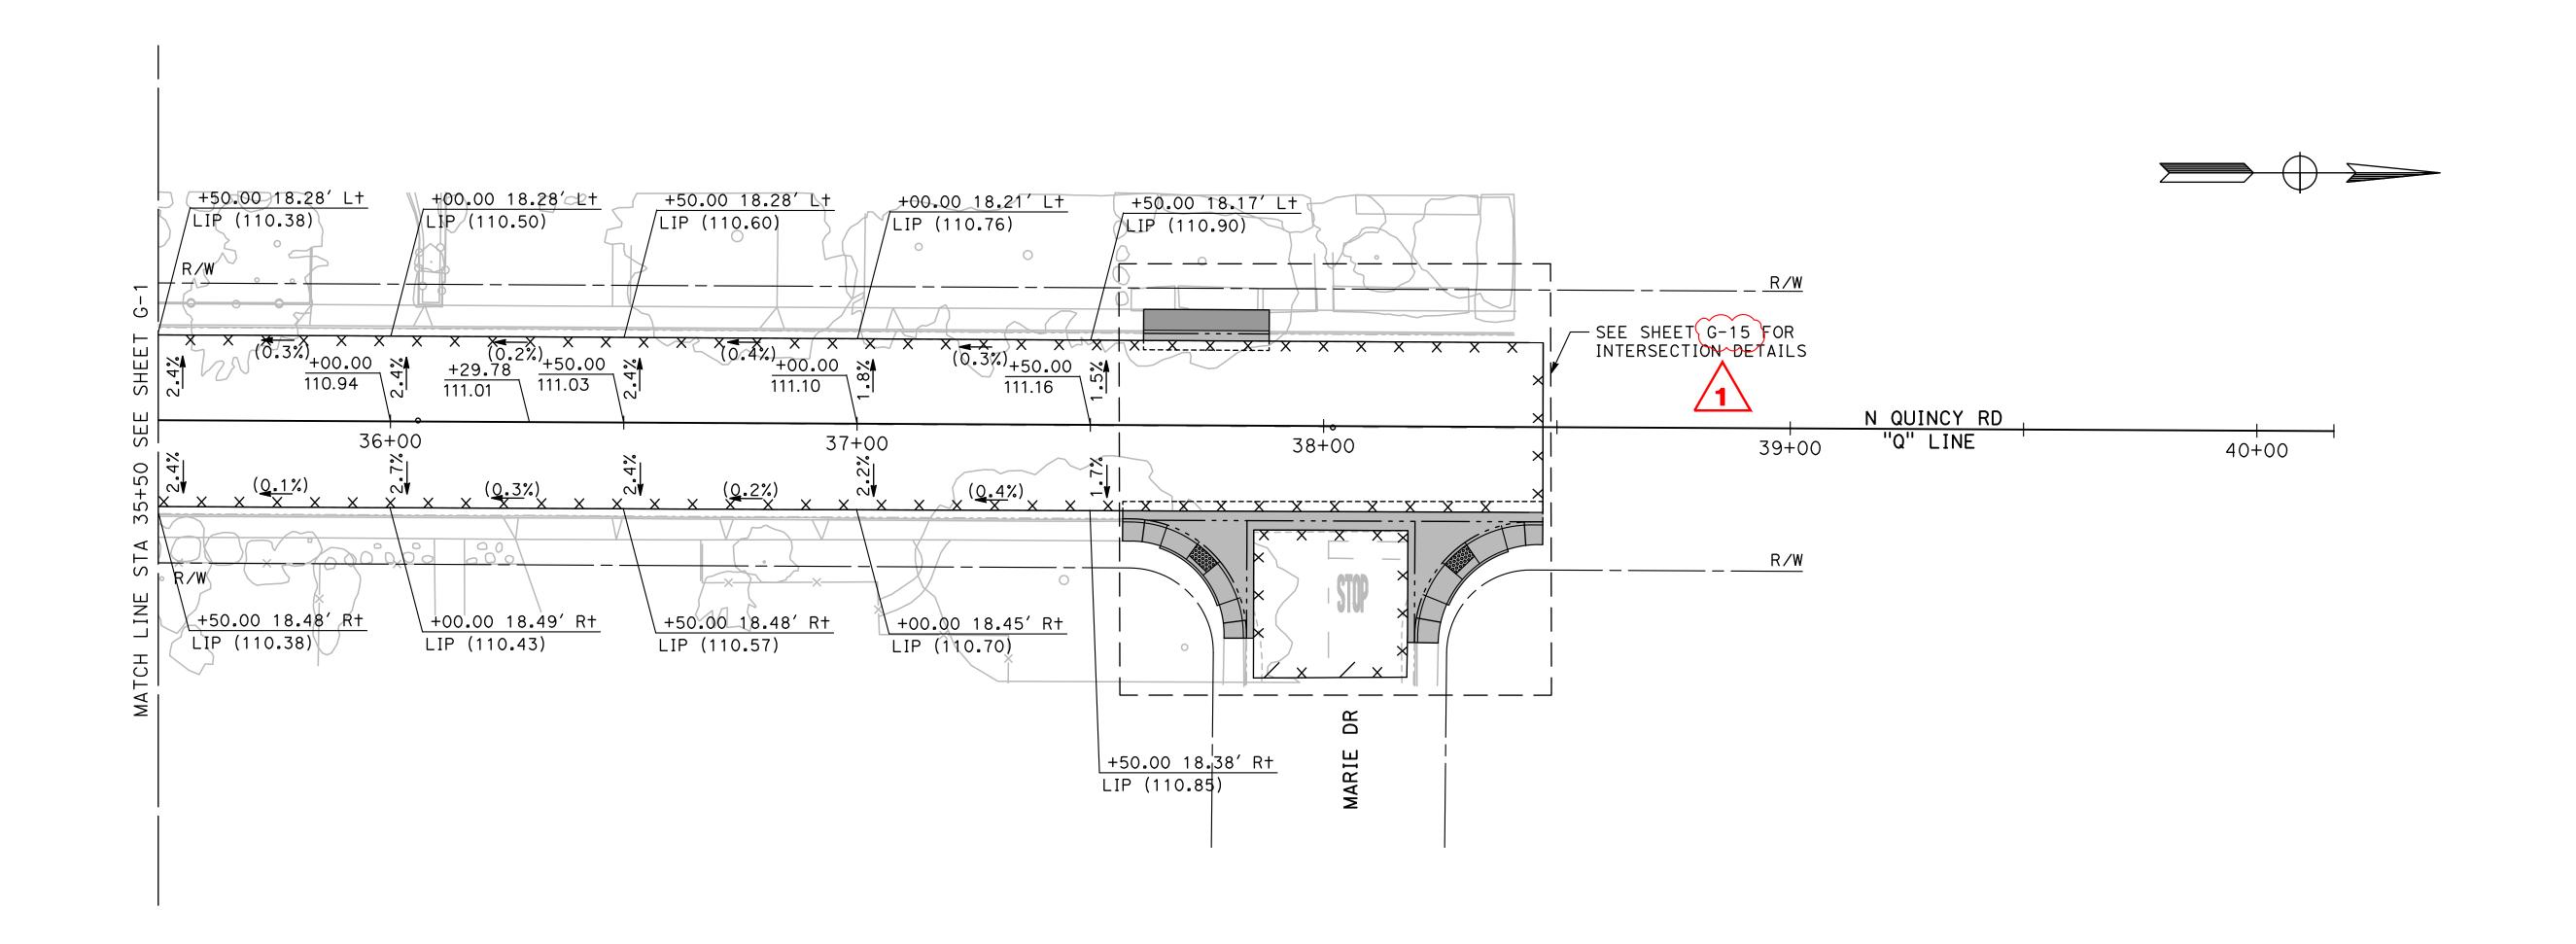DESIGNED BY:	ANGEL P.
DRAWN BY:	ANGEL P.
CHECKED BY:	JON H.
SCALE: AS SH	OWN

DATE: 4/2/2024 JOB NO.: 23-00109

NOTE:
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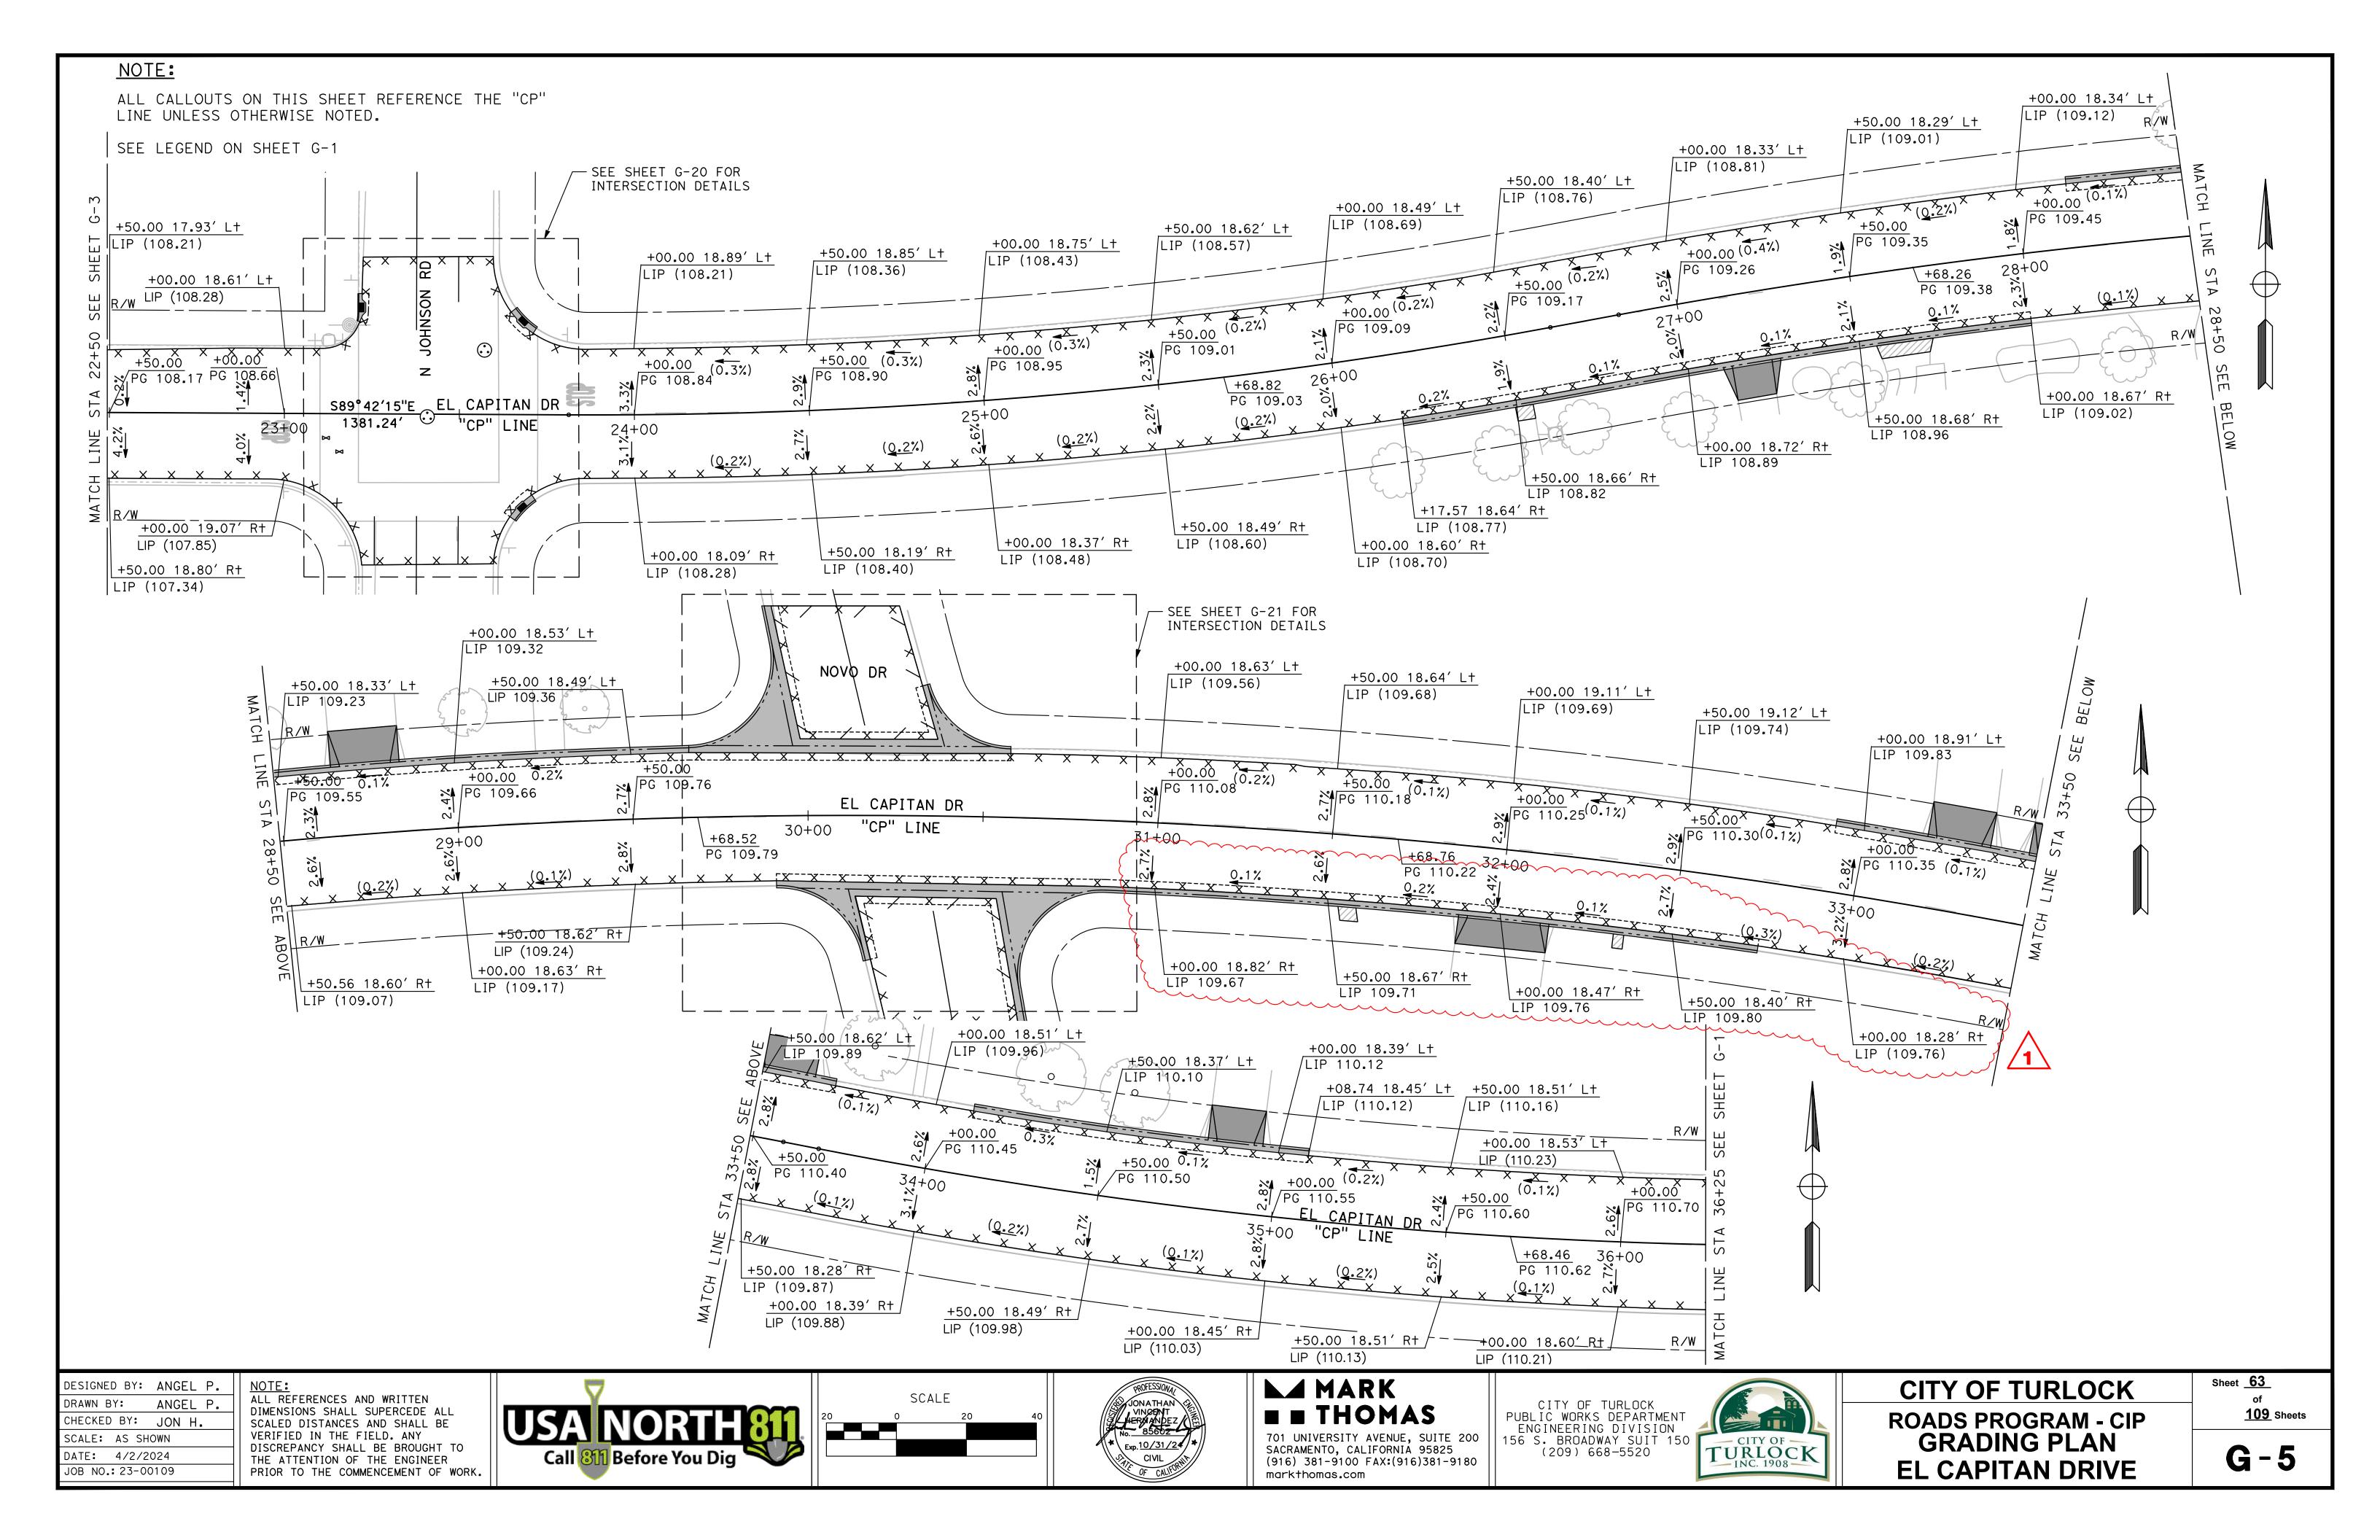



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CITY OF TURLOCK ROADS PROGRAM - CIP GRADING PLAN N QUINCY ROAD

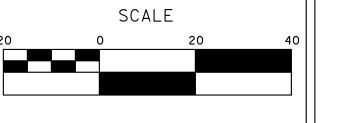
Sheet <u>**60**</u> of **109** Sheets






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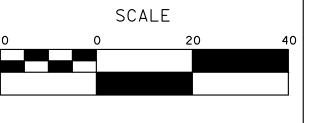


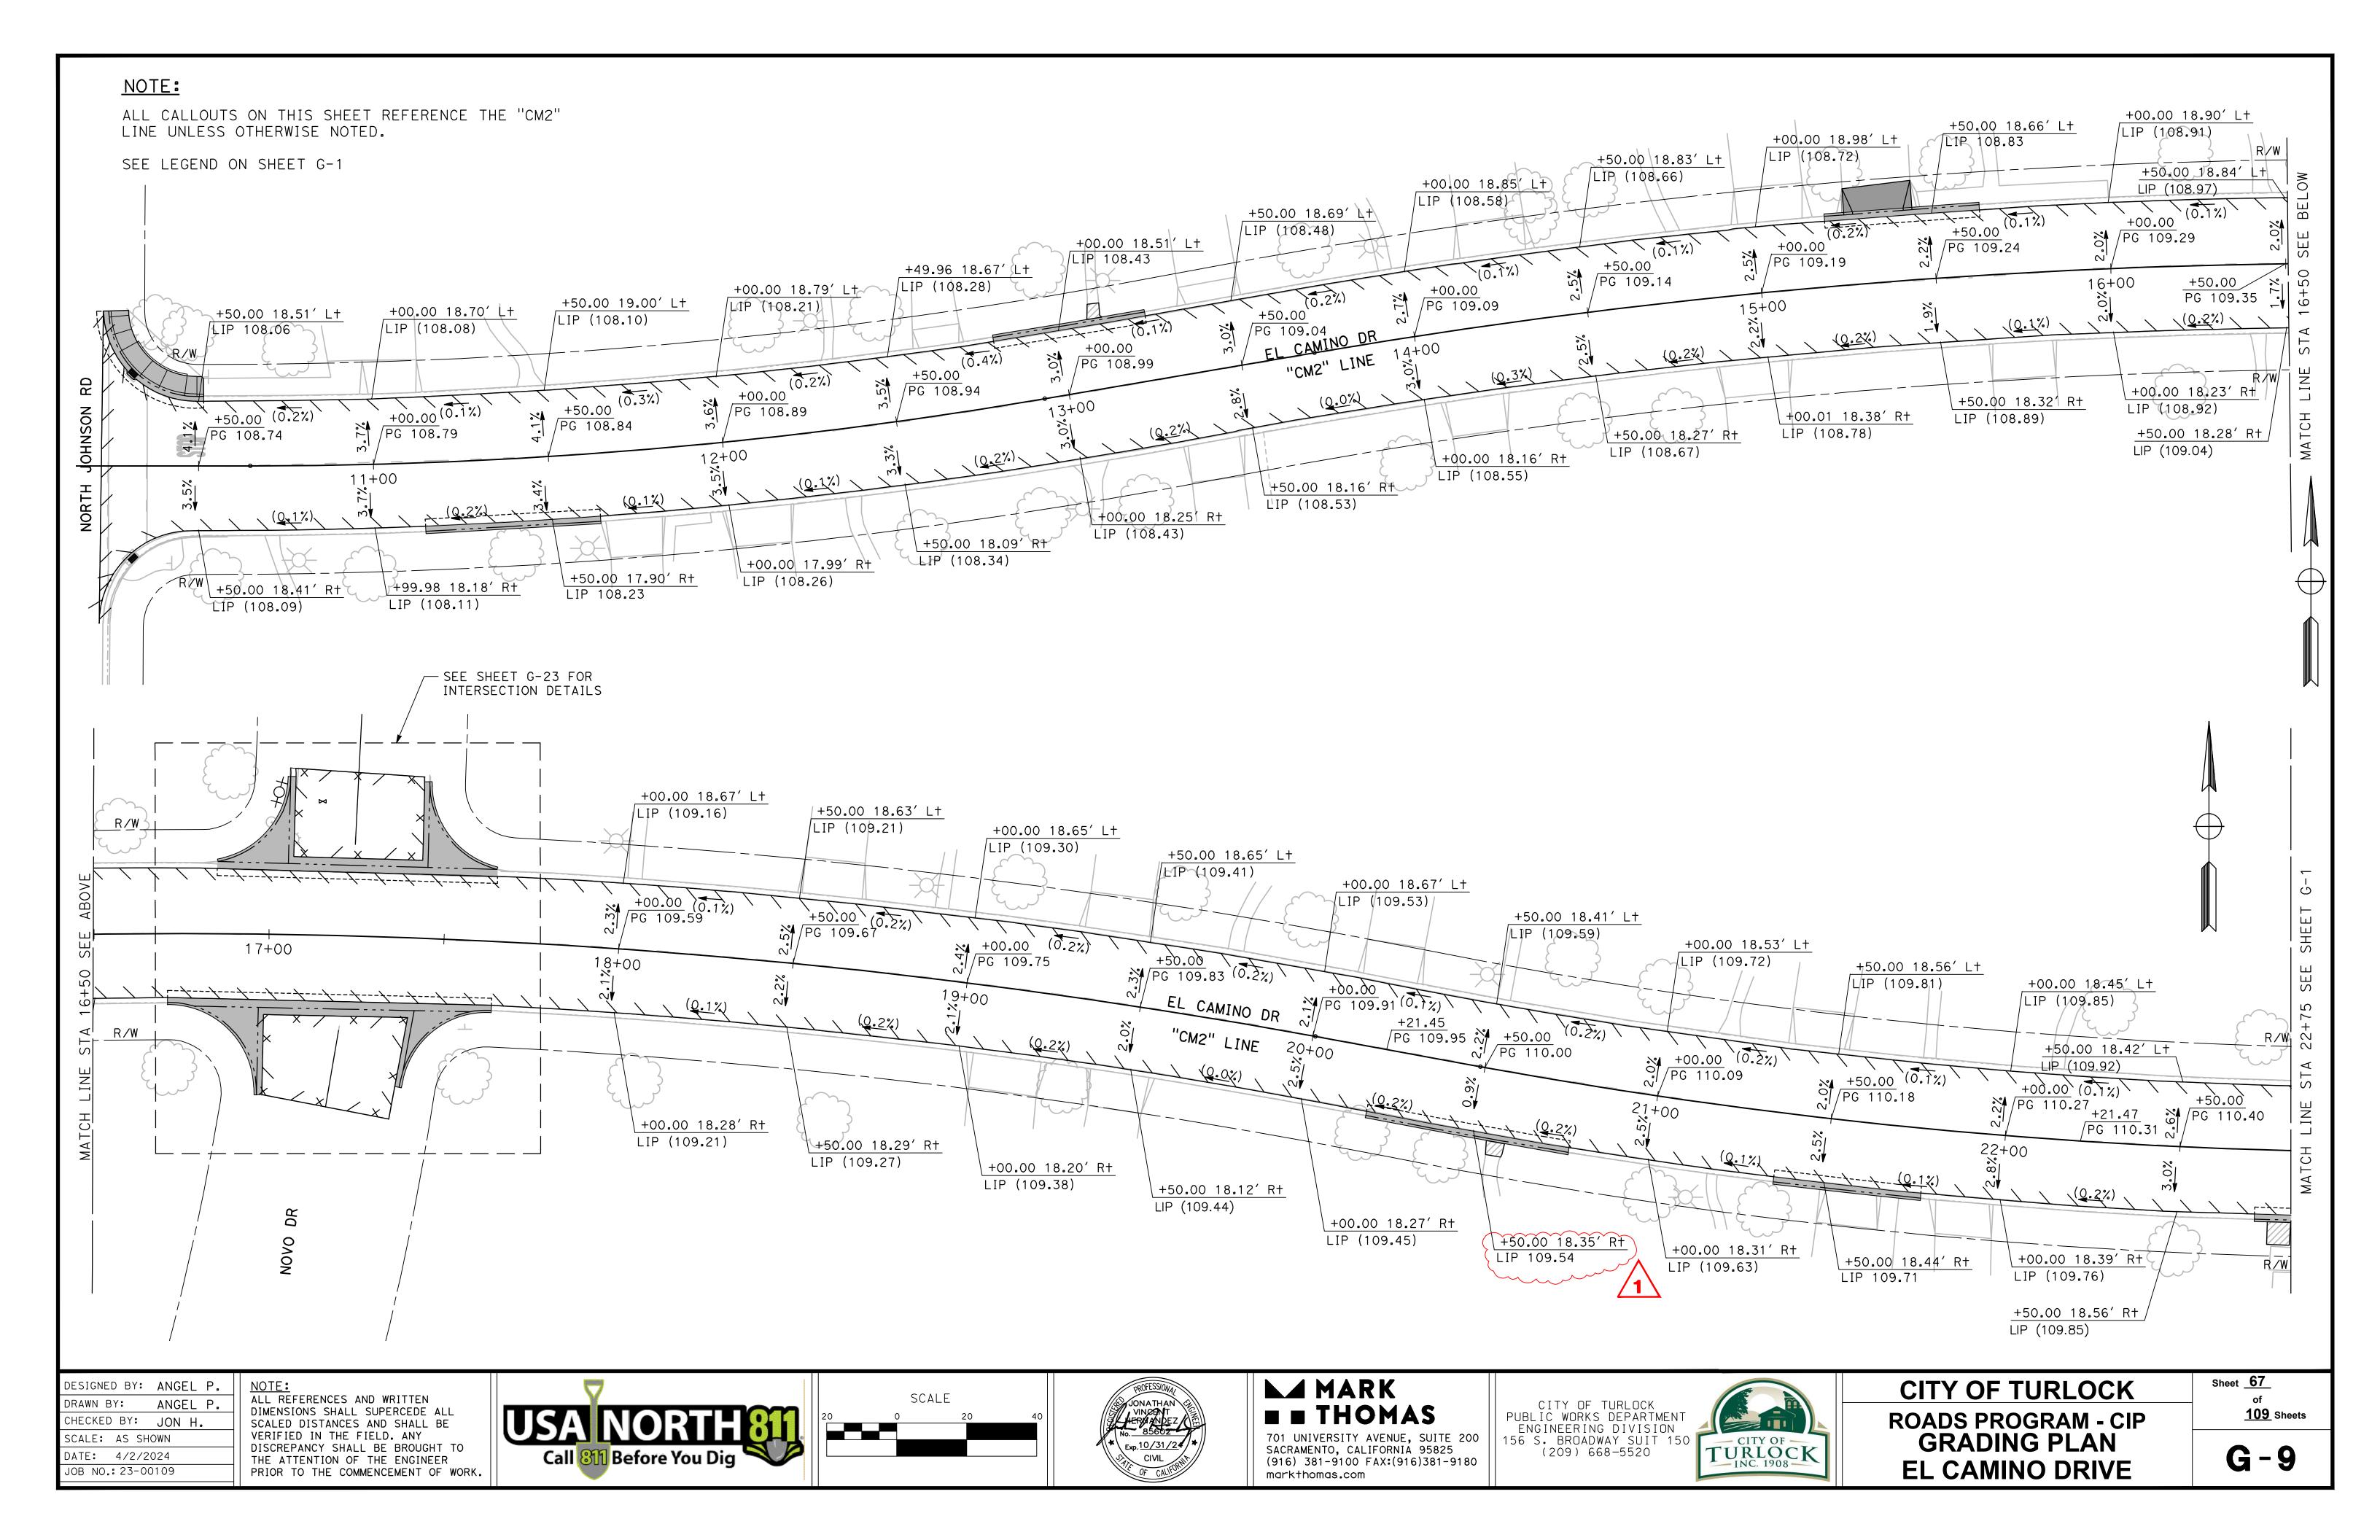


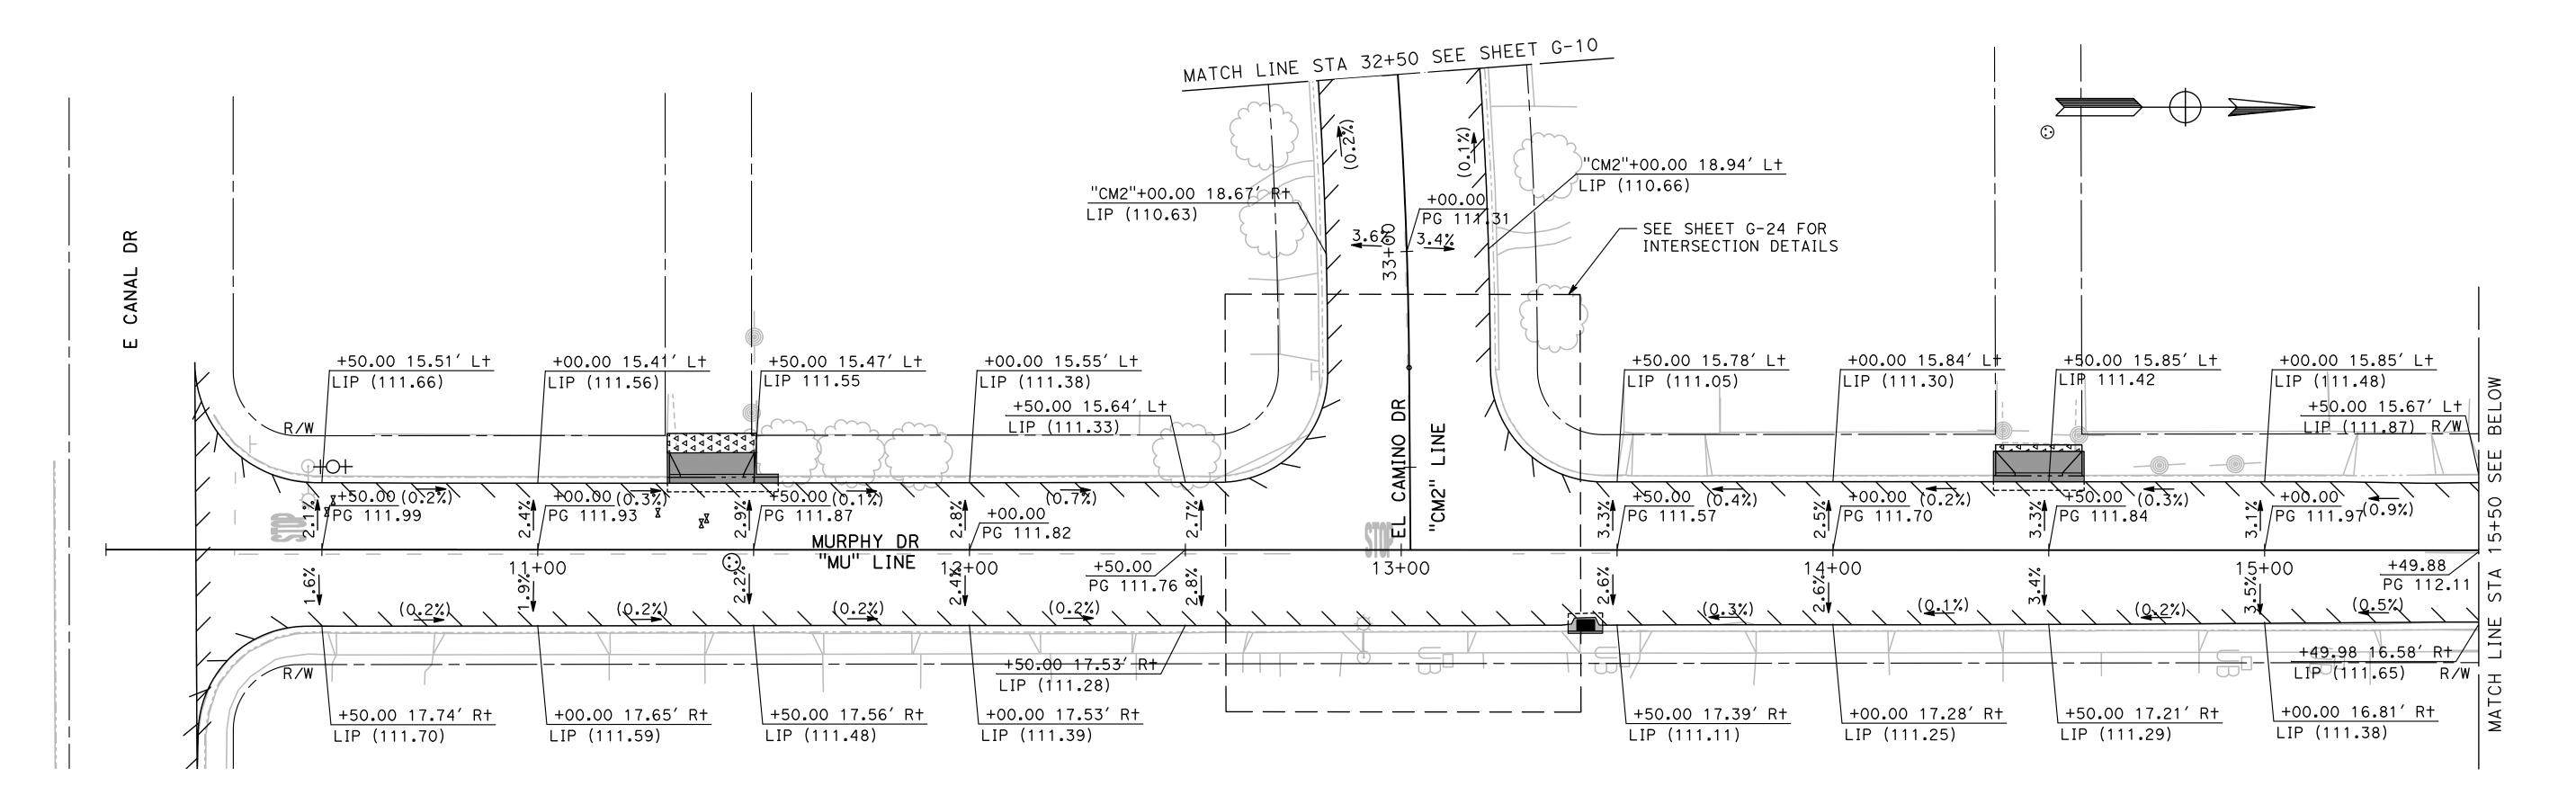DESIGNED BY: ANGEL P. ANGEL P. DRAWN BY: CHECKED BY: JON H.
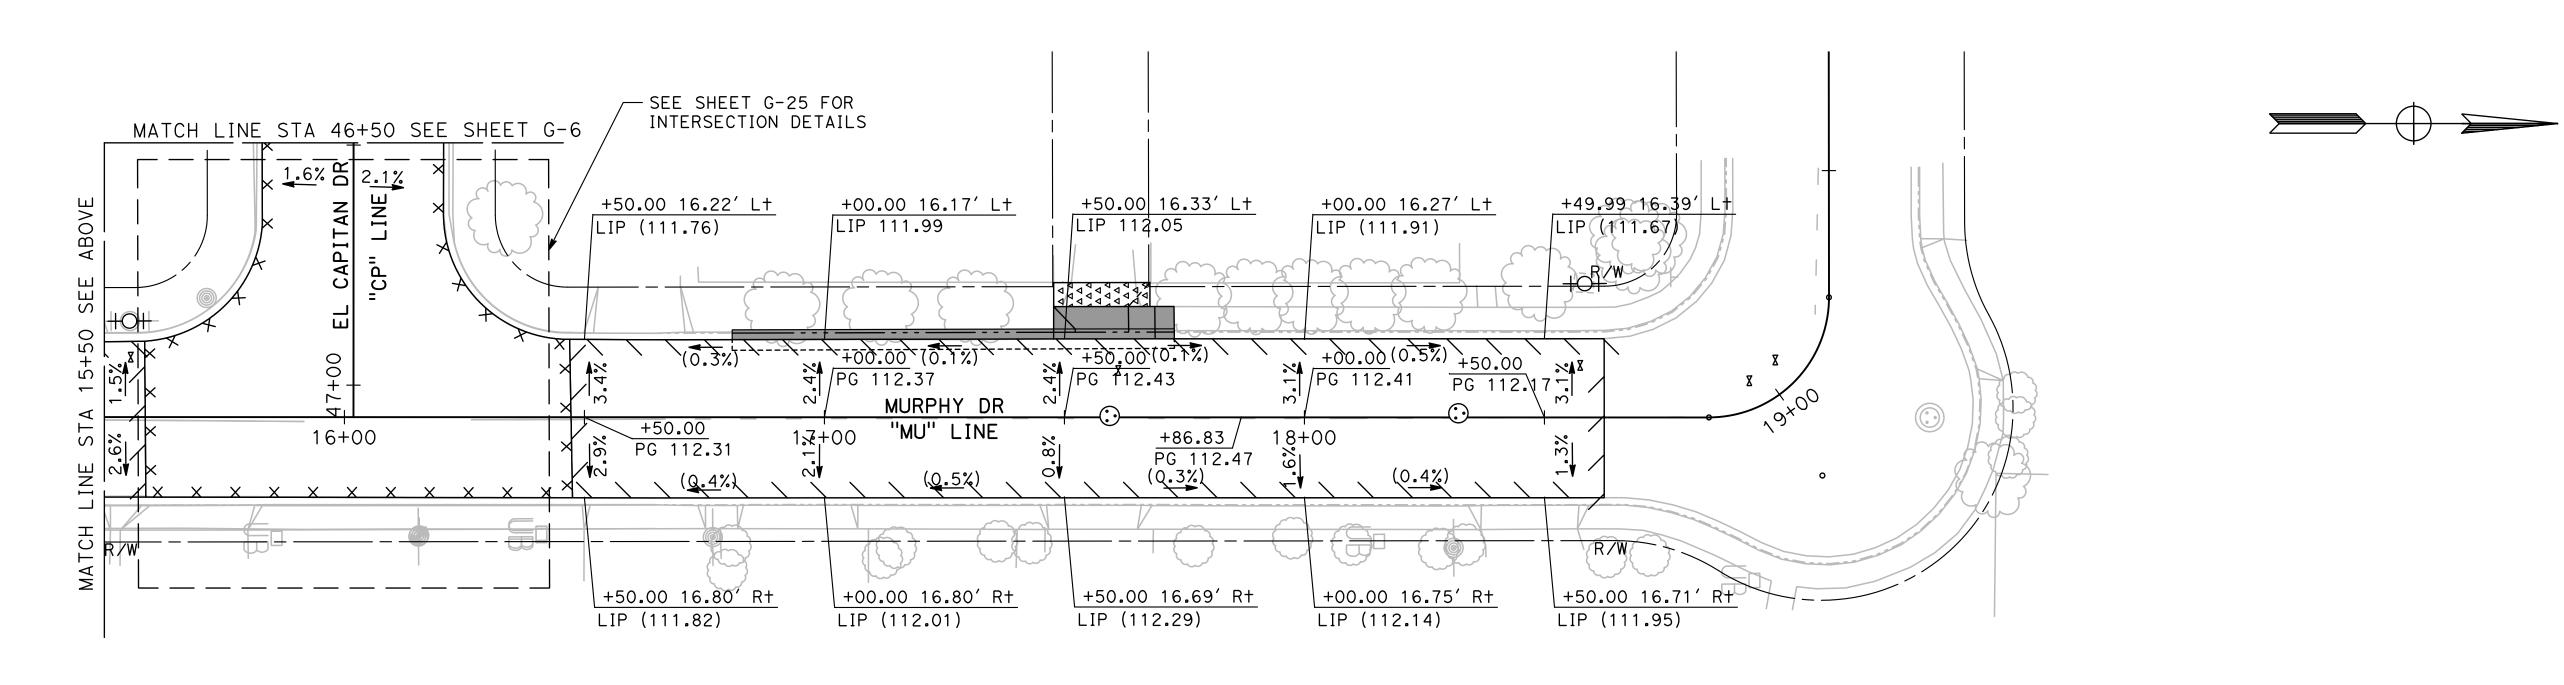
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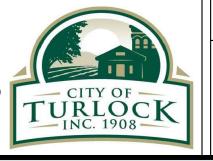




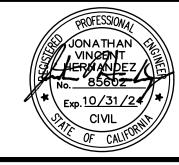

► MARK THOMAS

CITY OF TURLOCK PUBLIC WORKS DEPARTMENT ENGINEERING DIVISION 701 UNIVERSITY AVENUE, SUITE 200 156 S. BROADWAY SUIT 150 SACRAMENTO, CALIFORNIA 95825 (916) 381-9100 FAX:(916)381-9180 markthomas.com




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CITY OF TURLOCK ROADS PROGRAM - CIP GRADING PLAN MURPHY DR

Sheet <u>**69**</u> of 109 Sheets

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SEE LEGEND ON SHEET G-1




DESIGNED BY:	ANGEL P.	
DRAWN BY:	ANGEL P.	
CHECKED BY:	JON H.	
SCALE: AS SHOWN		

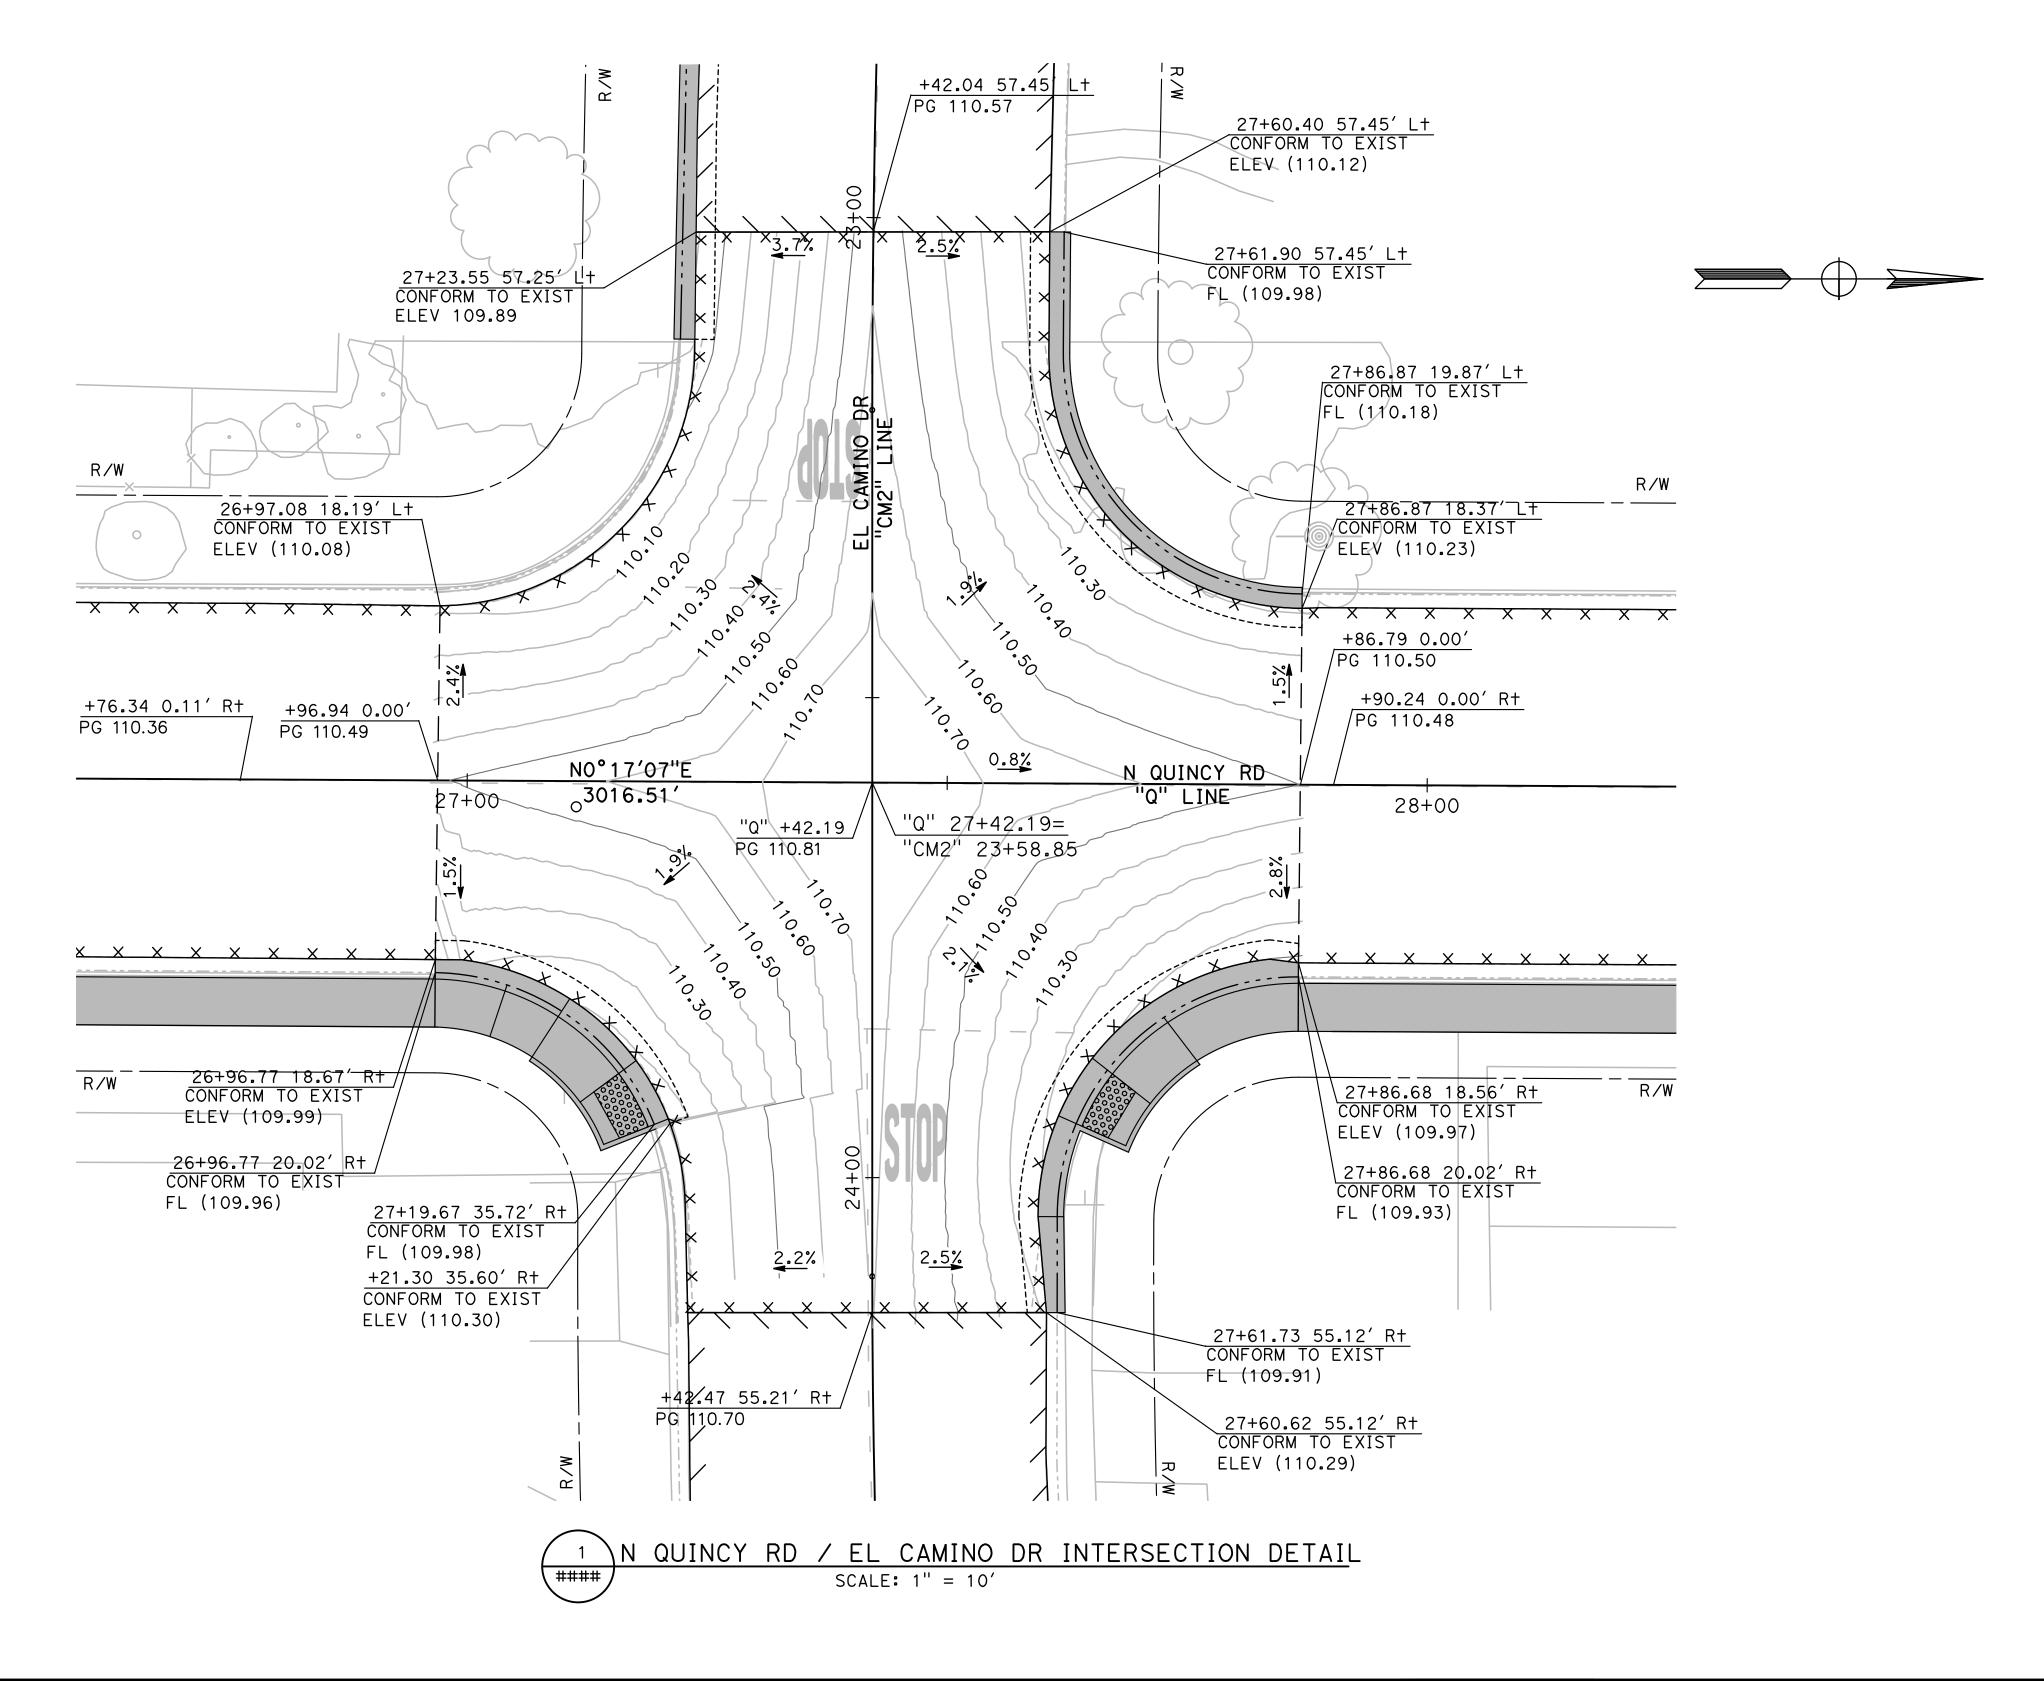DATE: 4/2/2024

JOB NO.: 23-00109

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► MARK **THOMAS**

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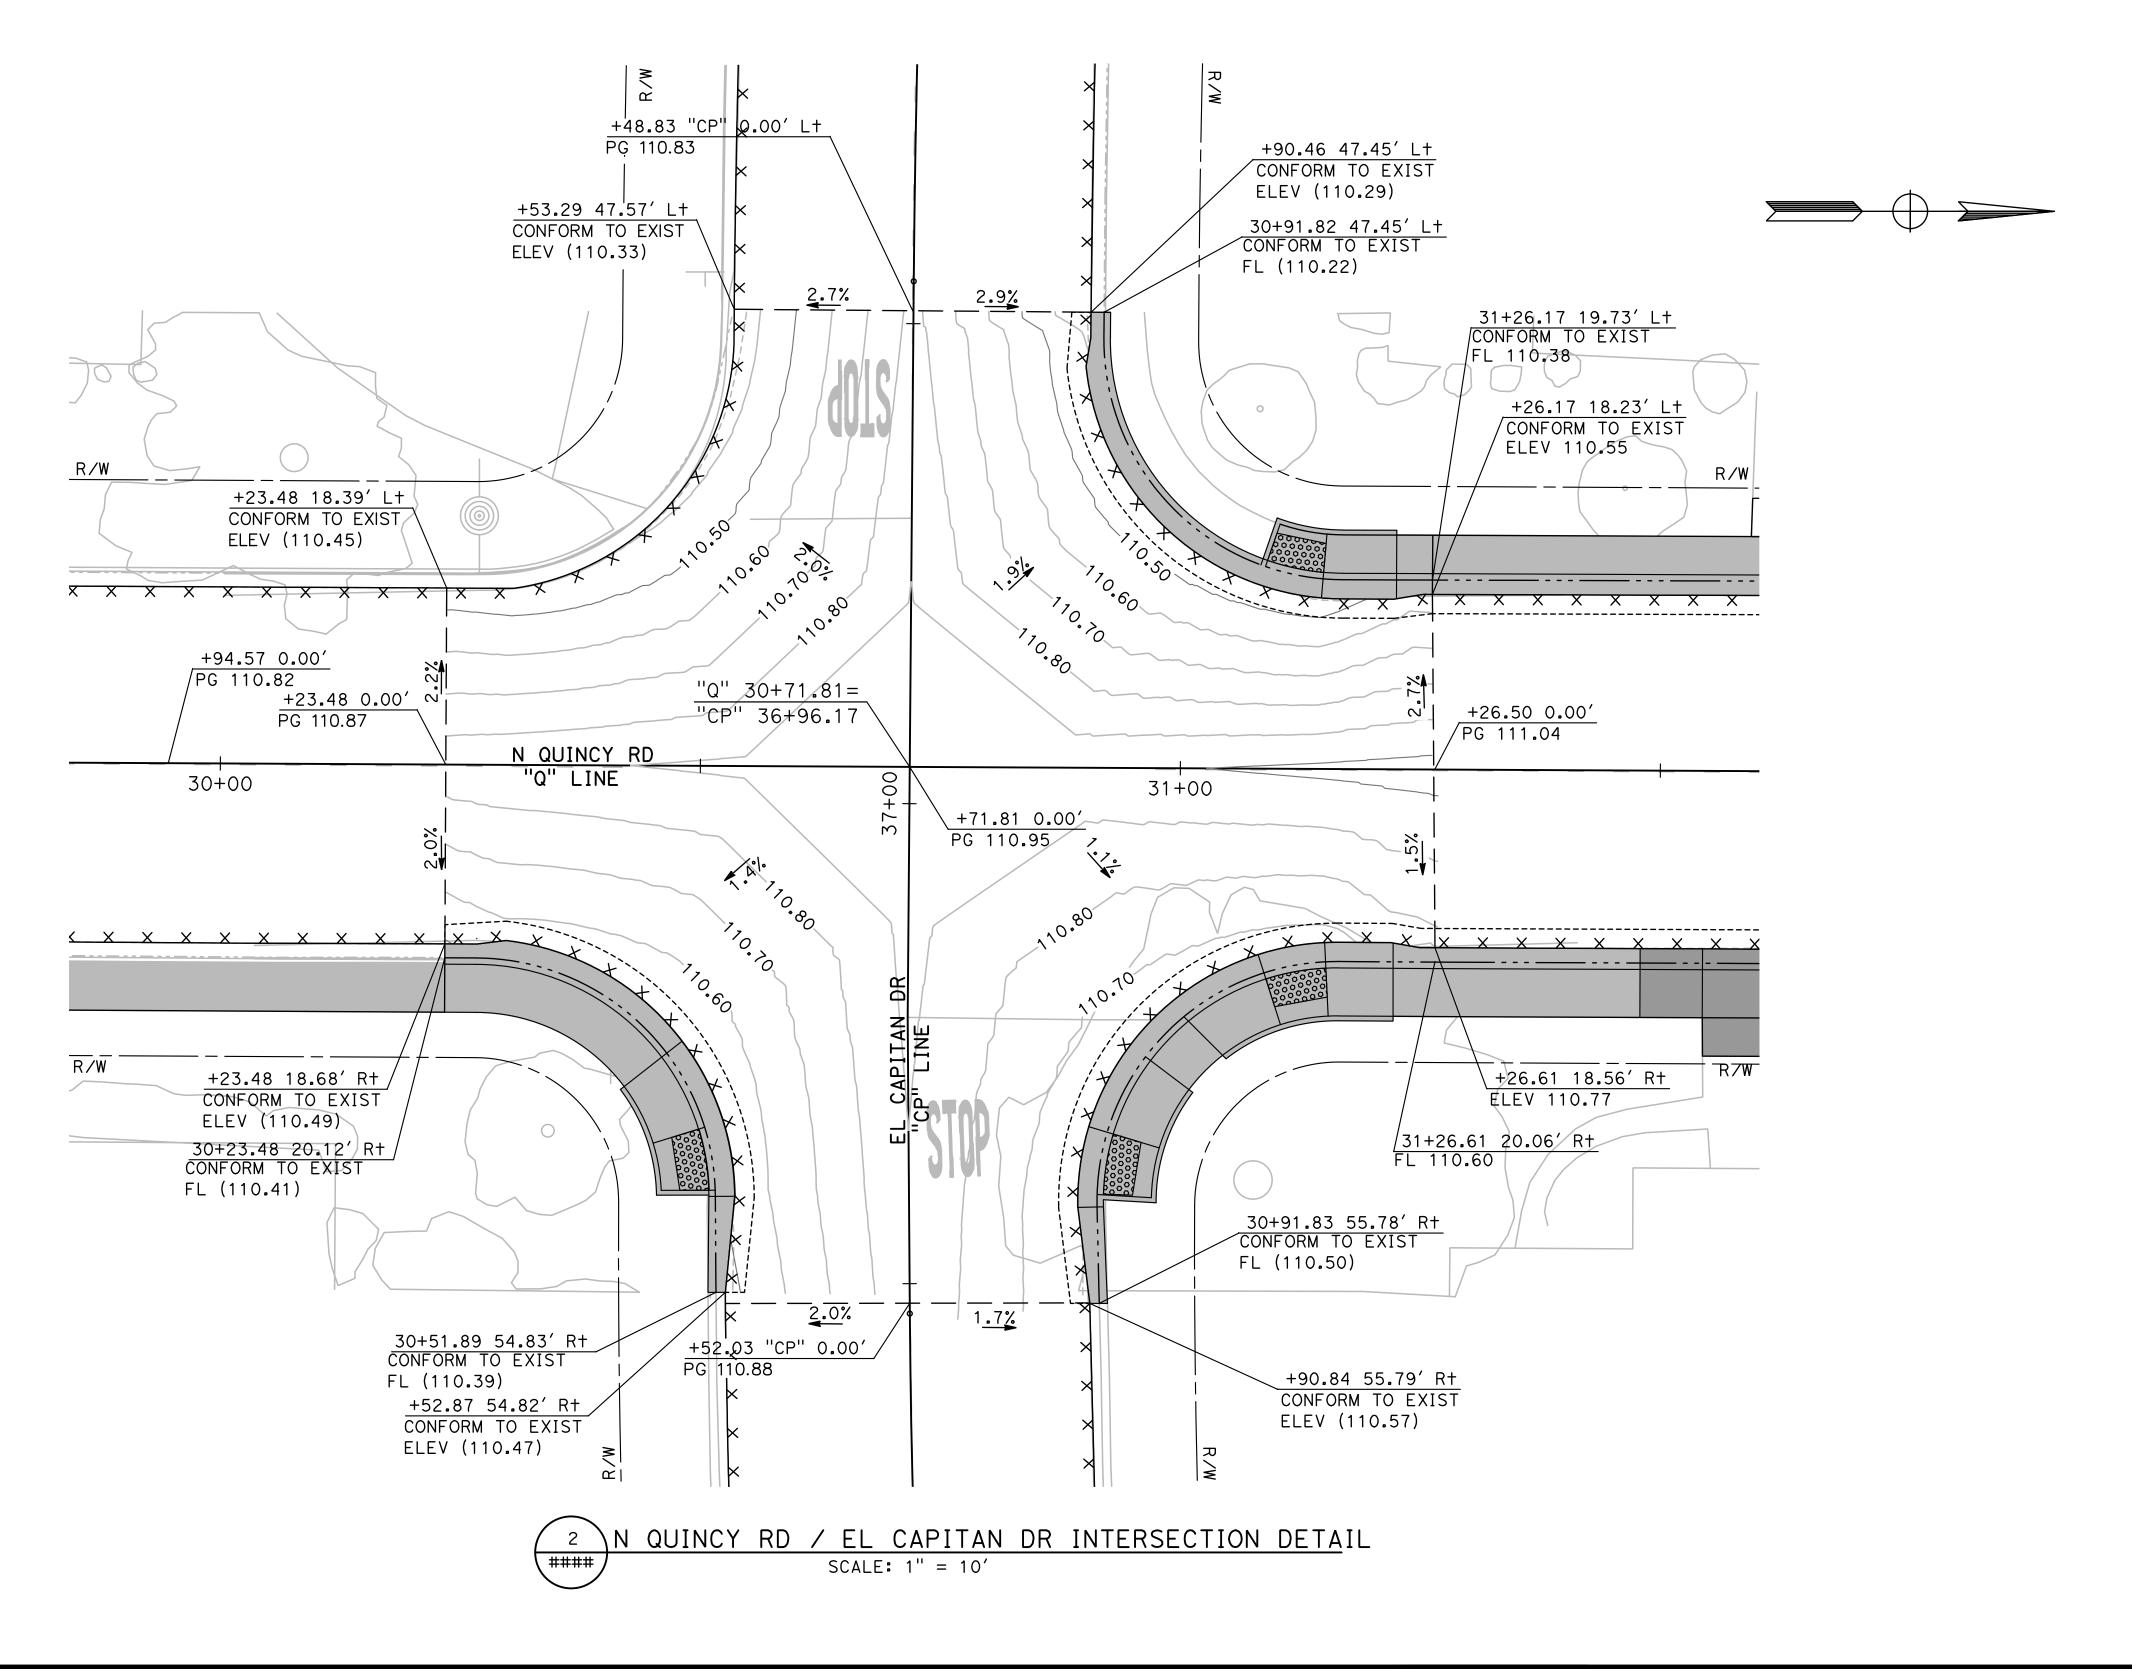
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CITY OF TURLOCK ROADS PROGRAM - CIP GRADING PLAN N QUINCY ROAD

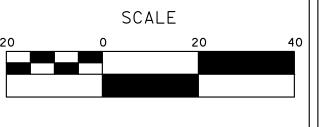Sheet <u>**70**</u> of **109** Sheets

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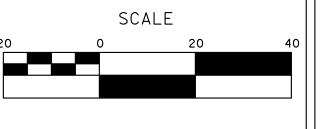
SEE LEGEND ON SHEET G-1



DESIGNED BY: ANGEL P. ANGEL P. DRAWN BY: CHECKED BY: JON H.

SCALE: AS SHOWN DATE: 4/2/2024 JOB NO.: 23-00109 ALL REFERENCES AND WRITTEN
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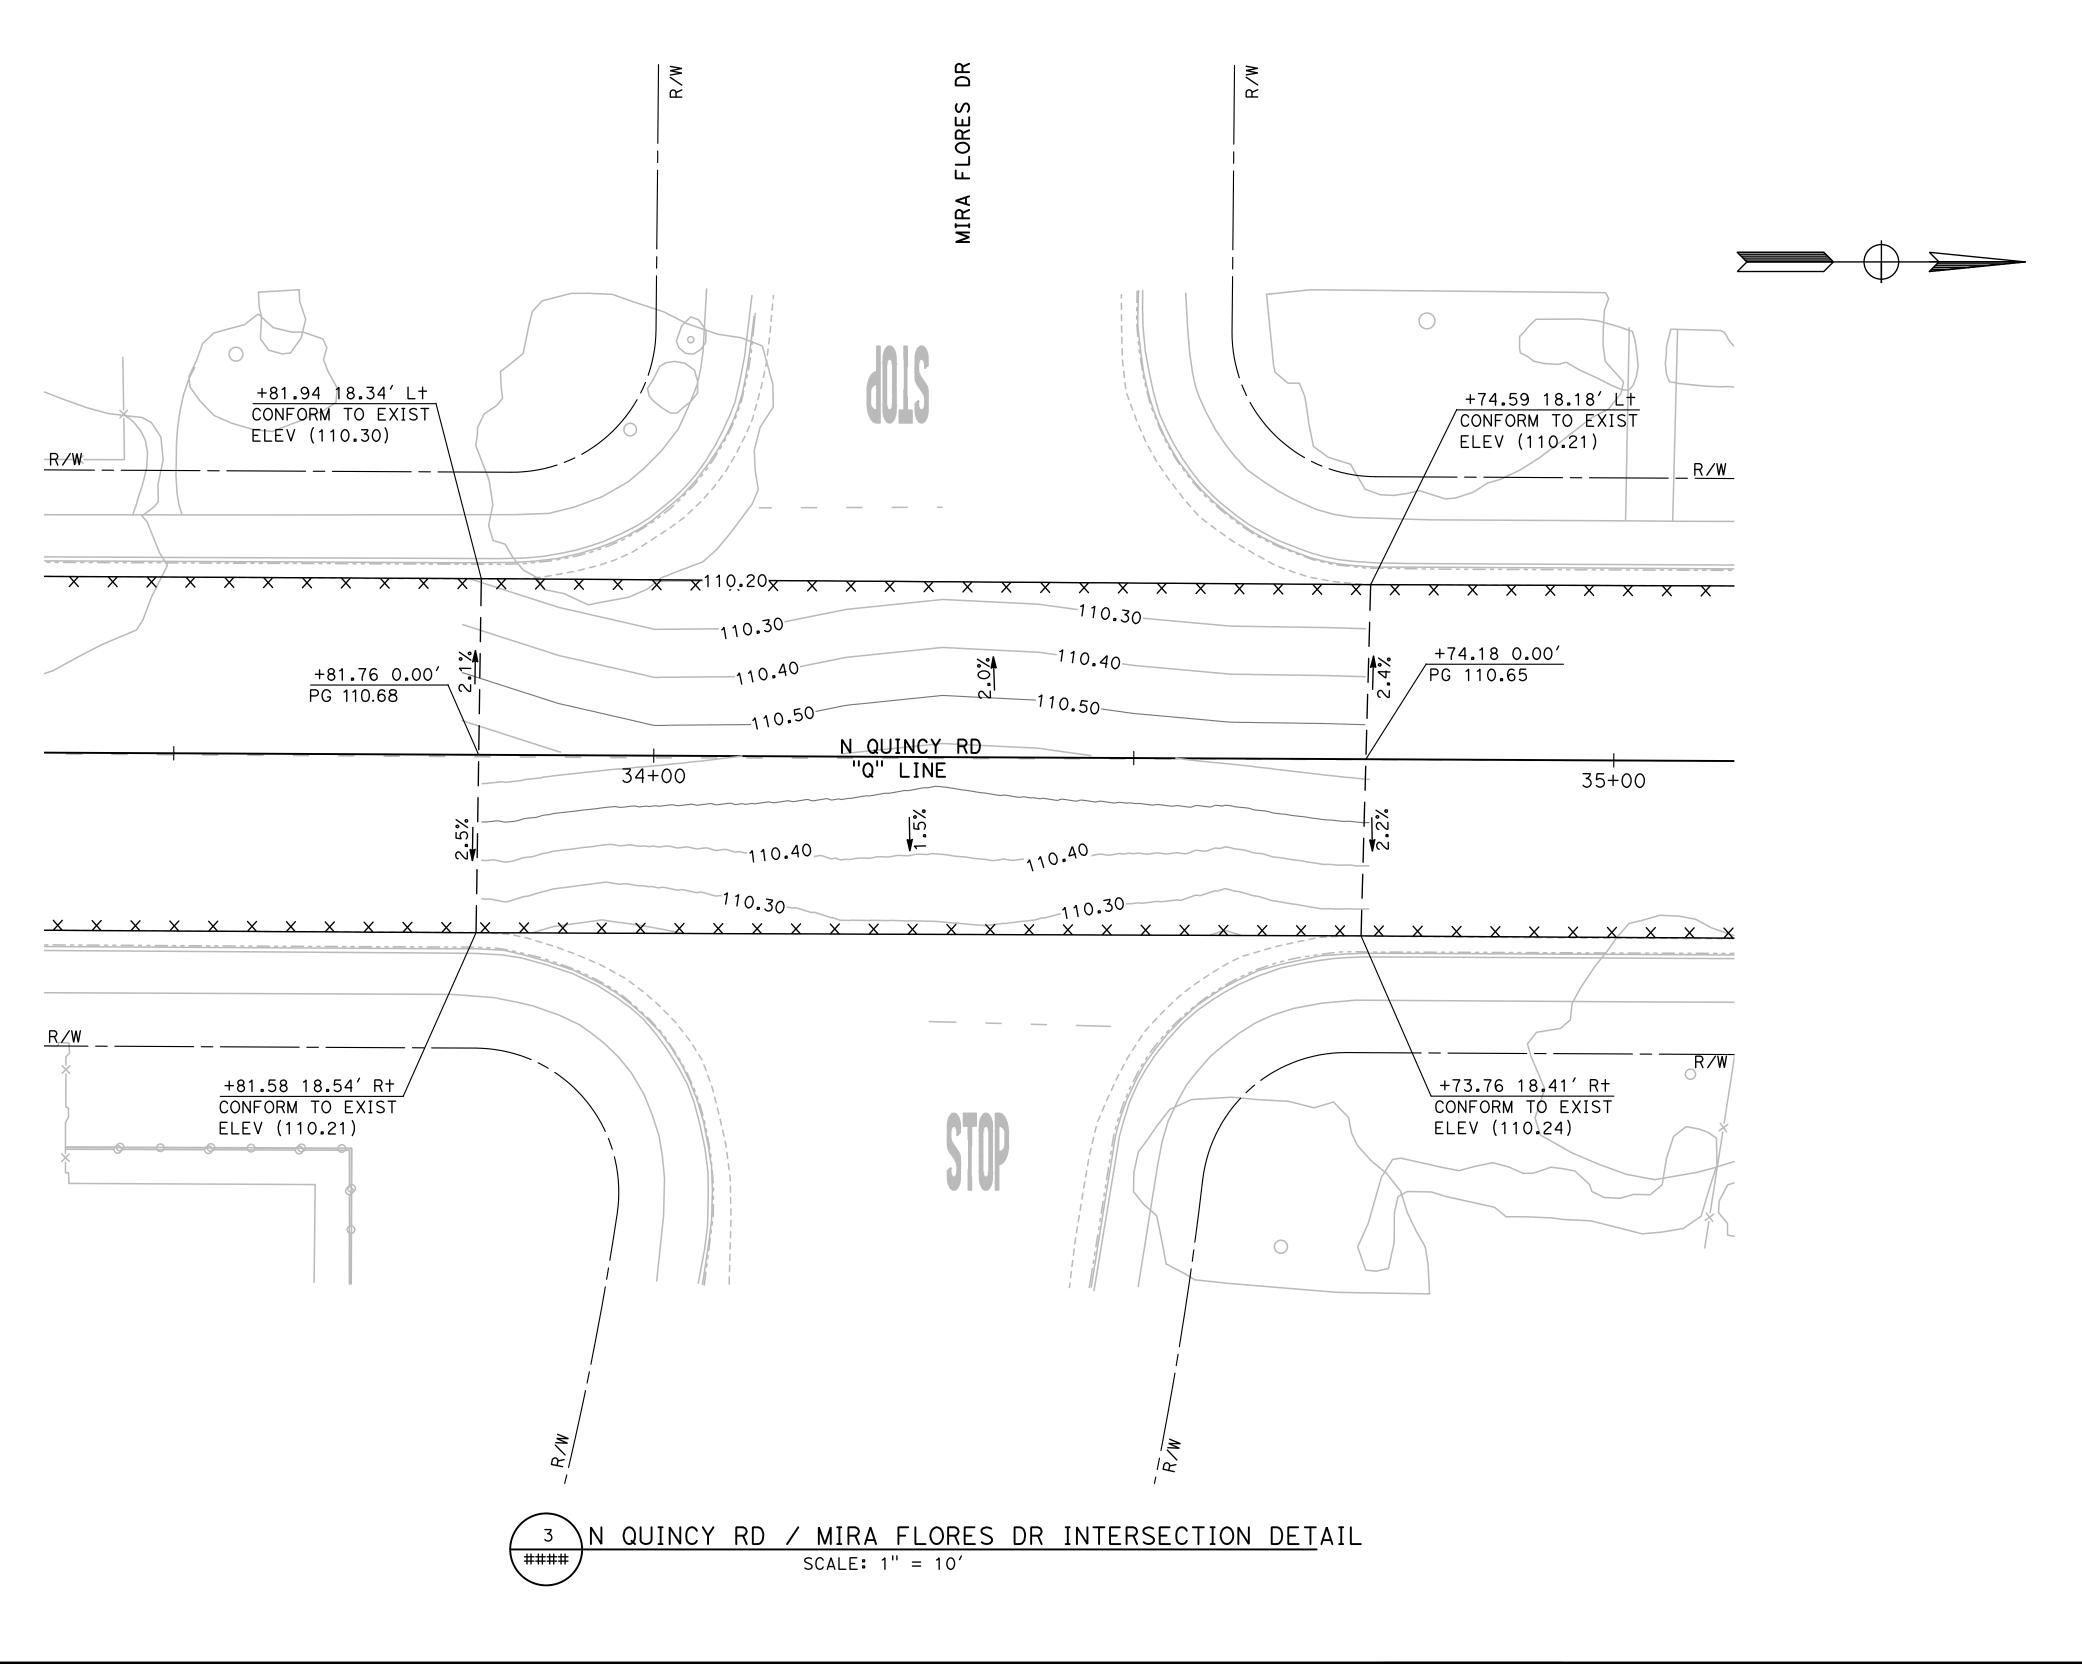


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CITY OF TURLOCK ROADS PROGRAM - CIP GRADING PLAN N QUINCY ROAD

of **109** Sheets

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DRAWN BY: ANGEL P.

CHECKED BY: JON H.


SCALE: AS SHOWN

DATE: 4/2/2024

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CITY OF TURLOCK


ROADS PROGRAM - CIP
GRADING PLAN
N QUINCY RD

Sheet <u>72</u> of <u>109</u> Sheets

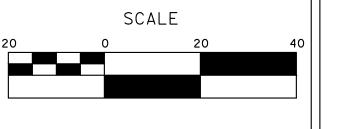ALL CALLOUTS ON THIS SHEET REFERENCE THE "Q" LINE UNLESS OTHERWISE NOTED.

SEE LEGEND ON SHEET G-1



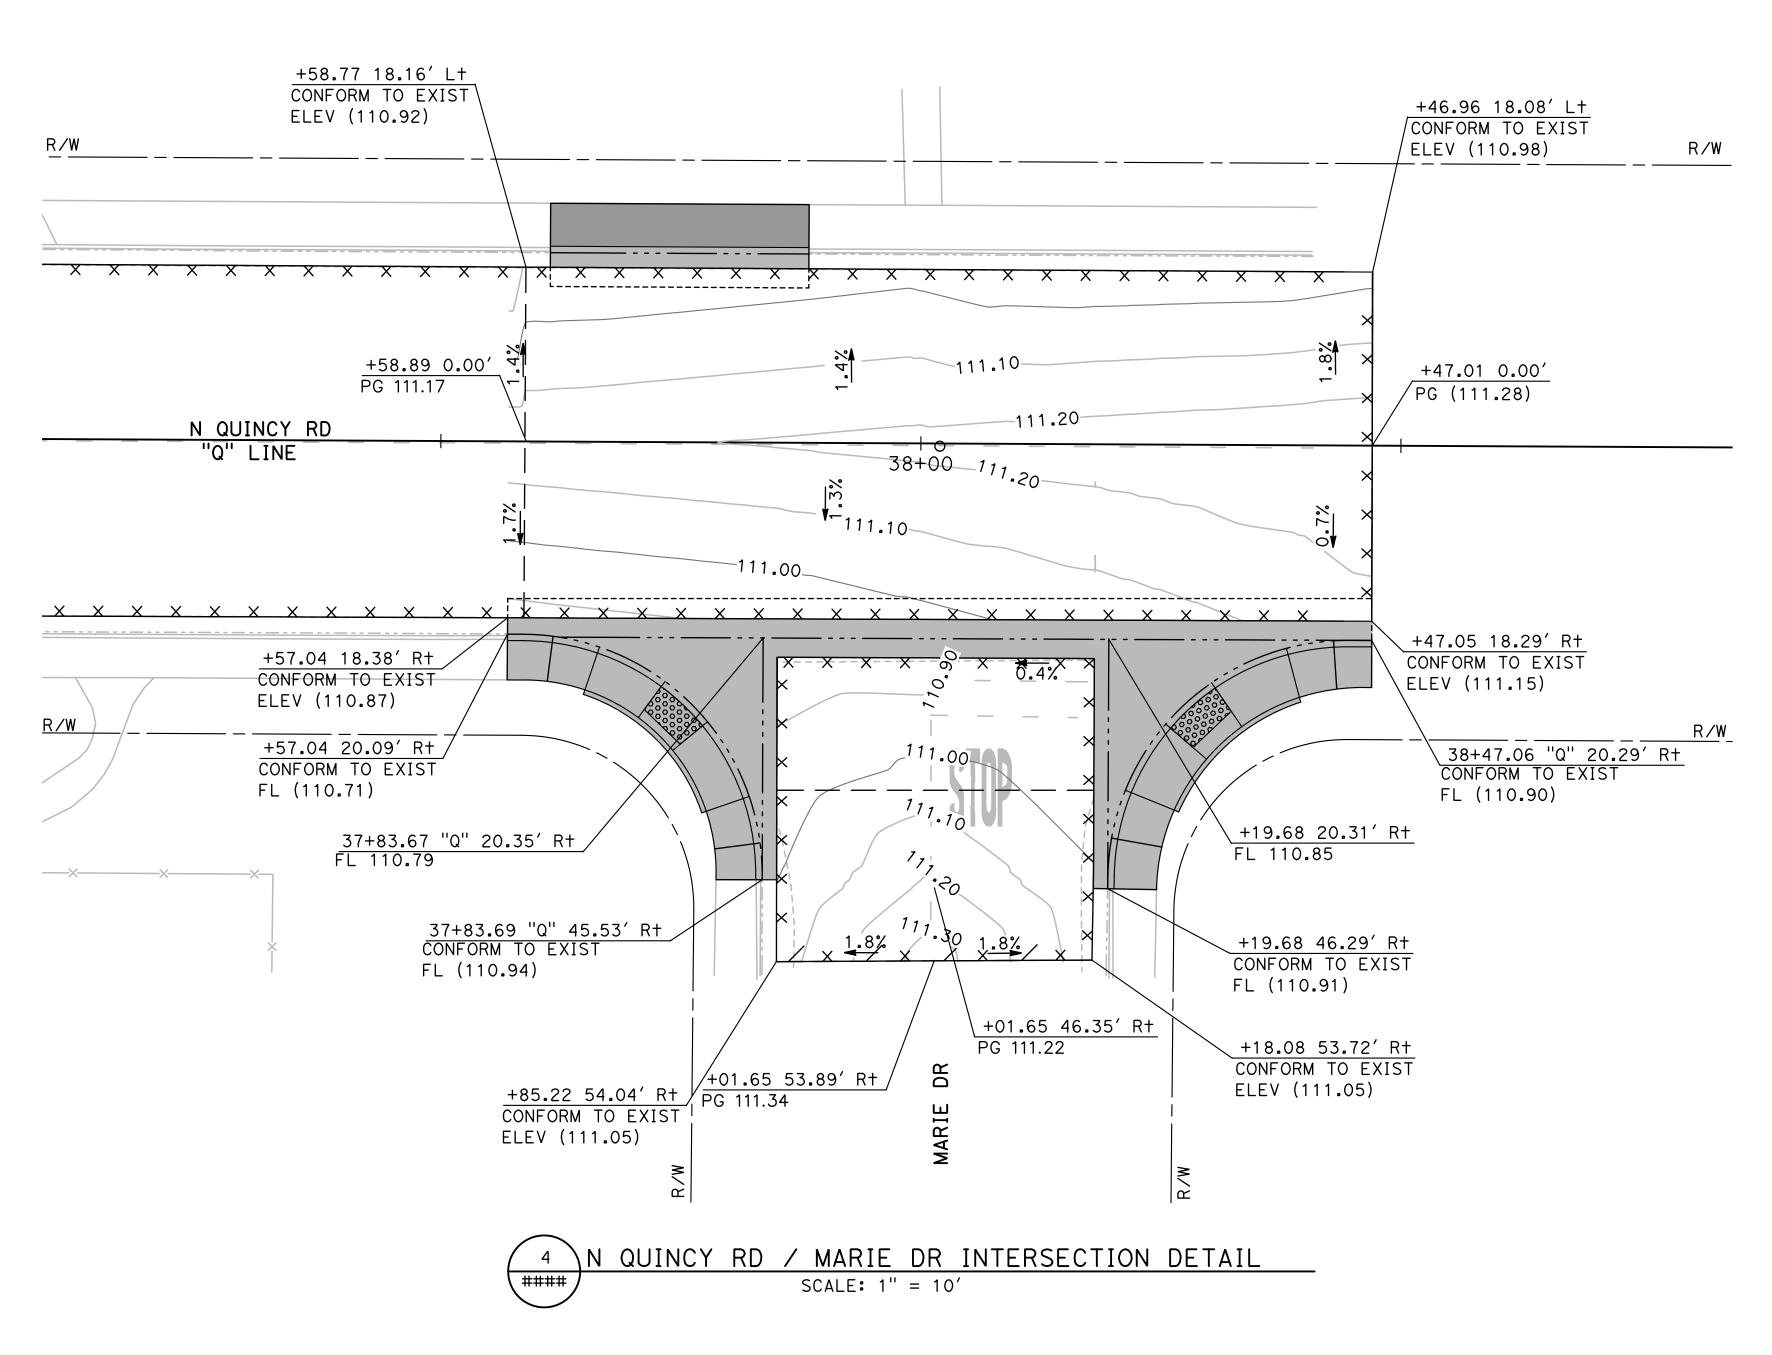

DESIGNED BY: ANGEL P.

DRAWN BY: ANGEL P.

CHECKED BY: JON H.


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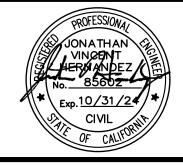
DATE: 4/2/2024

JOB NO.: 23-00109

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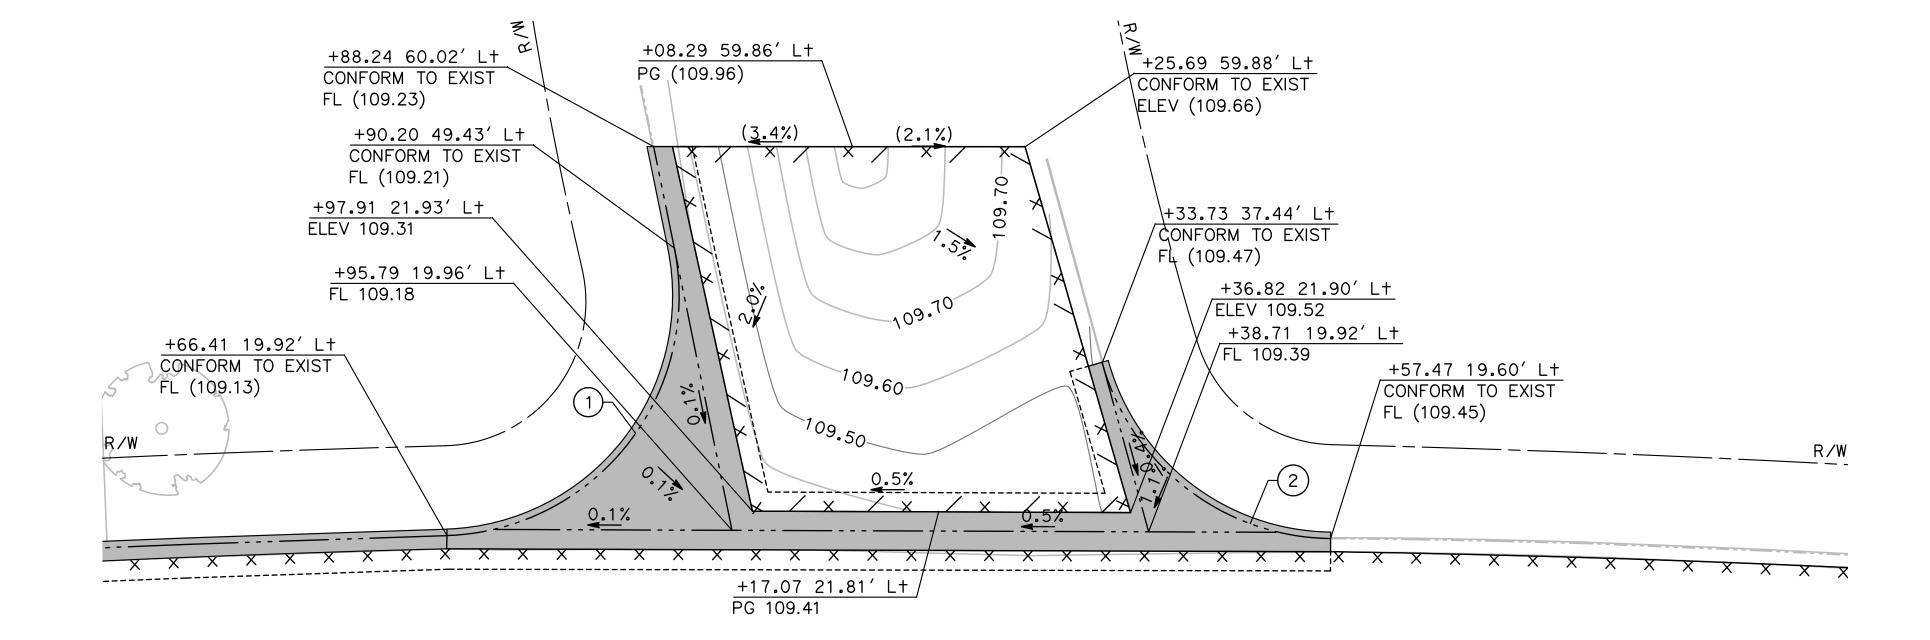


CITY OF TURLOCK ROADS PROGRAM - CIP GRADING PLAN N QUINCY RD


Sheet <u>73</u> of <u>109</u> Sheets

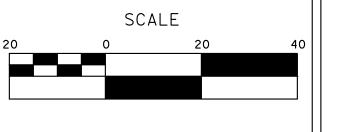ALL CALLOUTS ON THIS SHEET REFERENCE THE "CP" LINE UNLESS OTHERWISE NOTED.

SEE LEGEND ON SHEET G-1



CURVE TABLE				
R	Δ	Т	اــ	
25.00′	99° 40′25"	29.62′	43.49′	
25.00′	73°55′50"	18.82′	32.26′	
25.00′	77°39′51"	20.12′	33.89′	
24.00′	102°22′32"	29.84′	42.88′	
	R 25.00′ 25.00′ 25.00′	R	R	

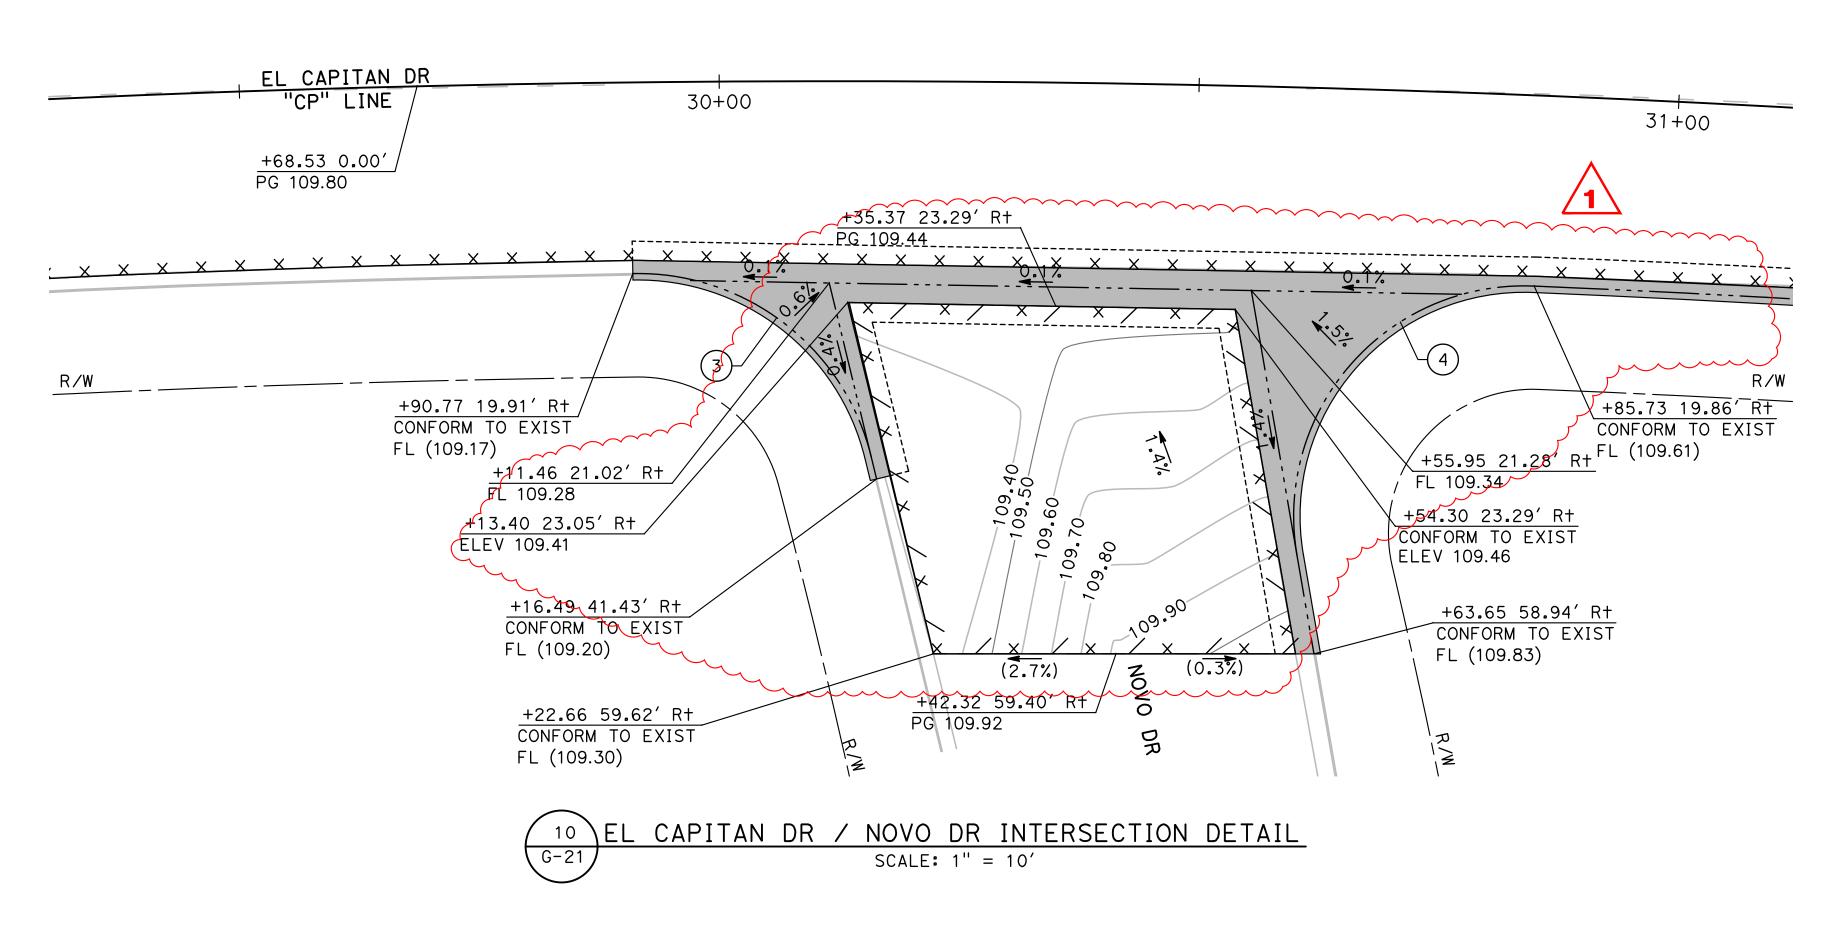

DESIGNED BY: ANGEL P.

DRAWN BY: ANGEL P.

CHECKED BY: JON H.


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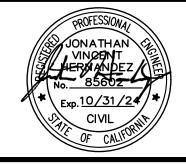
DATE: 4/2/2024

JOB NO.: 23-00109

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CITY OF TURLOCK


ROADS PROGRAM - CIP
GRADING PLAN
EL CAPITAN DRIVE

Sheet <u>79</u> of <u>109</u> Sheets

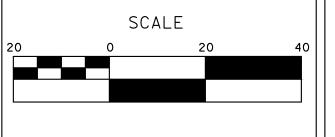ALL CALLOUTS ON THIS SHEET REFERENCE THE "CM2" LINE UNLESS OTHERWISE NOTED.

SEE LEGEND ON SHEET G-1

CURVE TABLE					
No. X	R	Δ	Т	L	
9	25.00′	75°12′03"	19.25′	32.81′	
10	25.00′	71°17′29"	17.93′	31.11′	
11	25.00′	70°41′52"	17.73′	30.85′	
12	25.00′	65° 32′25"	16.09′	28.60′	

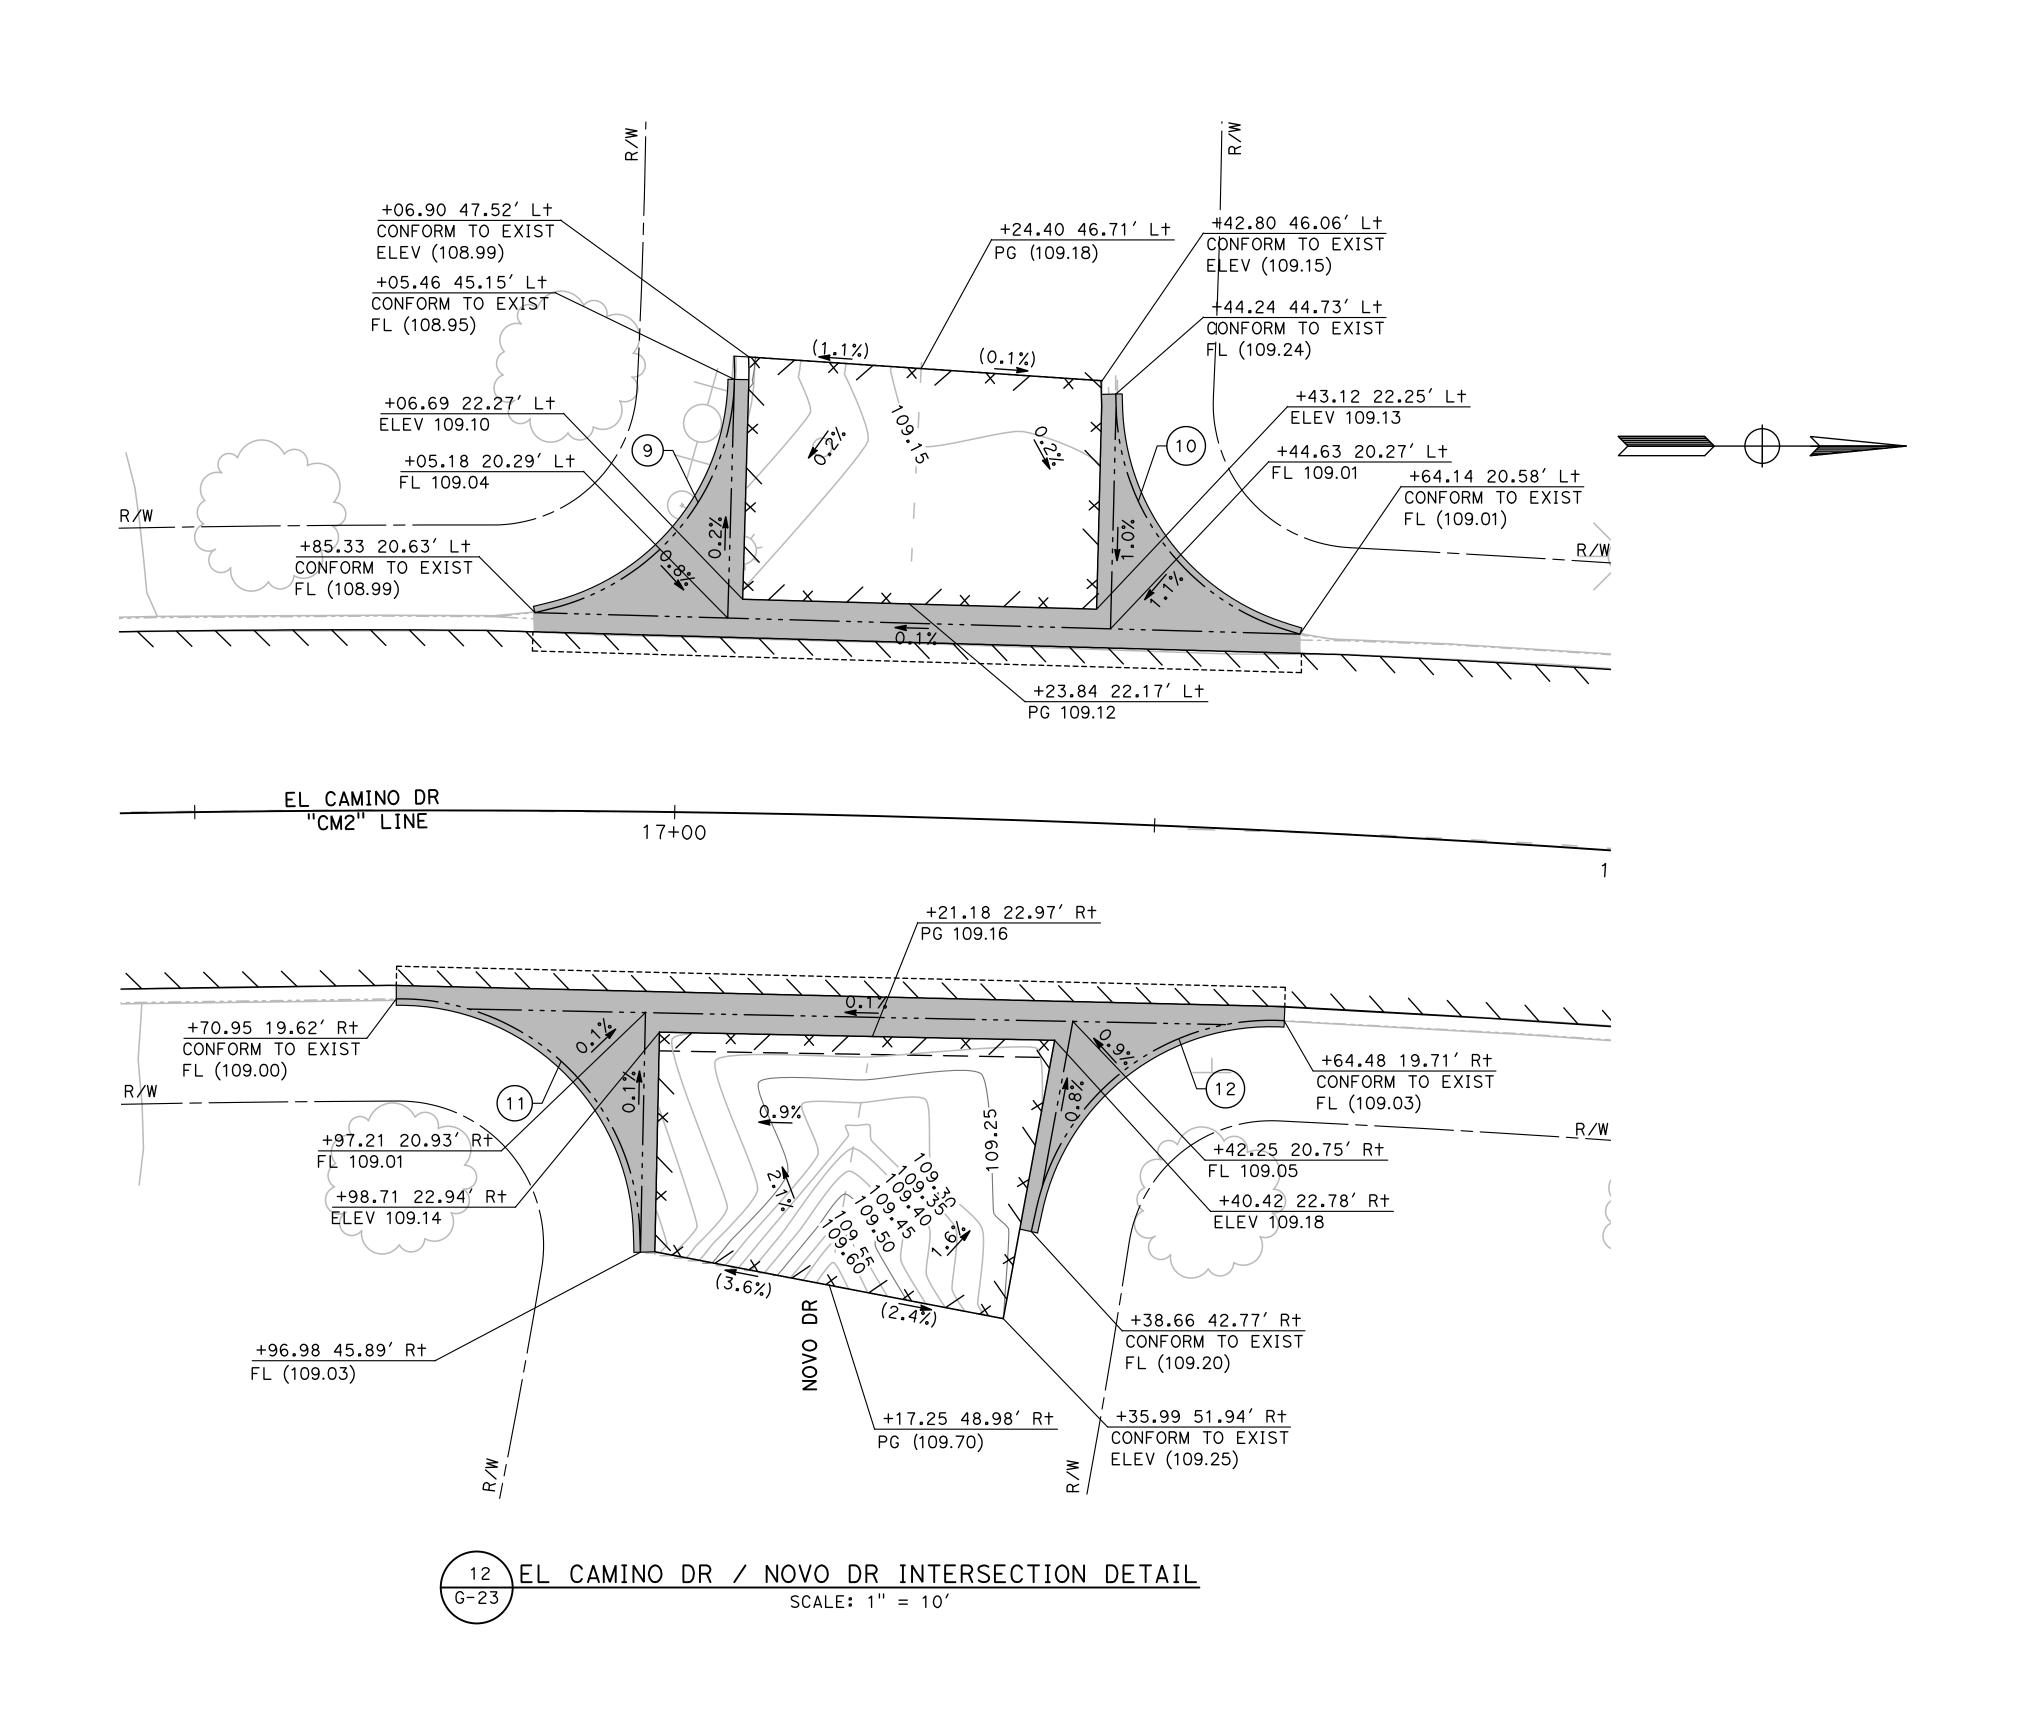

DESIGNED BY: ANGEL P.

DRAWN BY: ANGEL P.

CHECKED BY: JON H.

SCALE: AS SHOWN


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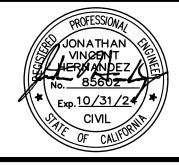
DATE: 4/2/2024

JOB NO.: 23-00109

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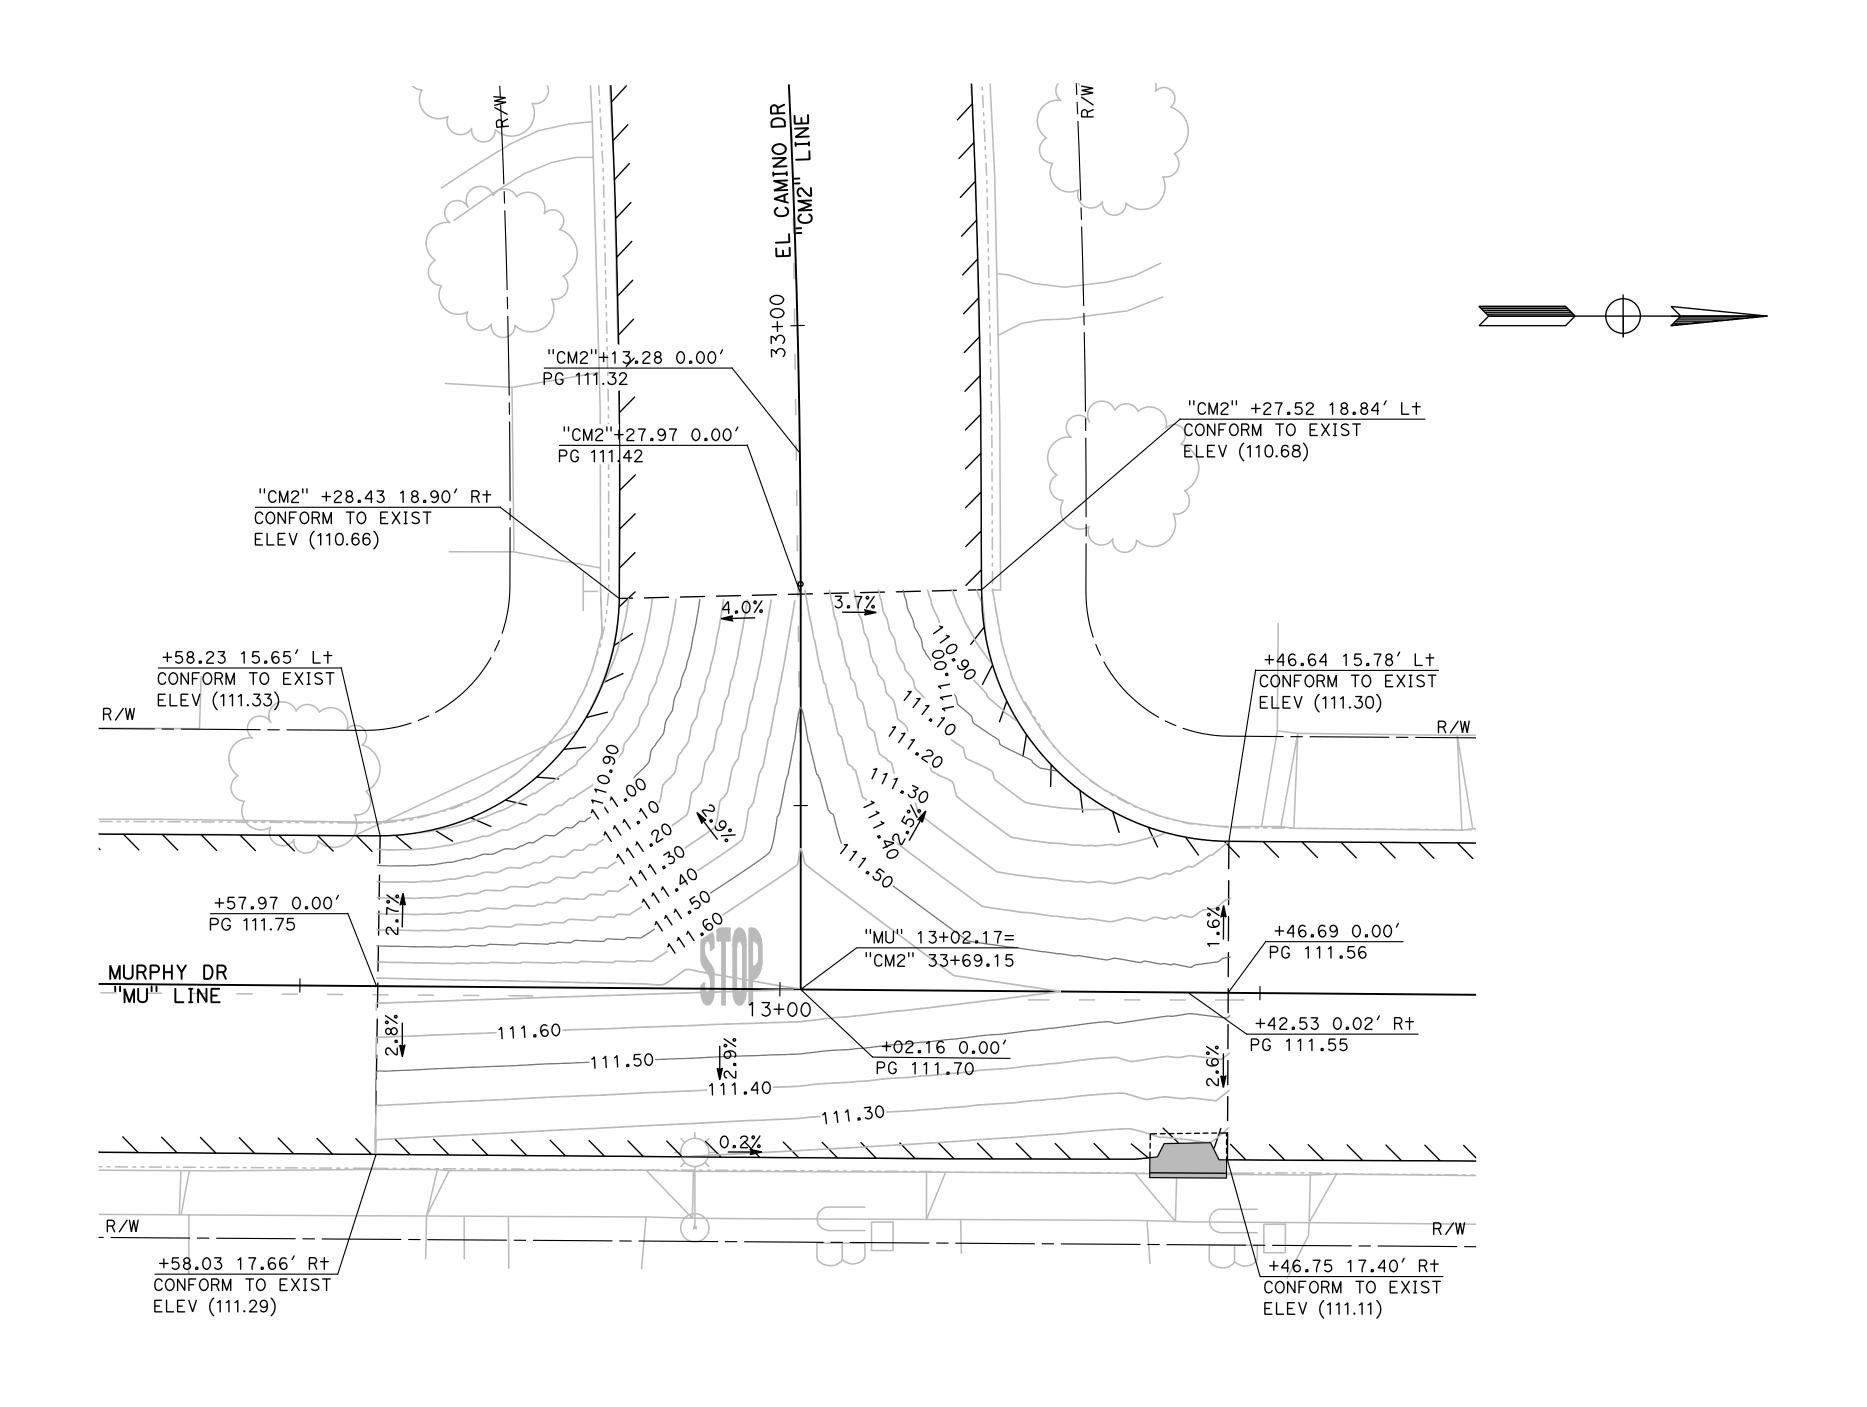
CITY OF TURLOCK

ROADS PROGRAM - CIP
GRADING PLAN
EL CAMINO DRIVE

Sheet <u>81</u> of <u>109</u> Sheets

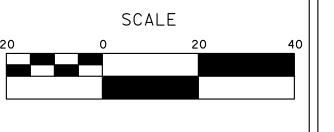ALL CALLOUTS ON THIS SHEET REFERENCE THE "MU" LINE UNLESS OTHERWISE NOTED.

SEE LEGEND ON SHEET G-1



MURPHY DR / EL CAMINO DR INTERSECTION DETAIL

SCALE: 1" = 10'

DESIGNED BY: ANGEL P.

DRAWN BY: ANGEL P.


CHECKED BY: JON H.

SCALE: AS SHOWN
DATE: 4/2/2024

JOB NO.: 23-00109

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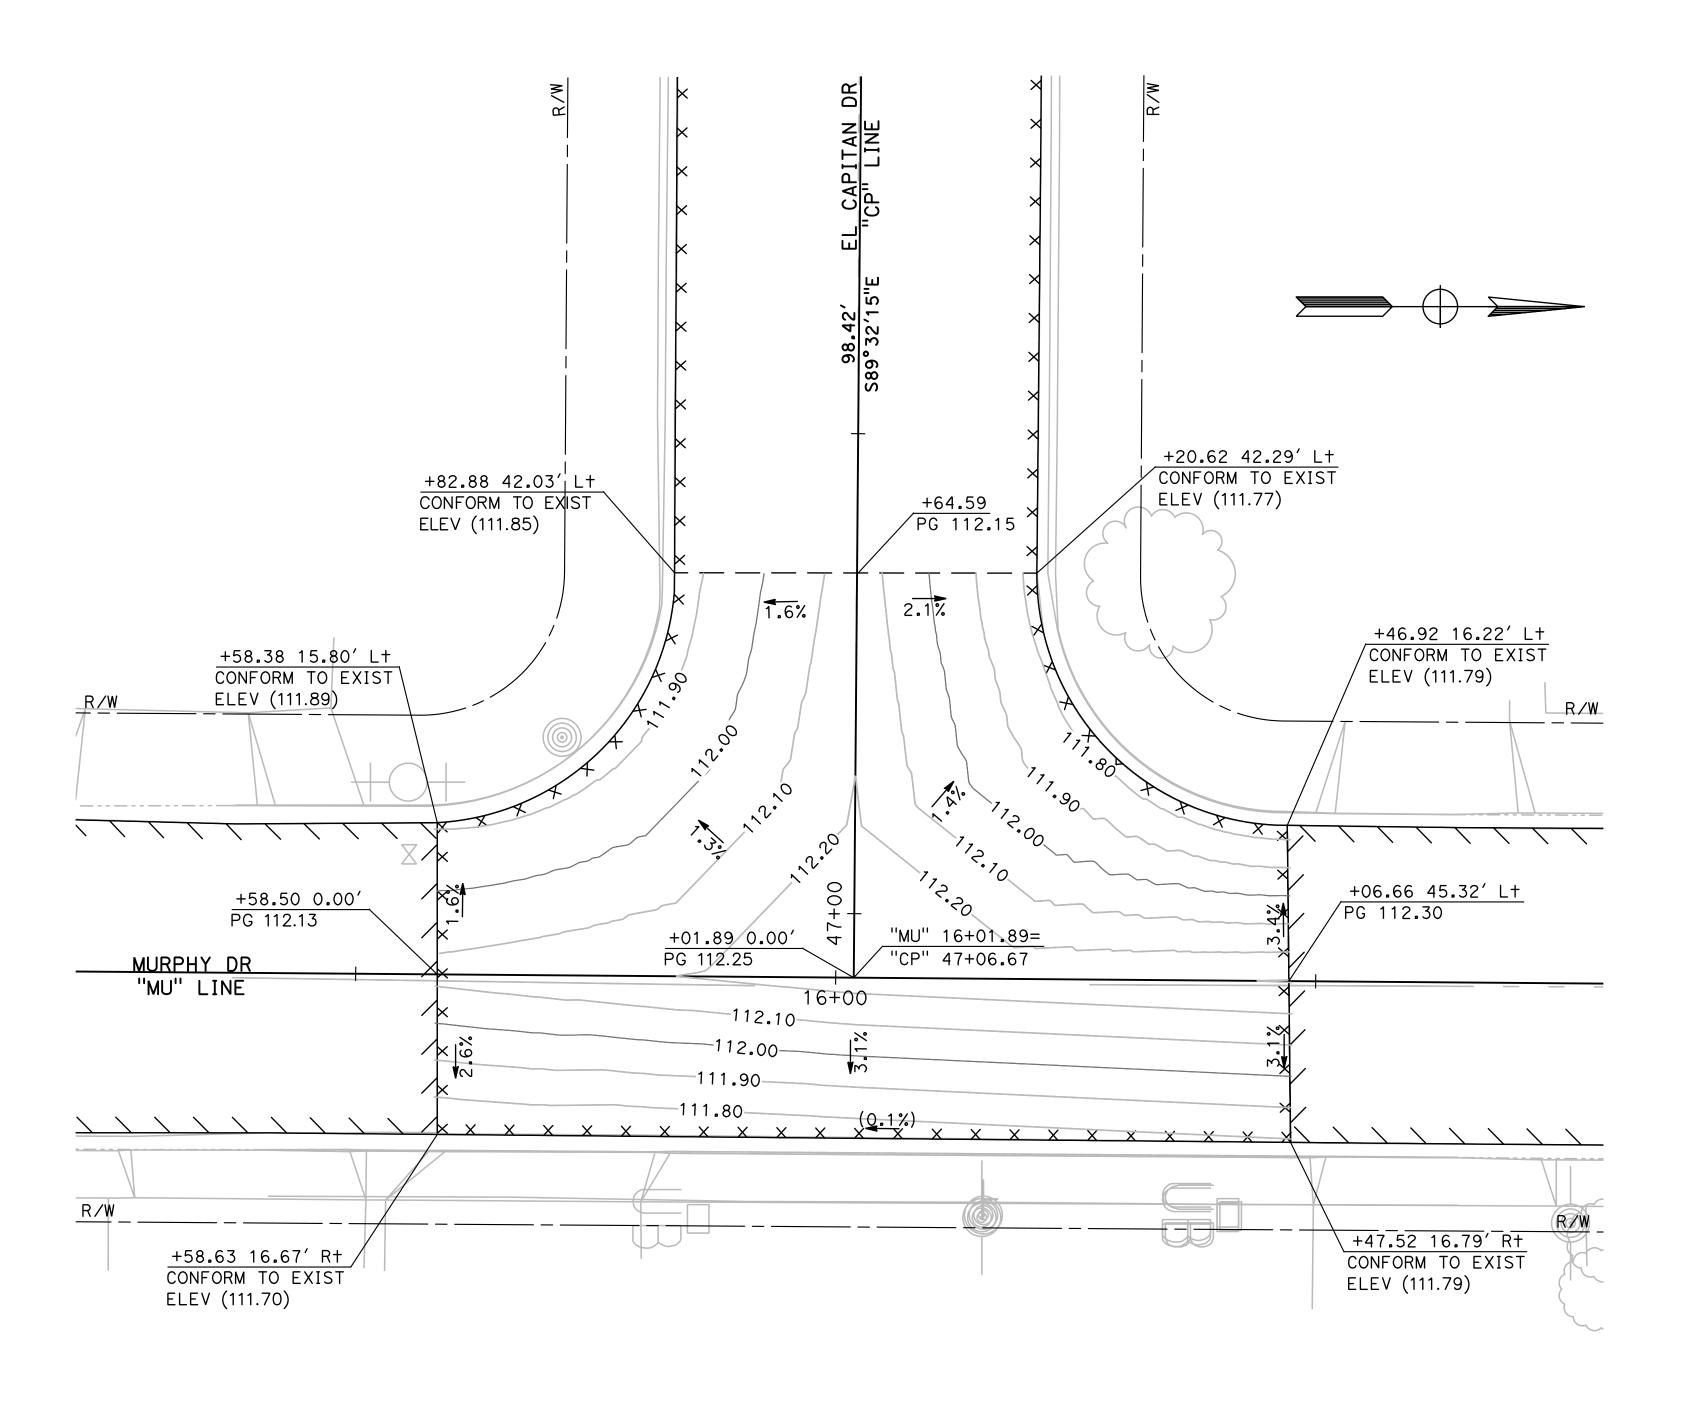


CITY OF TURLOCK ROADS PROGRAM - CIP GRADING PLAN MURPHY DRIVE

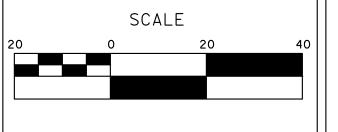Sheet <u>82</u> of <u>109</u> Sheets

ALL CALLOUTS ON THIS SHEET REFERENCE THE "CM2" LINE UNLESS OTHERWISE NOTED.

SEE LEGEND ON SHEET G-1



MURPHY DR / EL CAPITAN DR INTERSECTION DETAIL

SCALE: 1" = 10'

DESIGNED BY: ANGEL P.
DRAWN BY: ANGEL P.
CHECKED BY: JON H.


SCALE: AS SHOWN

DATE: 4/2/2024

JOB NO.: 23-00109

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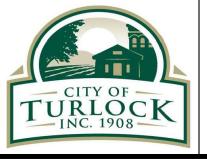




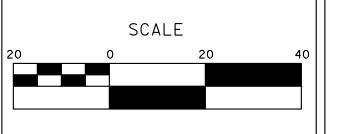

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PUBLIC WORKS DEPARTMENT
ENGINEERING DIVISION
156 S. BROADWAY SUIT 150
(209) 668-5520



CITY OF TURLOCK ROADS PROGRAM - CIP GRADING PLAN MURPHY DRIVE

Sheet <u>83</u> of <u>109</u> Sheets

TRAFFIC CONTROL GENERAL NOTES:

- 1. VALIDATION: THE TRAFFIC CONTROL PLAN IS NOT VALID UNTIL WORK DATES ARE APPROVED. THE CONTRACTOR SHALL, PER SECTION 601-2 OF THE CITY SUPPLEMENT TO THE STANDARD SPECIFICATIONS FOR PUBLIC WORKS CONSTRUCTION, CONTACT THE PUBLIC WORKS TRAFFIC CONTROL SECTION AT (209) 668-5590 TO OBTAIN A PERMIT. THE CONTRACTOR MUST SUBMIT A COMPLETED TRAFFIC CONTROL PERMIT FORM A MINIMUM OF TWO (2) WORKING DAYS PRIOR TO STARTING WORK, OR FIVE (5) WORKING DAYS WHEN WORK WILL AFFECT A TRAFFIC SIGNAL.
- 2. STANDARDS: THIS TRAFFIC CONTROL PLAN SHALL CONFORM TO EACH OF THE FOLLOWING MANUALS:


EDITION DESCRIPTION

CALIFORNIA MANUAL ON UNIFORM TRAFFIC CONTROL DEVICES (CA MUTCD) 2014


2016 CITY OF TURLOCK STANDARD SPECIFICATIONS AND DRAWINGS

2023 CALTRANS STANDARD PLANS

- 3. NOTIFICATIONS: THE CONTRACTOR SHALL NOTIFY RELEVANT AGENCIES A MINIMUM OF FIVE (5) WORKING DAYS PRIOR TO ANY EXCAVATION, CONSTRUCTION, OR TRAFFIC CONTROL.
- 4. THE CONTRACTOR SHALL NOTIFY PROPERTY OWNERS AND TENANTS A MINIMUM OF SEVEN (7) WORKING DAYS PRIOR TO CLOSURE OF DRIVEWAYS. THE CONTRACTOR SHALL POST SIGNS NOTIFYING THE PUBLIC A MINIMUM OF SEVEN (7) WORKING DAYS PRIOR TO CLOSURE OF STREETS.
- 5. POSTING PARKING RESTRICTIONS: THE CONTRACTOR SHALL POST "TOW-AWAY/NO PARKING SIGNS SEVENTY TWO (72) HOURS IN ADVANCE OF PARKING REMOVAL. SIGNS SHALL INDICATE SPECIFIC DAYS, DATES, AND TIMES OF RESTRICTIONS.
- 6. EXCAVATIONS: EXCEPT AS OTHERWISE SHOWN ON THE PLANS. TRENCHES SHALL BE BACKFILLED OR TRENCH-PLATED AT THE END OF EACH WORK DAY, AN ASPHALT RAMP SHALL BE PLACED AROUND EACH TRENCH PLATE TO PREVENT THE PLATE FROM BEING DISLODGED. CONTRACTOR SHALL MONITOR TRENCH PLATES DURING NON-WORKING HOURS TO ENSURE THAT THEY DO NOT BECOME DISLODGED, UPON COMPLETION OF EXCAVATION BACKFILL, THE CONTRACTOR SHALL PROVIDE A SATISFACTORY SURFACE FOR TRAFFIC, WHEN CONSTRUCTION OPERATIONS ARE NOT ACTIVELY IN PROGRESS, THE CONTRACTOR SHALL MAINTAIN ALL TRAVEL LANES, BIKE LANES, AND PEDESTRIAN WALKWAYS OPEN TO THE APPROPRIATE TRAFFIC EXCEPT AS OTHERWISE SHOWN ON THE PLANS.
- 7. RESTORATION OF TRAFFIC CONTROL DEVICES: THE CONTRACTOR SHALL REPAIR OR REPLACE TRAFFIC CONTROL DEVICES (INCLUDING TRAFFIC SIGNS, STRIPING, PAVEMENT MARKERS, PAVEMENT MARKINGS, LEGENDS, CURB MARKINGS, LOOP DETECTORS, TRAFFIC SIGNAL EQUIPMENT, ETC.) DAMAGED OR REMOVED AS A RESULT OF OPERATIONS AND NOT DESIGNATED FOR REMOVAL. REPAIRS AND REPLACEMENTS SHALL BE AT LEAST EQUAL TO EXISTING IMPROVEMENT.
- 8. TEMPORARY TRAFFIC SIGNAL DETECTION: THE CONTRACTOR SHALL INSTALL CITY APPROVED TEMPORARY VIDEO OR RADAR DETECTION WHEN EXISTING TRAFFIC SIGNAL DETECTION SYSTEMS ARE DAMAGED, DISABLED, OR BECOME INEFFECTIVE DUE TO CONSTRUCTION FOR A PERIOD OF FIVE (5) OR MORE DAYS. THE CONTRACTOR SHALL COMPLETELY REMOVE ALL TEMPORARY TRAFFIC SIGNAL DETECTION EQUIPMENT AND RESTORE/INSTALL A CITY APPROVED PERMANENT VEHICLE DETECTION SYSTEM UPON COMPLETION OF CONSTRUCTION. ALL INSTALLATION AND REMOVALS ARE SUBJECT TO APPROVAL BY THE CITY ENGINEER.
- 9. CHANGE IN WORK: THE CITY ENGINEER WILL OBSERVE THESE TRAFFIC CONTROL PLANS IN OPERATION AND RESERVE THE RIGHT TO MAKE ANY CHANGES AS FIELD CONDITIONS WARRANT, ANY CHANGES SHALL BE DOCUMENTED AND SUPERCEDE THESE PLANS.
- 10. OPEN TRENCH: THE CONTRACTOR SHALL PLACE "OPEN TRENCH" SIGNS (C27(CA)) ON TYPE BARRICADES WITHIN THE WORK ZONE, AHEAD OF ANY WORK AREA WHICH INCLUDES OPEN TRENCHES IN EXCESS OF THREE (3) INCHES IN DEPTH, PER CA MUTCD SECTION 6F.103 (CA) GUIDELINES.
- 11. FOR WORK NOT COVERED BY THESE TRAFFIC CONTROL PLANS: THE CONTRACTOR SHALL PREPARE TRAFFIC CONTROL WORKING DRAWINGS AND SUBMIT THEM TO THE CITY RESIDENT ENGINEER. THE CONTRACTOR SHALL ALLOW A MINIMUM OF TWENTY (20) WORKING DAYS FOR REVIEW OF THE WORKING DRAWINGS. UPON APPROVAL OF THE TRAFFIC CONTROL PLAN, THE PUBLIC WORKS TRAFFIC CONTROL SECTION WILL ISSUE A TRAFFIC CONTROL PLAN (TCP) PERMIT FOR THIS WORK.
- 12. CONTRACTOR SHALL INSTALL UNEVEN PAVEMENT SIGNS C46 (CA) ALONG THE EDGE OF AREAS WHERE A STEP OF GREATER THAN 2" EXISTS
- 13. CONTRACTOR HAS THE OPTION TO WORK AT MULTIPLE LOCATIONS CONCURRENTLY, ADJACENT BLOCKS SHALL NOT BE CLOSED AT THE SAME TIME.
- 14.SEE TABLE 6H-3 IN THE CALIFORNIA MANUAL ON UNIFORM TRAFFIC CONTROL DEVICES (CA MUTCD) FOR MEANING OF LETTER CODES ON TYPICAL APPLICATION DIAGRAMS.
- 15. CONTRACTOR SHALL DEPLOY FOUR (4) PORTABLE CHANGEABLE MESSAGE SYSTEMS (PCMS) THROUGHOUT CONSTRUCTION, WITH FINAL PLACEMENT TO BE DETERMINED BY ENGINEER.

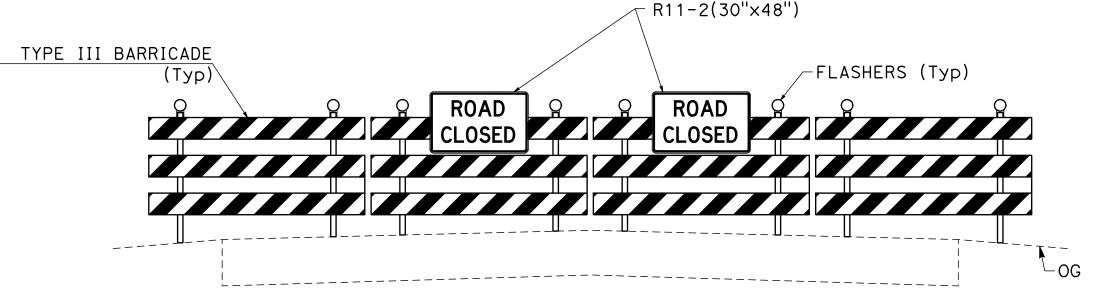

TEMPORARY BARRICADE ROAD CLOSURE DETAIL

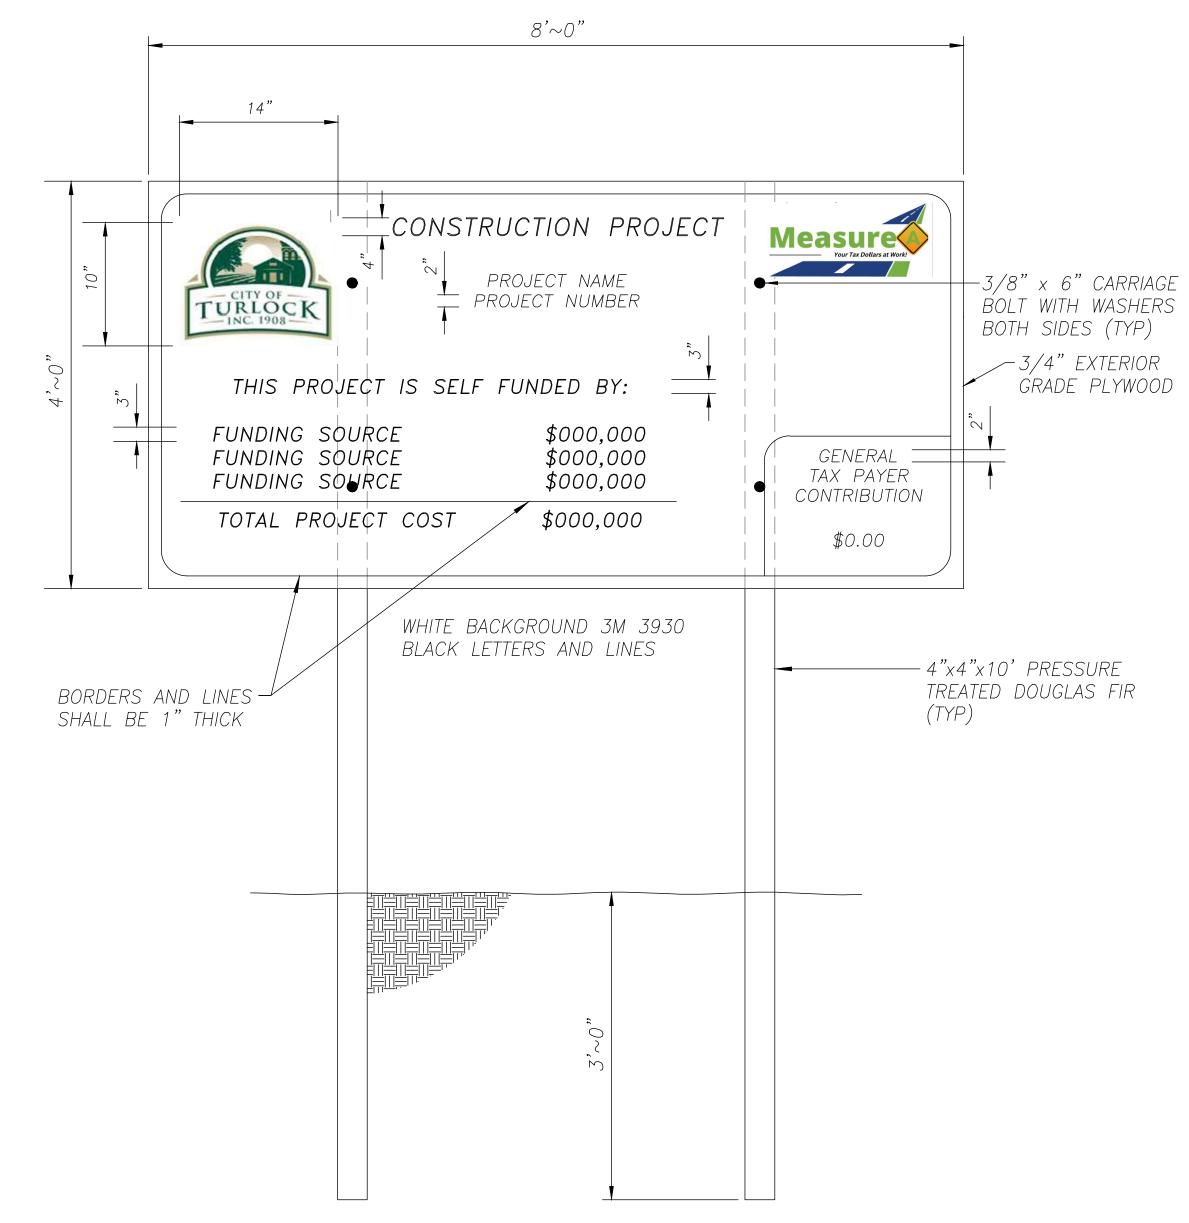

CONSTRUCTION FUNDING SIGN

ESIGNED BY: ANGEL P. ANGEL P. DRAWN BY: CHECKED BY: JON H. CALE: AS SHOWN

DATE: 4/2/2024

OB NO.: 23-00109

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TURLOCK

CITY OF TURLOCK **ROADS PROGRAM - CIP** TRAFFIC HANDLING PLANS TH-1

Sheet <u>84</u> **109** Sheets

