
CITY OF TURLOCK

CITY PROJECT NO. 23-040

WATER LINE REPLACEMENT FOR

2024 ROADS PROGRAM CONSTRUCTION

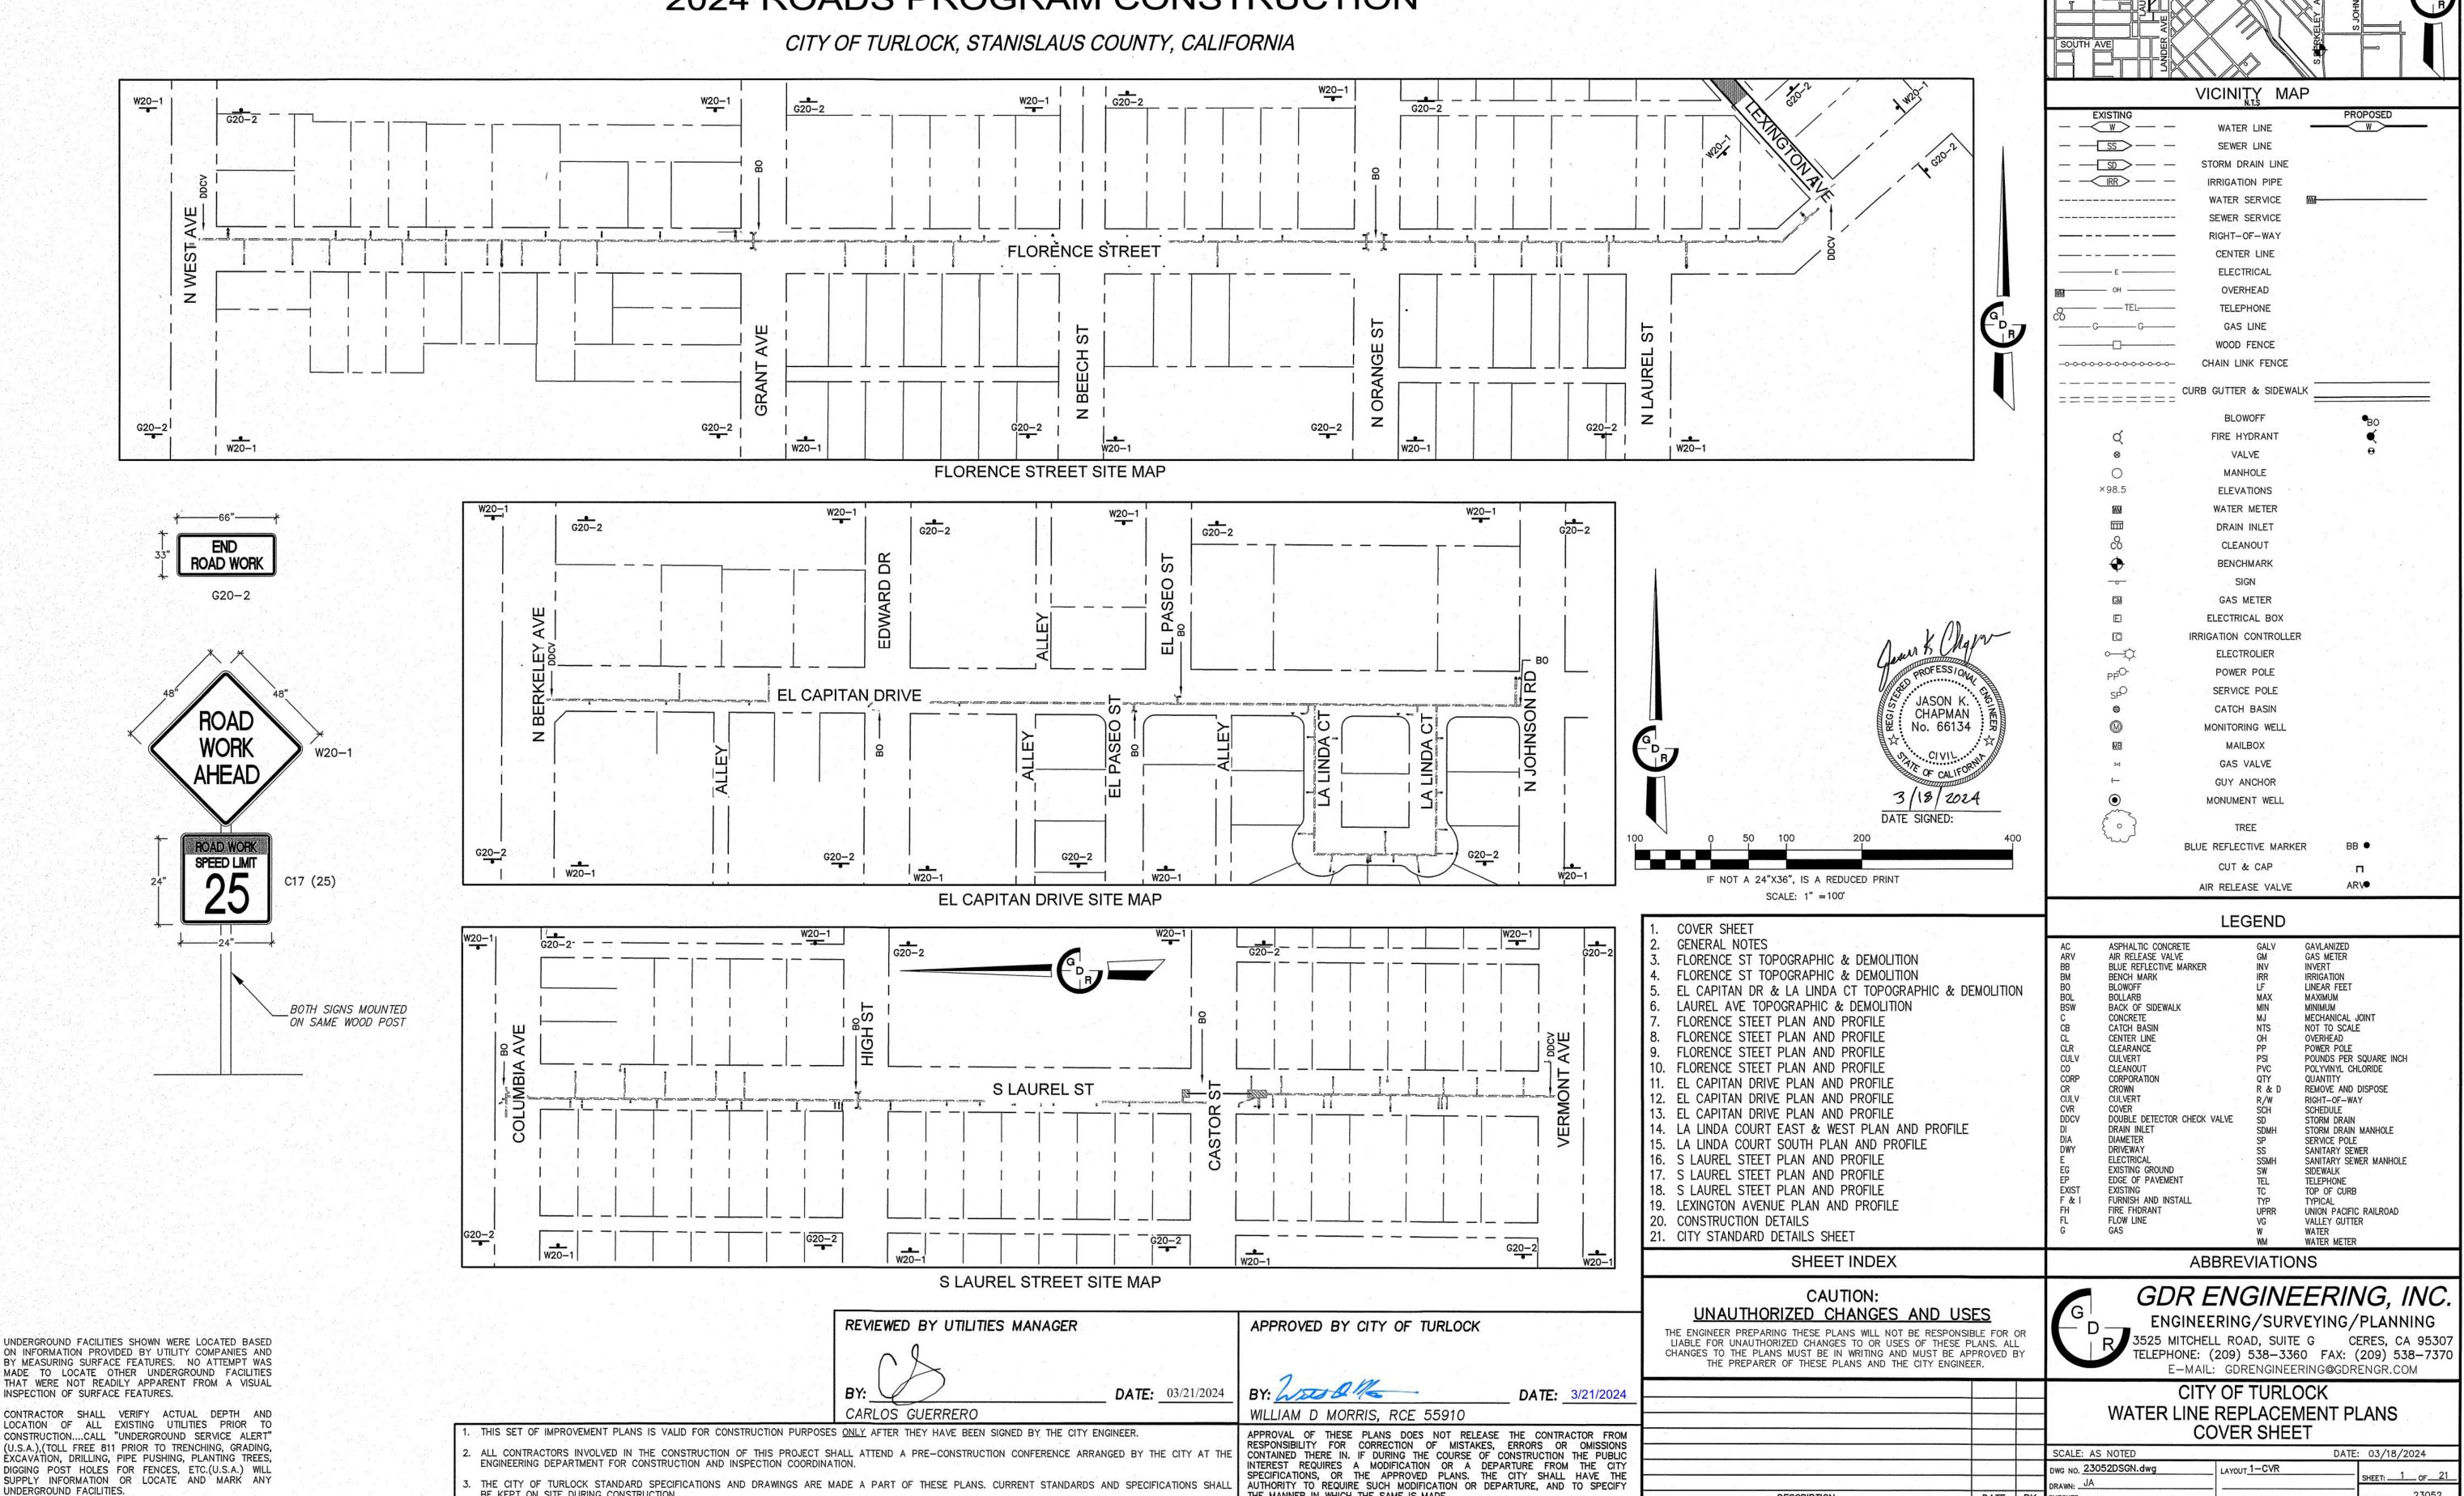

THE MANNER IN WHICH THE SAME IS MADE.

DATE BY CHECKED: _



ON INFORMATION PROVIDED BY UTILITY COMPANIES AND BY MEASURING SURFACE FEATURES. NO ATTEMPT WAS MADE TO LOCATE OTHER UNDERGROUND FACILITIES THAT WERE NOT READILY APPARENT FROM A VISUAL INSPECTION OF SURFACE FEATURES.

CONTRACTOR SHALL VERIFY ACTUAL DEPTH AND LOCATION OF ALL EXISTING UTILITIES PRIOR TO CONSTRUCTION....CALL "UNDERGROUND SERVICE ALERT" (U.S.A.), (TOLL FREE 811 PRIOR TO TRENCHING, GRADING, EXCAVATION, DRILLING, PIPE PUSHING, PLANTING TREES, DIGGING POST HOLES FOR FENCES, ETC.(U.S.A.) WILL SUPPLY INFORMATION OR LOCATE AND MARK ANY

BE KEPT ON SITE DURING CONSTRUCTION.

- 1. THESE PLANS HAVE BEEN CHECKED BY THE CITY OF TURLOCK AND/OR ITS AUTHORIZED REPRESENTATIVE, BUT SUCH CHECKING AND/OR APPROVAL DOES NOT RELIEVE THE CONTRACTOR FROM ITS RESPONSIBILITY TO CORRECT ERRORS, OMISSIONS OR MAKE CHANGES REQUIRED BY CONDITIONS DISCOVERED IN THE FIELD DURING THE COURSE OF CONSTRUCTION.
- 2. ALL REVISIONS TO THIS PLAN MUST BE REVIEWED BY THE CITY ENGINEER PRIOR TO CONSTRUCTION AND SHALL BE ACCURATELY SHOWN IN REVISED PLANS STAMPED AND SIGNED BY THE CITY PRIOR TO THE INSTALLATION OF THE IMPROVEMENTS.
- 3. THE IMPROVEMENTS ARE SUBJECT TO THE INSPECTION AND APPROVAL OF CITY OF TURLOCK ENGINEERING. CONTACT ENGINEERING DIVISION AT LEAST TWO (2) WORKING DAYS PRIOR TO START ANY WORK TO ARRANGE FOR INSPECTION.
- 4. NOTIFY UNDERGROUND SERVICE ALERT (USA) 811 AT LEAST TWO (2) WORKING DAYS PRIOR TO EXCAVATION.
- 5. IF NECESSARY TO CONFIRM FIELD LOCATIONS OF FACILITIES, EXPLORATORY TRENCHING OR

POTHOLING SHALL BE DONE AT THE EXPENSE OF CONTRACTOR.

- 6. IF A CONFLICT OCCURS BETWEEN THE CITY OF TURLOCK IMPROVEMENT STANDARDS AND THE RECOMMENDATIONS BY THE DESIGN ENGINEER AND/OR SOILS ENGINEER, THE MORE STRINGENT SHALL APPLY AS DIRECTED BY THE CITY ENGINEER.
- 7. BASIS OF ELEVATION DATUM SHALL BE PROVIDED (IF CITY/COUNTY BENCHMARK, GIVE NUMBER, LOCATION AND ELEVATION).
- EXISTING UTILITIES SHALL NOT BE INTERRUPTED UNTIL THE UTILITY COMPANY HAS PROVIDED ALTERNATIVE SERVICE FACILITIES. THE CONTRACTOR SHALL COOPERATE AND COORDINATE HIS WORK WITH APPROPRIATE AGENCIES AND UTILITY COMPANIES.
- FINAL PAVEMENT WORK SHALL NOT OCCUR WITHIN THE CITY RIGHT-OF-WAY PRIOR TO COMPLETION OF UTILITY RELOCATION WITHOUT THE SPECIFIC APPROVAL OF THE CITY ENGINEER.
- 10. ALL CONSTRUCTION STAKING WATER LINES, FIRE HYDRANTS ETC. SHALL BE DONE BY REGISTERED CIVIL ENGINEER OR LICENSED LAND SURVEYOR.
- 11. ALL AREA UNDERGOING ALL CONSTRUCTION ACTIVITIES SHALL BE WATERED. OR OTHER DUST-PALLIATIVE MEASURES USED, TO PREVENT DUST, AS CONDITIONS WARRANT. WATER TRUCKS SHALL BE AVAILABLE AT ALL TIMES.
- 12. PRIOR TO RECEIVING/TAKING ANY WATER FROM THE CITY OF TURLOCK WATER SYSTEM THE CONTRACTOR SHALL ACQUIRE A CITY WATER METER OR CITY FIRE HYDRANT METER PER THE SPECIAL PROVISIONS. ALL WATER USAGE SHALL BE METERED.
- 13. ANY DAMAGE CAUSED BY TRENCHING TO EXISTING UNDERGROUND UTILITIES SHALL BE THE SOLE RESPONSIBILITY OF THE CONTRACTOR AND SHALL BE REPLACED AT HIS/HER EXPENSE.
- 14. TRAFFIC CONTROL PLAN SHALL BE SUBMITTED TO THE CITY OF TURLOCK ENGINEERING DIVISION FOR APPROVAL PER THE SPECIAL PROVISIONS.
- 15. ANY STREET MONUMENTS, LOT CORNER, BENCHMARKS AND OTHER PERMANENT PIPE OR MONUMENTS DISTURBED DURING THE PROCESS OF CONSTRUCTION SHALL BE REPLACED BY THE LICENSED LAND SURVEYOR
- 16. EROSION CONTROL PLAN MUST BE PREPARED CONSISTENT TO CITY STANDARDS.
- 17. DISPOSAL OF WATER TO CITY SANITARY SEWER SYSTEM IS PROHIBITED.
- 18. THE MANNER OF BRACING AND SHORING EXCAVATIONS SHALL BE AS SET FORTH IN THE RULES. ORDERS AND REGULATIONS OF THE STATE OF CALIFORNIA CONSTRUCTION SAFETY ORDERS, DIVISION OF INDUSTRIAL SAFETY.
- 19. PRIOR TO BEGIN WORK, CONTRACTOR SHALL ATTEND A PRE-CONSTRUCTION MEETING WITH THE CITY OF TURLOCK.

CONSTRUCTION NOTES AND SPECIFICATIONS

- CONNECTIONS TO EXISTING WATER MAINS SHALL BE MADE BY THE CONTRACTOR WITH CITY INSPECTOR PRESENT, CONTRACTOR SHALL EXCAVATE THE AREA AND PROVIDE ALL MATERIALS REQUIRED.
- 2. OPERATION OF WATER VALVES OR OTHER CONTROL DEVICES SHALL ONLY BE DONE BY CITY OF TURLOCK CREWS.
- 3. 1" WATER LINES SHALL BE 1" ULTRA HIGH MOLECULAR WEIGHT (UHMW) POLYETHYLENE, SDR 7 (IPS), 160 PSI RATING CONFORMING TO THE LATEST EDITION OF THE UNIFORM PLUMBING CODE AND THE REQUIREMENTS OF THE CITY OF TURLOCK BUILDING DEPARTMENT.
- 4. ALL WATER MAINS 4" AND LARGER SHALL BE POLYVINYL CHLORIDE PIPE (PVC) CLASS 235 PSI (DR 18) (PIPE SIZE: 4" TO 12") CONFORMING TO AWWA C900-07. DUCTILE IRON FITTINGS INCLUDING TEES. CROSSES. CAPS. ETC. SHALL BE FLANGE. MECHANICAL JOINT OR COMBINATION THEREOF. MECHANICAL JOINT COUPLINGS SHALL CONFORM TO ANSI A21.10 (AWWA C110-77). ALL COUPLINGS SHALL BE CEMENT MORTAR LINED IN ACCORDANCE WITH AWWA C104-80 AND SHALL BE FURNISHED WITH RUBBER RING SEAL JOINTS DESIGNED TO BE USED WITH CLASS 235 PSI (DR 18) PVC PIPE, AWWA C900-07.
- 5. ALL WATER LINES SHALL BE INSTALLED WITH 36" MINIMUM COVER FROM FINISH GRADE. THE CONTRACTOR SHALL VERIFY THE LOCATION AND THE ELEVATION OF EXISTING WATER LINES PRIOR TO BEGINNING CONSTRUCTION.
- 6. WATER SERVICES SHALL BE INSTALLED AT LOCATIONS AS SHOWN ON THE PLAN, OR AT LOCATIONS AS DETERMINED BY THE CITY ENGINEER, IF ADDITIONAL SERVICES ARE REQUIRED.
- 7. WATER LINES SHALL BE CHLORINATED AND TESTED IN ACCORDANCE WITH THE SPECIAL PROVISIONS AND THE TEST RESULTS SHALL BE APPROVED BY THE CITY OF TURLOCK PRIOR TO THE CONNECTION TO THE CITY WATER SYSTEM. THE FIRST TEST WILL BE PROVIDED AT NO CHARGE TO THE CONTRACTOR. ALL RETEST SHALL BE CHARGED TO THE CONTRACTOR AT A RATE AS NOTED IN THE PROJECT SPECIAL PROVISIONS.
- . ABANDON IN-PLACE EXISTING WATER LINES AND SERVICE LINES AND ASSOCIATED WATER VALVES. PLUG ALL OPEN ENDS OF ABANDONED WATER LINES, ALL EXISTING VALVE BOXES AND PVC RISERS SHALL BE REMOVED. CHRISTY G-5 VALVE BOXES MAY BE REUSED BY THE CONTRACTOR ON THIS PROJECT, ALL OTHER STYLE BOXES MAY NOT BE REUSED ALL WATER METERS. BOXES AND LIDS SHALL BE SALVAGED AND REUSED IN THIS PROJECT. IF ANY COMPONENT IS DEEMED NOT TO BE IN SATISFACTORY CONDITION BY THE CITY; A CHANGE ORDER ITEM SHALL BE PREPARED TO COMPENSATE THE CONTRACTOR FOR NEW MATERIALS. THE CONTRACTOR SHALL REMOVE THE ENTIRE PANEL OF CONCRETE BOUND BY COLD JOINTS AND REPLACE CONCRETE, TYPICAL OF ALL METER BOX LOCATIONS IN SIDEWALK, UNLESS NOTED OTHERWISE ON THE PLANS.
- 9. ALL LINES ABANDONED DURING CONSTRUCTION SHALL BE REMOVED UNLESS OTHERWISE NOTED ON
- 10. WATER LINE CROSSING UNDER SEWER OR STORM SHALL HAVE COUPLING AND JOINTS GREATER THAN OR EQUAL TO 10 FEET FROM THE CLOSEST EDGE OF EXISTING PIPELINE.
- 11. WATER LINE CROSSING UNDER SEWER OR STORM SYSTEM SHALL BE DR-14 FOR A MINIMUM OF 10 FEET ON EACH SIDE OF THE CROSSING. SEE CITY STANDARD DETAIL W-14 FOR STANDARD WATER UNDER CROSSING.

CONSTRUCTION NOTES AND SPECIFICATIONS

<u>SURVEYING</u>

- 1. CITY BENCHMARK: 23-4-5; U S C & G S BRASS PLUG D942 SOUTH WEST CORNER OF IRRIGATION BOX, SOUTH WEST CORNER OF EAST AVENUE AND BERKELEY AVENUE. ELEVATION: 108.932
- 2. THE CONTRACTOR SHALL EXERCISE DUE CAUTION AND SHALL CAREFULLY PRESERVE BENCHMARKS. CONTROL POINTS, REFERENCE POINTS AND ALL SURVEY STAKES, AND SHALL BEAR ALL EXPENSES FOR REPLACEMENT AND/OR ERRORS CAUSED BY THEIR UNNECESSARY LOSS OR DISTURBANCE.
- 3. THESE PLANS HAVE BEEN PREPARED WITH THE INTENT THAT GDR ENGINEERING, INC. WILL BE PERFORMING THE CONSTRUCTION STAKING FOR THE PROJECT. IF GDR ENGINEERING, INC. DOES NOT PERFORM SUCH STAKING, THEN NOTICE IS HEREBY GIVEN THAT GDR ENGINEERING, INC. WILL NOT ASSUME RESPONSIBILITY FOR ERRORS AND OMISSIONS, IF ANY, WHICH COULD HAVE BEEN AVOIDED, CORRECTED OR OTHERWISE RESOLVED HAD GDR ENGINEERING, INC. PERFORMED THE CONSTRUCTION STAKING FOR THE PROJECT.

1. DUST CONTROL MEASURES SHALL INCLUDE THE FOLLOWING:

- A. THE CONTRACTOR IS RESPONSIBLE TO FOLLOW THE (CASQA) BMP'S ASSOCIATED WITH THIS PROJECT.
- B. THE CONTRACTOR SHALL OBTAIN A DUST CONTROL PERMIT FROM THE SAN JOAQUIN VALLEY AIR POLLUTION CONTROL DISTRICT.
- C. MATERIALS TRANSPORTED OFF-SITE SHALL BE COVERED, WETTED, OR 6 INCHES OF FREEBOARD PROVIDED TO LIMIT VISIBLE DUST EMISSIONS.
- D. ALL OPERATIONS SHALL LIMIT OR REMOVE THE ACCUMULATION OF MUD OR DIRT FROM ADJACENT PUBLIC STREETS AT THE END OF THE DAY.
- E. ALL STORAGE PILES SHALL BE STABILIZED WITH WATER OR CHEMICALS.

GENERAL

- ALL IMPROVEMENTS SHALL BE CONSTRUCTED IN ACCORDANCE WITH THESE APPROVED PLANS AND SPECIFICATIONS AND THE FOLLOWING:
- CITY OF TURLOCK STANDARD SPECIFICATIONS AND DRAWINGS.

CALIFORNIA DEPARTMENT OF TRANSPORTATION STANDARD SPECIFICATIONS (CALTRANS STANDARD SPECIFICATIONS) LATEST EDITION, AS REFERENCED IN THE PLANS AND CITY STANDARDS.

CONTRACT CHANGE ORDERS ISSUED BY THE CITY ENGINEER.

- IN ABSENCE OF MORE DETAILED REQUIREMENTS PROVIDED IN PROJECT PLANS AND SPECIFICATIONS AND LOCAL AGENCY STANDARDS, IT IS INTENDED THAT CONSTRUCTION AND INSTALLATION OF MATERIALS SHALL BE DONE IN ACCORDANCE WITH MANUFACTURER'S RECOMMENDATIONS.
- THIS SET OF IMPROVEMENT PLANS IS VALID FOR CONSTRUCTION PURPOSES ONLY AFTER BEING SIGNED BY THE CITY ENGINEER.
- ALL WORK SHALL BE INSPECTED BY THE CITY OF TURLOCK AND CONTRACTOR SHALL REQUEST INSPECTIONS AND TESTING IN ACCORDANCE WITH THE CITY OF TURLOCK STANDARD SPECIFICATIONS AND OTHER DOCUMENTS THAT MAY BE IDENTIFIED BY CITY AND/OR OWNER REGARDING INSPECTION AND TESTING REQUIREMENTS.
- NO WORK SHALL BE STARTED IN THE PUBLIC RIGHT-OF-WAY UNTIL AN ENCROACHMENT PERMIT IS ISSUED FROM THE CITY OF TURLOCK DEPARTMENT OF PUBLIC WORKS. COSTS OF OBTAINING PERMIT AND COMPLYING WITH CONDITIONS OF PERMIT SHALL BE INCLUDED IN THE BID PRICE FOR THE VARIOUS ITEMS OF WORK INVOLVED.
- UNDERGROUND FACILITIES SHOWN ON THE PLANS WERE LOCATED USING INFORMATION PROVIDED BY UTILITY COMPANIES AND BY MEASURING SURFACE FEATURES. NO ATTEMPT WAS MADE TO LOCATE ANY OTHER UNDERGROUND FACILITIES THAT WERE NOT SHOWN ON UTILITY COMPANY PLANS OR WERE NOT READILY APPARENT FROM INSPECTION OF SURFACE FEATURES. THE ENGINEER DOES NOT GUARANTEE THESE LOCATIONS TO BE EITHER TRUE OR EXACT.

PRIOR TO COMMENCING ANY WORK, IT SHALL BE THE CONTRACTOR'S RESPONSIBILITY TO HAVE EACH UTILITY COMPANY LOCATE, IN THE FIELD, THEIR MAIN AND SERVICE LINES. THE CONTRACTOR SHALL NOTIFY MEMBERS OF THE UNDERGROUND SERVICE ALERT (U.S.A.) 48 HOURS IN ADVANCE OF PERFORMING ANY EXCAVATION WORK BY CALLING THE TOLL-FREE NUMBER (800)227-2600. THE CONTRACTOR SHALL RECORD THE U.S.A. ORDER NUMBER AND HAVE THE ORDER NUMBER AVAILABLE TO OWNER AND ENGINEER PRIOR TO ANY EXCAVATION.

THE CONTRACTOR SHALL HAVE SOLE RESPONSIBILITY TO PROTECT ALL EXISTING UTILITIES SO THAT NO DAMAGE RESULTS TO THEM DURING THE PERFORMANCE OF THIS CONTRACT. ANY REPAIRS NECESSARY TO DAMAGED UTILITIES SHALL BE PAID FOR BY THE CONTRACTOR. THE CONTRACTOR SHALL BE REQUIRED TO COORDINATE AND COOPERATE WITH OTHER CONTRACTORS AND UTILITY COMPANIES INSTALLING NEW STRUCTURES, UTILITIES AND SERVICE

PRIOR TO CONSTRUCTION. THE CONTRACTOR SHALL HAVE SOLE RESPONSIBILITY TO FIELD VERIFY ALL EXISTING IMPROVEMENTS, BOTH HORIZONTALLY AND VERTICALLY, AND TO EXPOSE ALL EXISTING UNDERGROUND UTILITIES RELATED TO THE PROJECT, INCLUDING BUT NOT LIMITED TO, SEWER, STORM DRAIN, WATER, IRRIGATION, GAS, ELECTRICAL, ETC. AND SHALL NOTIFY THE ENGINEER IN WRITING FORTY-EIGHT (48) HOURS IN ADVANCE OF EXPOSING THE UTILITIES, SO THAT THE LOCATION AND ELEVATION CAN BE VERIFIED AND DOCUMENTED. THIS WORK SHALL BE INCLUDED IN THE BID PRICE FOR THE VARIOUS ITEMS OF WORK INVOLVED. IF LOCATION AND/OR ELEVATION DIFFERS FROM THAT SHOWN ON THE DESIGN PLANS, PROVISIONS TO ACCOMMODATE NEW LOCATION/ELEVATION MUST BE MADE, IN WRITING BY THE ENGINEER, PRIOR TO START OF CONSTRUCTION.

CONTRACTOR AGREES THAT HE SHALL ASSUME SOLE AND COMPLETE RESPONSIBILITY FOR JOB SITE CONDITIONS DURING THE COURSE OF CONSTRUCTION OF THIS PROJECT, INCLUDING SAFETY OF ALL PERSONS AND PROPERTY; THAT THIS REQUIREMENT SHALL APPLY CONTINUOUSLY AND NOT BE LIMITED TO NORMAL WORKING HOURS; AND THAT THE CONTRACTOR SHALL DEFEND, INDEMNIFY AND HOLD THE OWNER, ENGINEER AND THE CITY HARMLESS FROM ANY AND ALL LIABILITY, REAL OR ALLEGED, IN CONNECTION WITH THE PERFORMANCE OF WORK ON THE PROJECT, EXCEPTING FOR LIABILITY ARISING FROM THE SOLE NEGLIGENCE OF THE OWNER OR THE ENGINEER.

THE CONTRACTOR SHALL CONFORM TO ALL APPLICABLE OCCUPATIONAL SAFETY AND HEALTH STANDARDS, RULES, REGULATIONS AND ORDERS ESTABLISHED BY THE STATE OF CALIFORNIA AND LOCAL AGENCIES. THE CONTRACTOR SHALL PROVIDE ALL LIGHTS, BARRICADES, SIGNS, FLAGMEN OR OTHER DEVICES NECESSARY FOR PUBLIC CONVENIENCE AND PUBLIC SAFETY IN ACCORDANCE WITH THE PROVISIONS IN SECTIONS 7-1.03 AND 7-1.04 OF THE CALTRANS STANDARD SPECIFICATIONS. COSTS FOR COMPLYING WITH THESE PROVISIONS SHALL BE INCLUDED IN THE BID PRICE FOR THE VARIOUS ITEMS OF WORK INVOLVED.

THE CONTRACTOR SHALL PROVIDE ALL SHORING, BRACING, SLOPING OR OTHER PROVISIONS NECESSARY TO PROTECT WORKMEN FOR ALL AREAS TO BE EXCAVATED TO A DEPTH OF 5 FEET OR MORE. EXCAVATIONS OF 5 FEET OR MORE IN DEPTH WILL REQUIRE AN EXCAVATIONS PERMIT FROM THE STATE OF CALIFORNIA DEPARTMENT OF INDUSTRIAL SAFETY. FOR TRENCHES 5 FEET OR MORE IN DEPTH, THE CONTRACTOR SHALL COMPLY WITH SECTION 7-1.02k(6) OF THE CALTRANS STANDARD SPECIFICATIONS.

- PRIOR TO COMMENCEMENT OF ANY CONSTRUCTION ON THIS SITE, IT IS ADVISED THAT ALL INVOLVED PARTIES REVIEW SECTION 8771 AND SECTION 8725 OF THE BUSINESS AND PROFESSIONS CODE AND SECTION 605 OF THE CALIFORNIA STATE PENAL CODE TO ENSURE THAT MONUMENT CONSERVATION HAS BEEN PROPERLY ADDRESSED.
- 9. IF HUMAN REMAINS ARE FOUND DURING CONSTRUCTION ACTIVITIES, CONTRACTOR SHALL CEASE ALL ACTIVITIES AND CONTACT THE OFFICE OF THE NATIVE AMERICAN HERITAGE COMMISSION AT (916) 373-3710 FOR RECOMMENDED PROCEDURES.

CONSTRUCTION GENERAL

- THE INTENT OF THE PLANS AND SPECIFICATIONS IS TO PRESCRIBE THE DETAILS FOR THE CONSTRUCTION AND COMPLETION OF THE WORK WHICH THE CONTRACTOR HAS UNDERTAKEN TO PERFORM IN ACCORDANCE WITH PLANS. SPECIFICATIONS AND APPLICABLE STANDARDS. WHERE THE PLANS AND SPECIFICATIONS DESCRIBE PORTIONS OF THE WORK IN GENERAL TERMS, BUT NOT IN COMPLETE DETAIL, IT IS UNDERSTOOD THAT ONLY THE BEST GENERAL PRACTICE IS TO PREVAIL AND THAT ONLY MATERIALS AND WORKMANSHIP OF THE FIRST QUALITY ARE TO BE USED.
- THE CONTRACTOR SHALL NOTIFY THE ENGINEER IMMEDIATELY REGARDING ANY DISCREPANCIES OR AMBIGUITIES THAT MAY EXIST IN THE PLANS OR SPECIFICATIONS.

UNLESS OTHERWISE SPECIFIED. THE CONTRACTOR SHALL FURNISH ALL LABOR. MATERIAL. TOOLS, EQUIPMENT AND INCIDENTALS AND DO ALL WORK INVOLVED IN EXECUTING THE WORK IN A SATISFACTORY AND WORKMANLIKE MANNER.

2. THE BIDDER SHALL EXAMINE CAREFULLY THE SITE OF THE WORK CONTEMPLATED, THE PLANS, SPECIFICATIONS AND THE PROPOSAL OR BID FORMS THEREFOR. THE SUBMISSION OF A BID SHALL BE CONCLUSIVE EVIDENCE THAT THE BIDDER HAS INVESTIGATED AND IS SATISFIED AS TO THE CONDITIONS TO BE ENCOUNTERED, AS TO THE CHARACTER, QUALITY AND SCOPE OF WORK TO BE PERFORMED, THE QUANTITIES OF MATERIALS TO BE FURNISHED AND AS TO THE REQUIREMENTS OF THE PLANS AND SPECIFICATIONS.

IF. DURING THE COURSE OF THEIR EXAMINATION, A BIDDER FINDS FACTS OR CONDITIONS WHICH APPEAR TO THEM TO BE IN CONFLICT WITH THE INTENT OF THE PROJECT PLANS AND SPECIFICATIONS, THEY SHALL CONTACT THE ENGINEER FOR ADDITIONAL INFORMATION AND EXPLANATION BEFORE SUBMITTING THEIR BID.

THE CONTRACTOR SHALL MAINTAIN A SET OF FULL-SIZED AS-BUILT RECORD DRAWINGS SHOWING THE FINAL LOCATION AND LAYOUT OF ALL WATER, SEWER AND STORM DRAINAGE PIPING, ELECTRICAL AND MECHANICAL EQUIPMENT, CONDUITS, STRUCTURES AND OTHER FACILITIES. THE AS-BUILT PLANS OF THE ELECTRICAL SYSTEM SHALL INCLUDE THE STREET LIGHT LAYOUT PLAN SHOWING LOCATION OF LIGHTS. CONDUITS, CONDUCTORS. POINTS OF CONNECTIONS TO SERVICES, PULL BOXES AND WIRE SIZES. AS-BUILT RECORD DRAWINGS SHALL REFLECT CHANGE ORDERS, ACCOMMODATIONS AND ADJUSTMENTS TO ALL IMPROVEMENTS CONSTRUCTED. WHERE NECESSARY, SUPPLEMENTAL DRAWINGS SHALL BE PREPARED AND SUBMITTED BY THE CONTRACTOR.

THE CONTRACTOR SHALL NOTIFY THE ENGINEER IN WRITING AT LEAST 48 HOURS PRIOR TO BACKFILLING OF ANY PIPE WHICH STUBS TO A FUTURE PHASE OF CONSTRUCTION FOR INVERT

4. APPROPRIATE DUST CONTROL SHALL BE PROVIDED FOR ALLEVIATION OR PREVENTION OF DUST NUISANCE AT THE CONTRACTOR'S EXPENSE. CONTRACTOR SHALL MAINTAIN DUST CONTROL DURING CONSTRUCTION AND OTHER TIMES IN ACCORDANCE WITH THE REQUIREMENTS OF CITY OF TURLOCK.

THE CONTRACTOR SHALL USE ALL REASONABLE EFFORTS TO OBTAIN NON-POTABLE WATER FOR CONSTRUCTION OR DUST CONTROL PURPOSES.

IF CONSTRUCTION WATER WILL BE OBTAINED FROM THE CITY'S FIRE HYDRANT(S), A FIRE HYDRANT USE PERMIT APPLICATION MUST BE SUBMITTED AND APPROVED BY THE CITY OF TURLOCK, FEES, DEPOSITS, AND WATER RATES ARE LISTED ON THE APPLICATION.

- 5. IF EXISTING IMPROVEMENTS NEED TO BE DISTURBED, RELOCATED AND/OR REMOVED FOR THE PROPER PLACEMENT OF IMPROVEMENTS TO BE CONSTRUCTED BY THESE PLANS, THE CONTRACTOR SHALL BE RESPONSIBLE FOR PROTECTING EXISTING IMPROVEMENTS FROM
- 6. THE CONTRACTOR SHALL EXERCISE EXTREME CARE IN CONSTRUCTION AND REMOVAL OPERATIONS TO PROTECT EXISTING IMPROVEMENTS AND UTILITIES, ADJACENT PROPERTY, INCLUDING LAWN, SHRUBBERY, TREES, IRRIGATION FACILITIES, ETC., SO AS NOT TO REMOVE BREAK, OR DAMAGE ANY IMPROVEMENT OR FACILITY. ANY IMPROVEMENT OR FACILITY THAT IS REMOVED, BROKEN OR DAMAGED BY ACTION OF THE CONTRACTOR EITHER THROUGH HIS NEGLIGENCE OR OPERATIONS SHALL BE REPLACED BY THE CONTRACTOR AT HIS OWN FXPFNSF
- 7. THE CONTRACTOR SHALL BE HELD RESPONSIBLE FOR COSTS RESULTING FROM ANY FIELD CHANGES MADE WITHOUT PRIOR WRITTEN AUTHORIZATION FROM THE OWNER AND ENGINEER:
- 8. ALL PRE-EXISTING SEWER LATERALS AND STORM DRAIN LINES SHALL BE VIDEO INSPECTED TO ENSURE THAT THE LINES ARE CLEAR OF ANY DEBRIS AND THAT THEY ARE NOT DAMAGED.
- MONUMENT PRESERVATION & PROTECTION:

THE CONTRACTOR SHALL BE RESPONSIBLE FOR THE PRESERVATION OF ALL SURVEY MONUMENTATION AND REFERENCE POINTS WHICH MAY BE LOST OR DISTURBED AS A RESULT OF THE WORK DONE. PRIOR TO THE START OF CONSTRUCTION, THE CONTRACTOR SHALL VERIFY THE LOCATION OF MONUMENTATION WHICH MAY BE DISTURBED. HE SHALL BE RESPONSIBLE FOR THE PRESERVATION AND/OR REPLACEMENT OF ALL SUCH MONUMENTATION IN COMPLIANCE WITH 8771 OF THE BUSINESS AND PROFESSIONS CODE AND SECTION 732.5, 1492.5 AND 1080.5 OF THE CALIFORNIA STREETS AND HIGHWAY CODE. THE CITY SHALL EMPLOY A LICENSED SURVEYOR TO SET TIES TO ANY MONUMENTS THAT MAY BE DISTURBED OR LOST DURING THE COURSE OF WORK PERFORMED. SUCH TIES SHALL BE SET IN LOCATIONS THAT WILL NOT OTHERWISE BE DISTURBED. THE CONTRACTOR SHALL BEAR ALL COST OF THE SURVEY, RE-SURVEY, REFERENCE TIES, REPLACEMENT CORNERS, CORNER RECORDS, MAPPING. CHECKING AND RECORDING FEES WHICH MAY BE REQUIRED AS A RESULT OF LOSS OR DISTURBANCE OF MONUMENTATION WHICH MAY OCCUR DURING THE COURSE OF THE WORK

LETTERS ARE SENT TO LOCAL UTILITY COMPANIES TO REQUEST EXISTING UNDERGROUND FACILITY INFORMATION INCLUDING LOCATION AND SIZE.

NOTE BELOW INDICATES STATUS OF INFORMATION RECEIVED FROM THE RESPECTIVE AGENCIES.

UTILITY COMPANIES:
PACIFIC GAS & ELECTRIC COMPANY ATTN: DELINEATIONMAPREQUESTS@PGE.COM ATTN: RICH WALLACE 3185 M STREET MERCED, CA 95348 (RECEIVED RESPONSE)

AT&T ATTN: DAWN SIBLEY 1116 M STREET MODESTO, CA 95354 (RECEIVED RESPONSE)

CHARTER SPECTRUM ATTN: ORLANDO SOLIZ 773 N WALNUT TURLOCK, CA 95380 (DID NOT RECEIVE RESPONSE)

TURLOCK IRRIGATION DISTRICT ATTN: TODD TROGLIN P. O. BOX 949 PHYSICAL ADDRESS: 333 EAST CANAL DRIVE TURLOCK, CA 95381 (RECEIVED RESPONSE)

TURLOCK IRRIGATION DEPARTMENT ATTN: DAVID PORATH P. O. BOX 949 PHYSICAL ADDRESS: 333 EAST CANAL DRIVE TURLOCK, CA 95381 (RECEIVED RESPONSE)

DATE B





UNDERGROUND FACILITIES SHOWN WERE LOCATED BASED ON INFORMATION PROVIDED BY UTILITY COMPANIES AND BY MEASURING SURFACE FEATURES. NO ATTEMPT WAS MADE TO LOCATE OTHER UNDERGROUND FACILITIES THAT WERE NOT READILY APPARENT FROM A VISUAL INSPECTION OF SURFACE FEATURES.

CONTRACTOR SHALL VERIFY ACTUAL DEPTH AND LOCATION OF ALL EXISTING UTILITIES PRIOR TO CONSTRUCTION....CALL "UNDERGROUND SERVICE ALERT" U.S.A.) (TOLL FREE 811 PRIOR TO TRENCHING, GRADING, EXCAVATION, DRILLING, PIPE PUSHING, PLANTING TREES, DIGGING POST HOLES FOR FENCES, ETC.(U.S.A.) WILL SUPPLY INFORMATION OR LOCATE AND MARK ANY UNDERGROUND FACILITIES.

PIPE SCHEDULE DESCRIPTION TYPE OF PIPE WATER (6" THROUGH 60") POLYVINYL CHLORIDE PIPE (PVC), C900-16, PC235, DR18 WATER (6" THROUGH 12") SPECIAL CLASS POLYVINYL CHLORIDE PIPE (PVC), C900-16, PC315, DR14 WATER WITHIN 10' OF SD OR SS WRAP PIPE WITH POLYETHYLENE FILM PER AWWA C105 THE CONTRACTOR SHALL POSSESS THE CLASS (OR CLASSES) OF LICENSE AS REQUIRED BY THE CITY OF TURLOCK FOR WORK PERFORMED IN THE PUBLIC RIGHT OF WAY

ERRORS OR OMISSIONS CONTAINED THERE IN. IF DURING THE COURSE OF CONSTRUCTION THE PUBLIC INTEREST REQUIRES A MODIFICATION OR A DEPARTURE FROM THE CITY SPECIFICATIONS, OR THE APPROVED PLANS. THE CITY SHALL HAVE THE UTHORITY TO REQUIRE SUCH MODIFICATION OR DEPARTURE AND TO SPECIFY THE MANNER IN WHICH THE SAME IS MADE.

APPROVAL OF THESE PLANS DOES NOT RELEASE THE CONTRACTOR FROM RESPONSIBILITY FOR CORRECTION OF MISTAKES,

- THIS SET OF IMPROVEMENT PLANS IS VALID FOR CONSTRUCTION PURPOSES ONLY AFTER THEY HAVE BEEN SIGNED BY THE CITY ENGINEER.
- ALL CONTRACTORS INVOLVED IN THE CONSTRUCTION OF THIS PROJECT SHALL ATTEND A PRE-CONSTRUCTION CONFERENCE ARRANGED BY THE CITY AT THE ENGINEERING SERVICES DEPARTMENT FOR CONSTRUCTION AND INSPECTION COORDINATION.
- THE CITY OF TURLOCK STANDARD SPECIFICATIONS AND DRAWINGS ARE MADE A PART OF THESE PLANS. CURRENT STANDARDS AND SPECIFICATIONS SHALL BE KEPT ON SITE DURING CONSTRUCTION.
- AN ENCHROACHMENT PERMIT IS REQUIRED AND MUST BE OBTAINED BEFORE WORK CAN BE STARTED IN THE PUBLIC RIGHT-OF-WAY.

UNAUTHORIZED CHANGES AND USES

DESCRIPTION

THE ENGINEER PREPARING THESE PLANS WILL NOT BE RESPONSIBLE FOR OR LIABLE FOR UNAUTHORIZED CHANGES TO OR USES OF THESE PLANS. ALL CHANGES TO THE PLANS MUST BE IN WRITING AND MUST BE APPROVED BY


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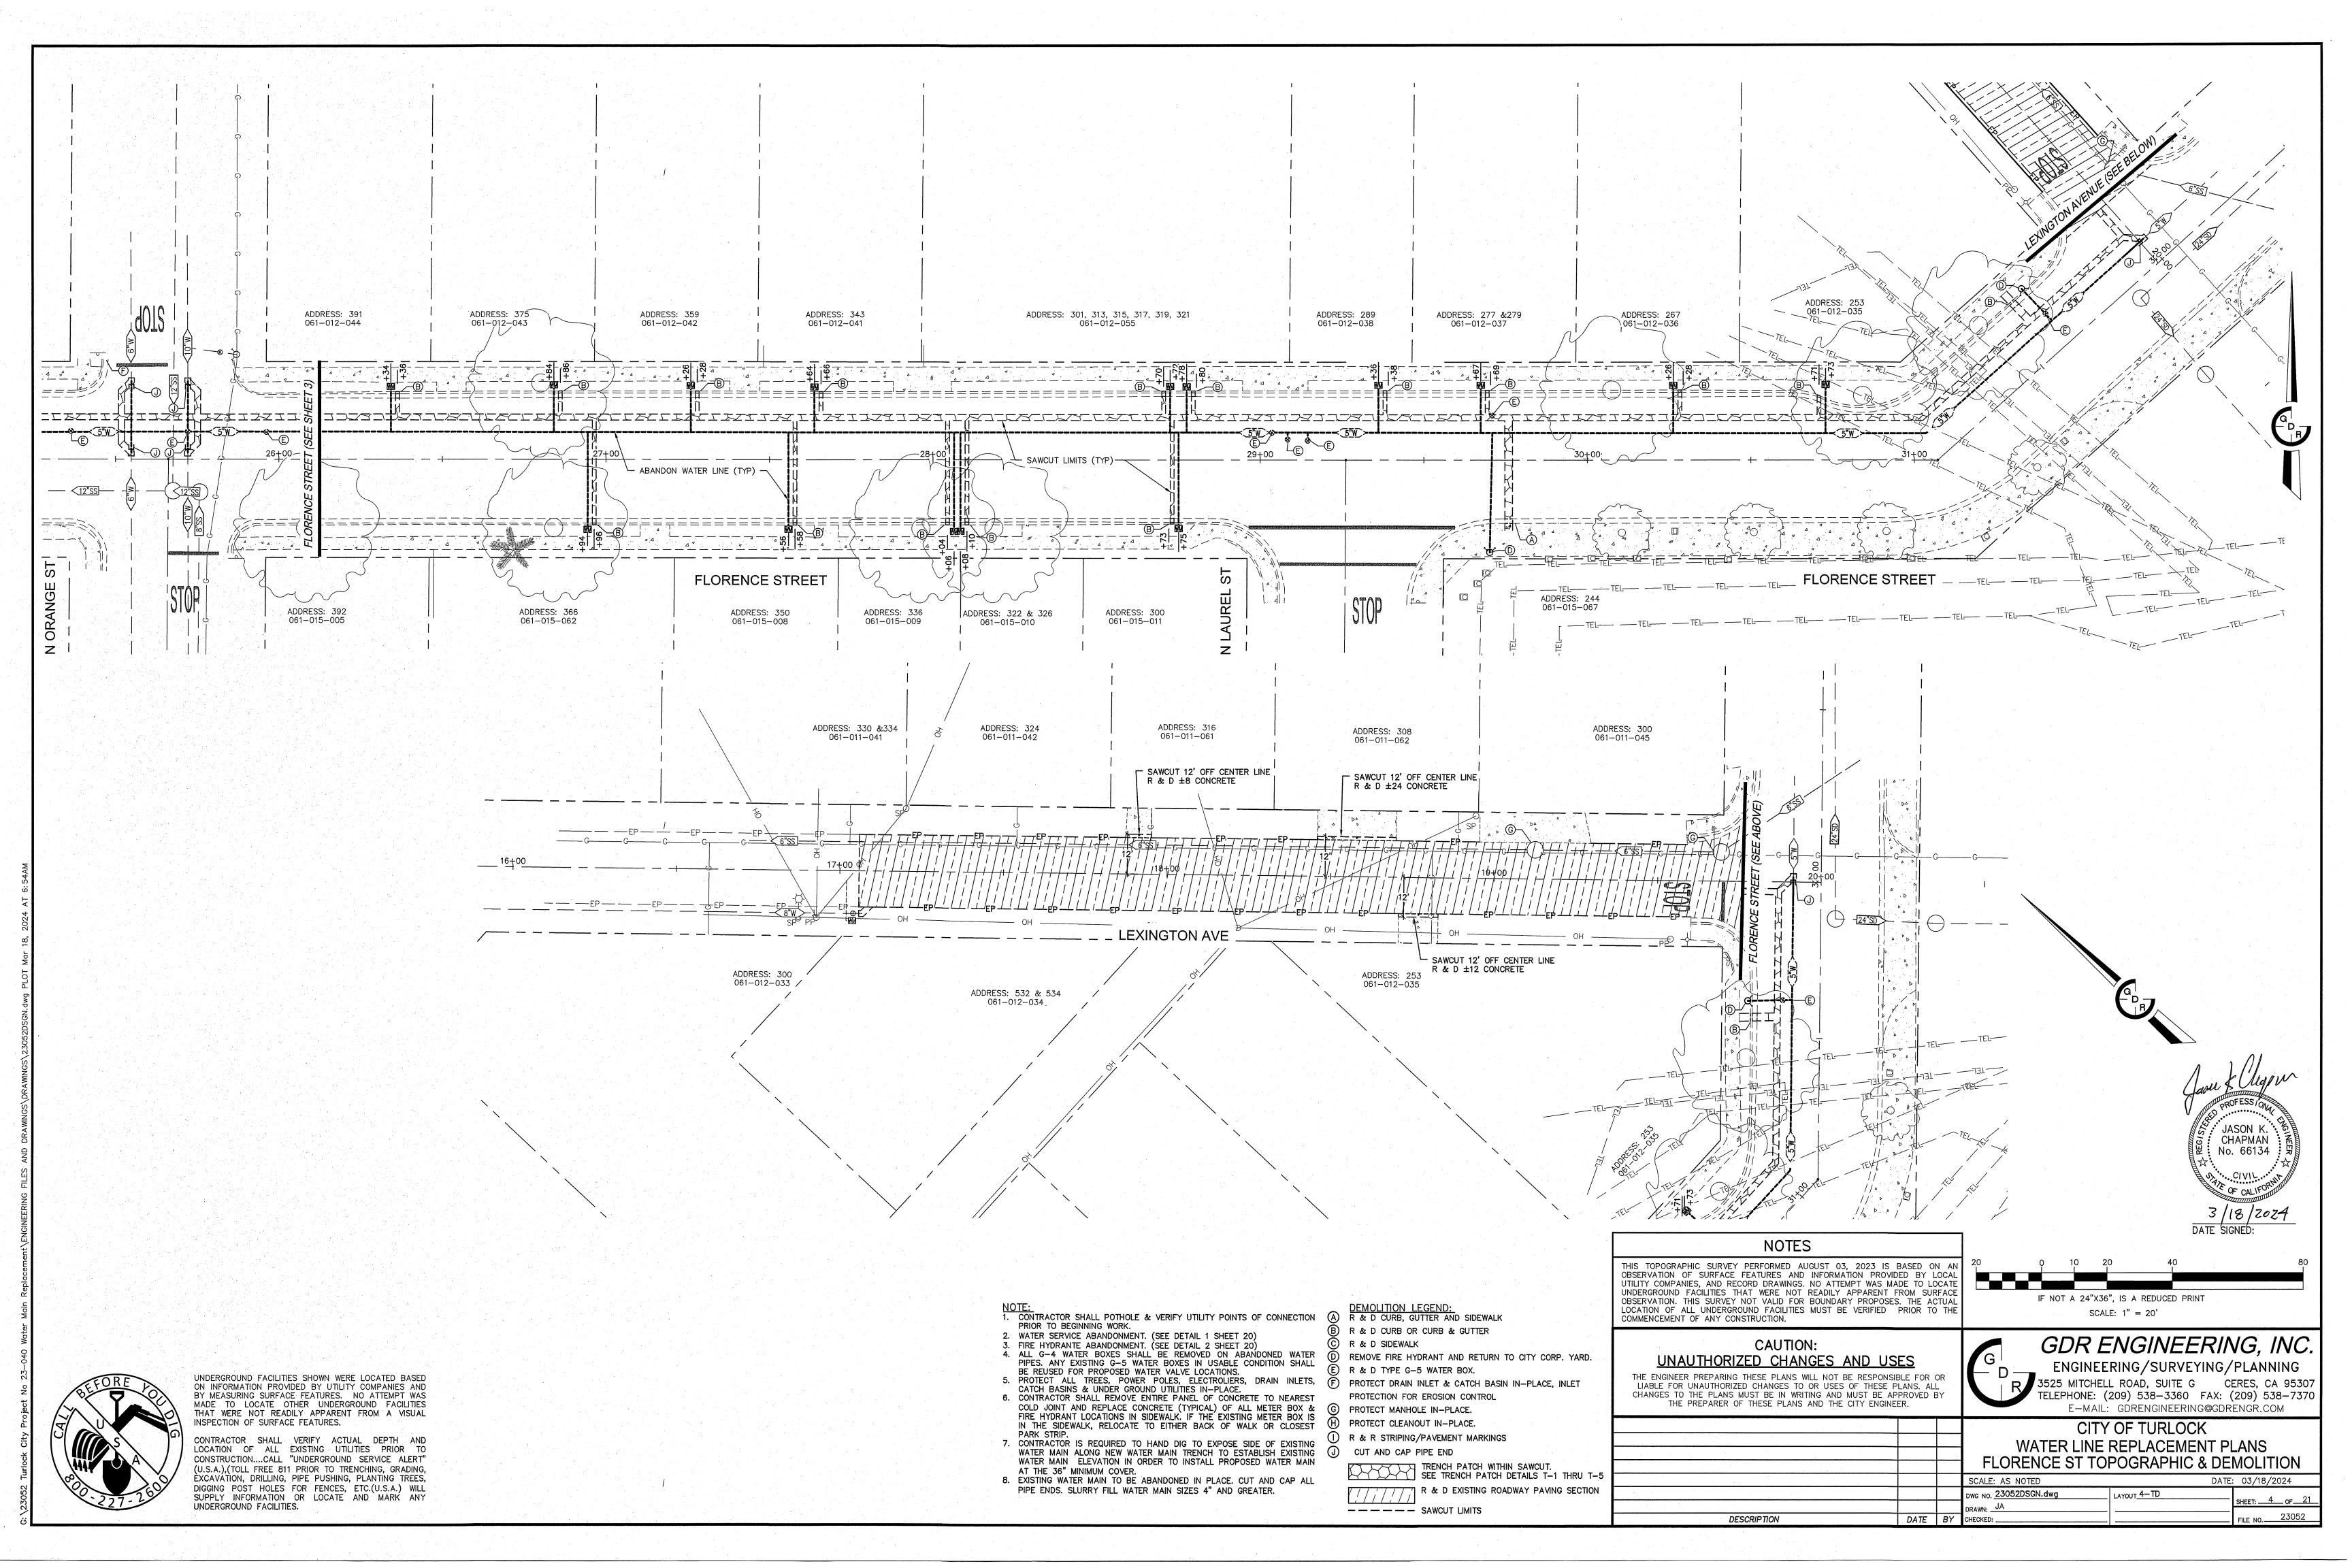
GDR ENGINEERING, INC. ENGINEERING/SURVEYING/PLANNING 3525 MITCHELL ROAD, SUITE G CERES, CA 95307 TELEPHONE: (209) 538-3360 FAX: (209) 538-7370 E-MAIL: GDRENGINEERING@GDRENGR.COM


THE PREPARER OF THESE PLANS AND THE CITY ENGINEER. CITY OF TURLOCK WATER LINE REPLACEMENT PLANS GENERAL NOTES


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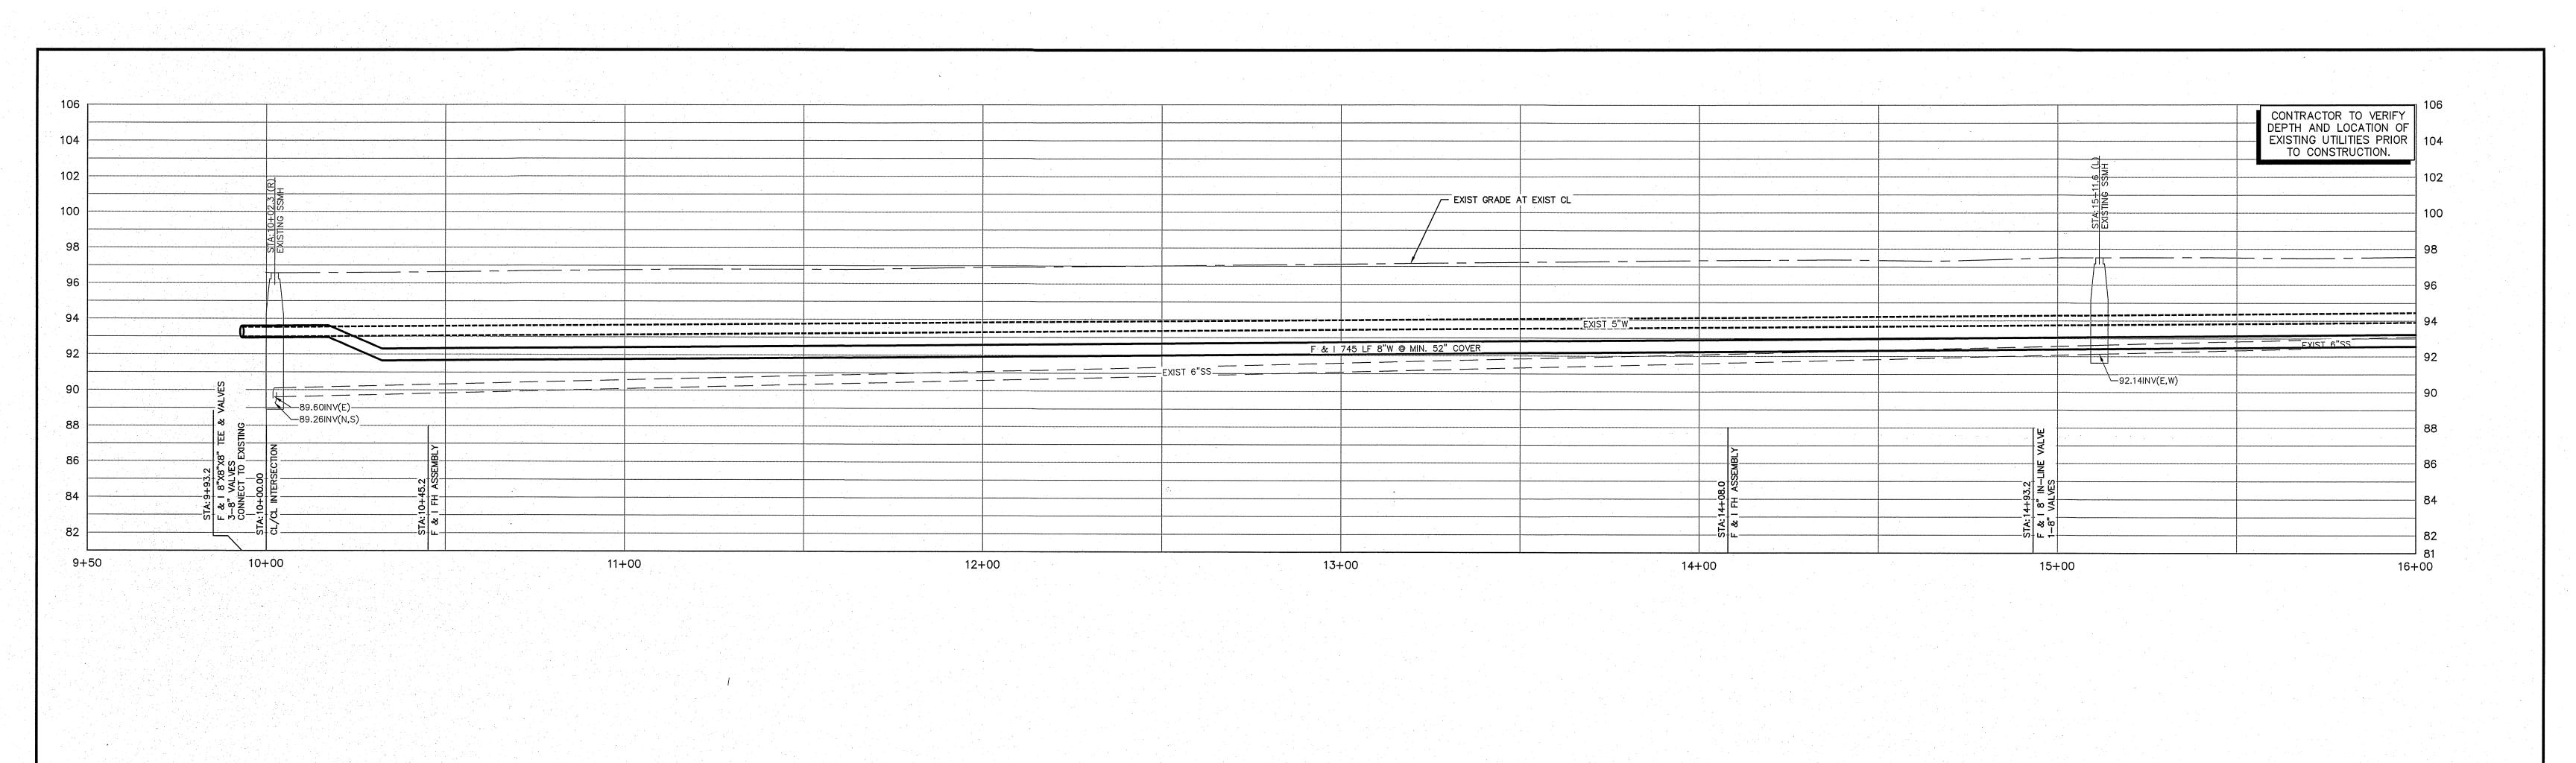
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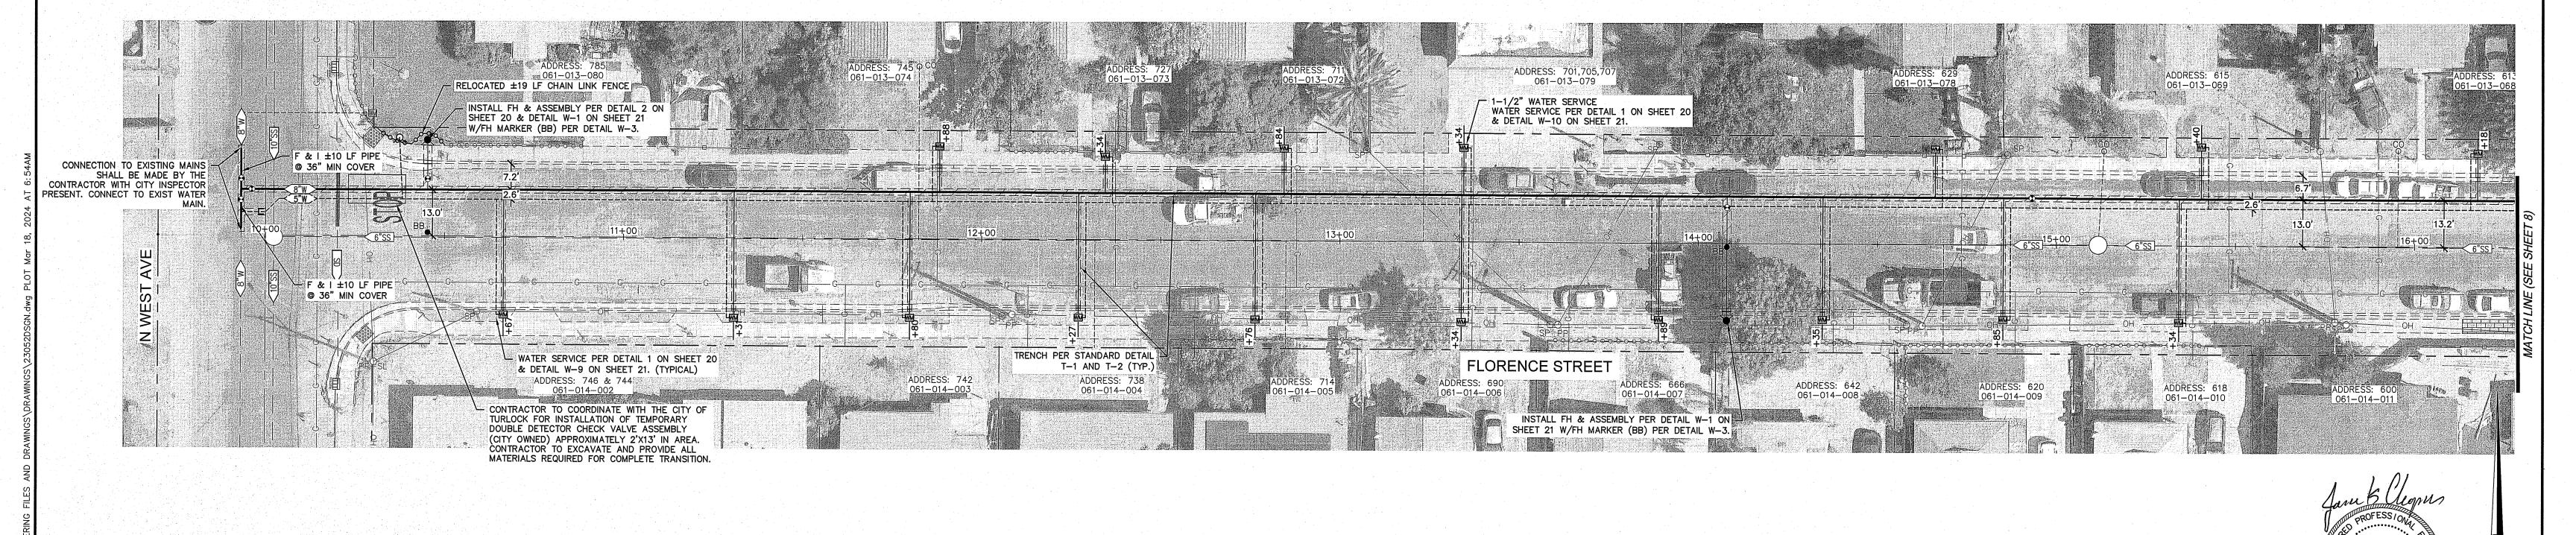






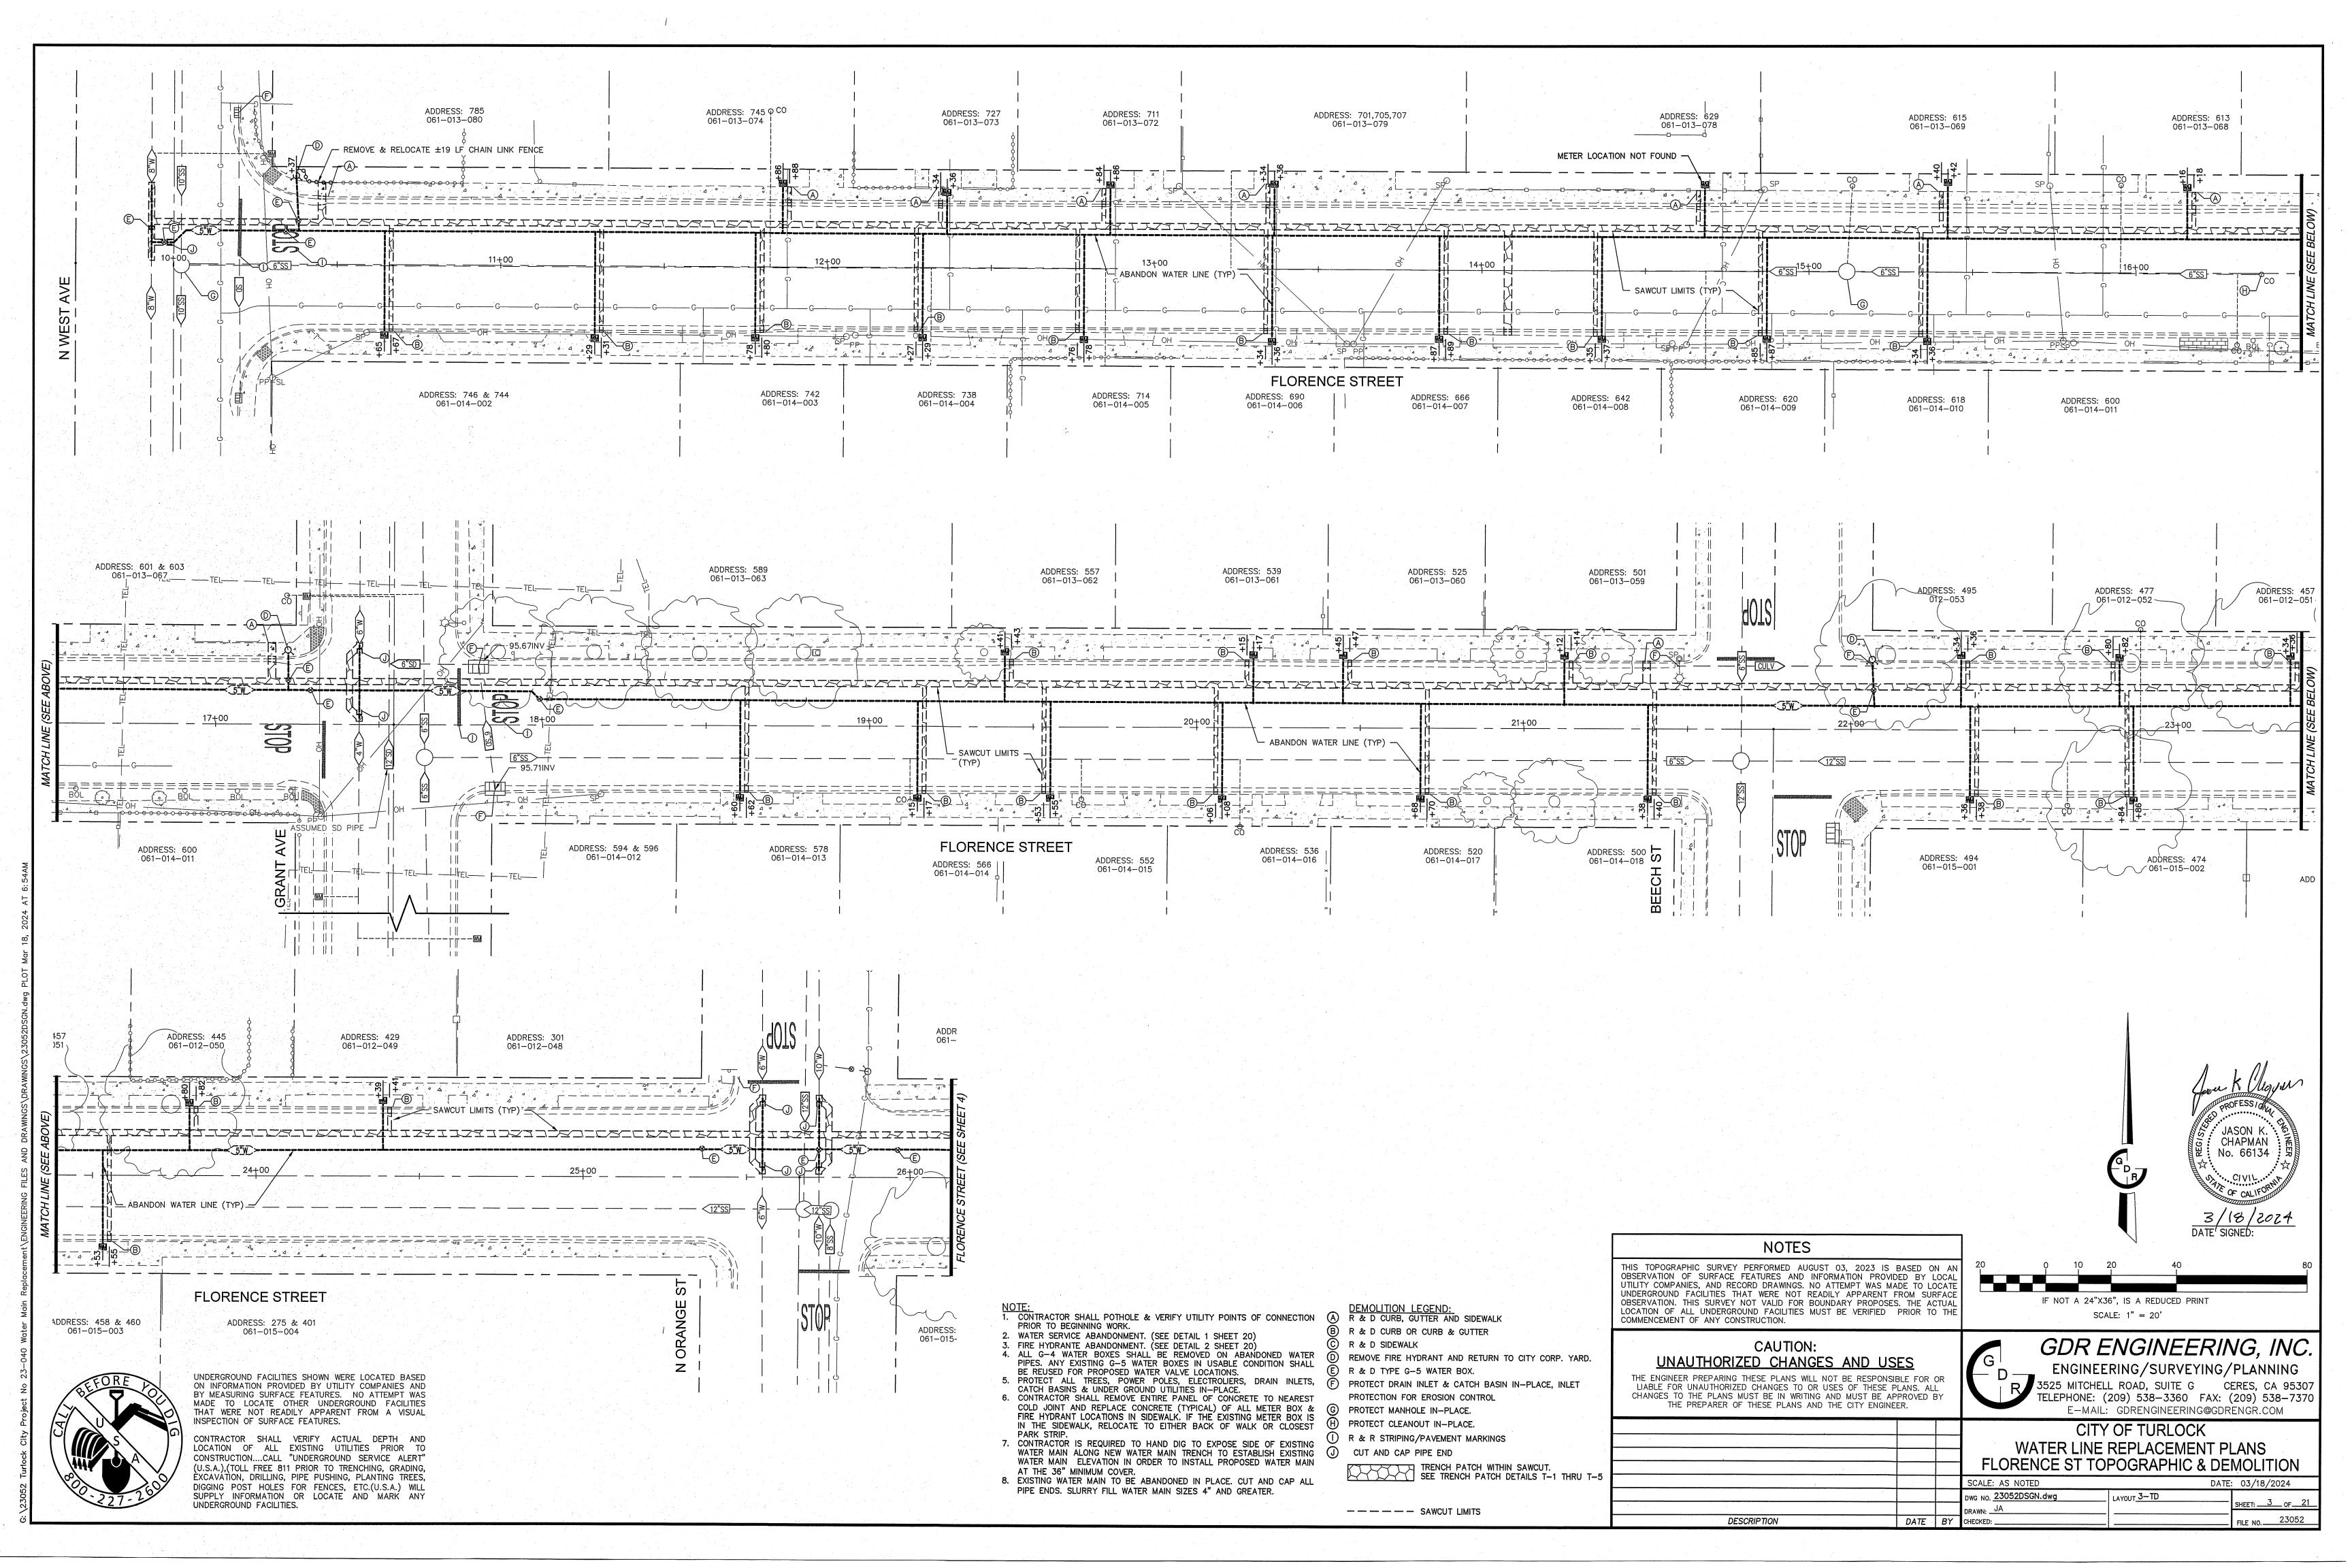

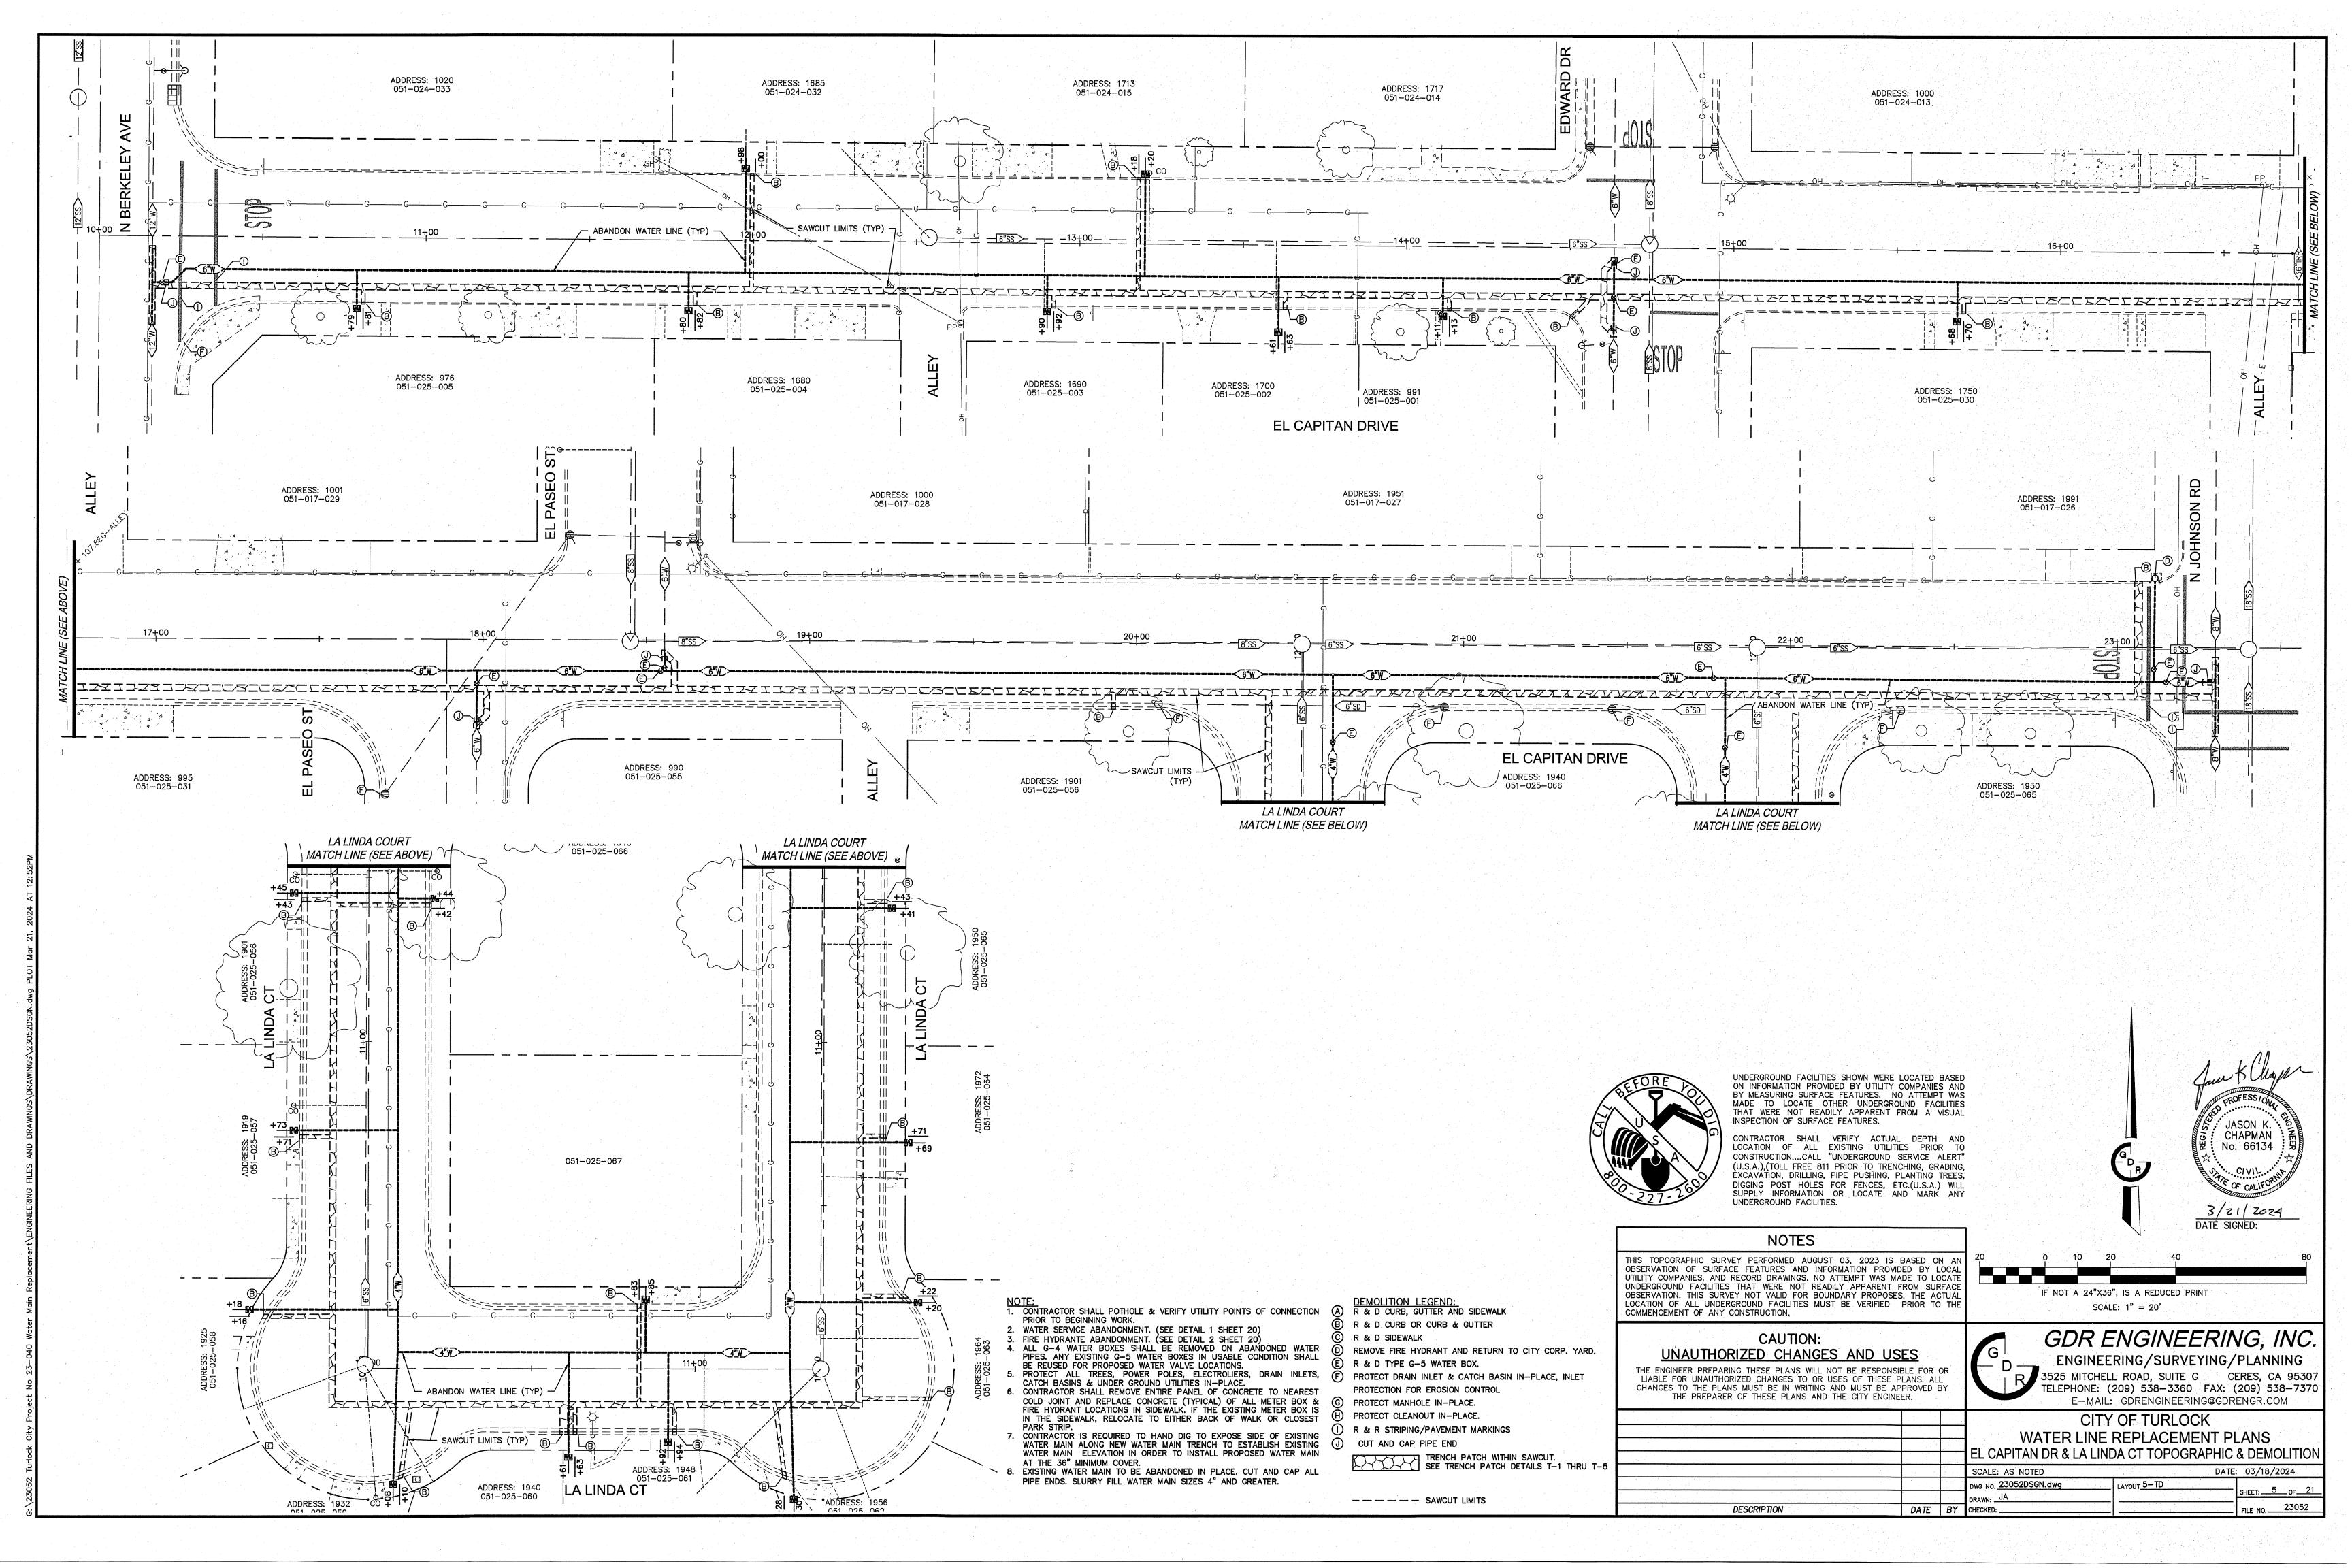

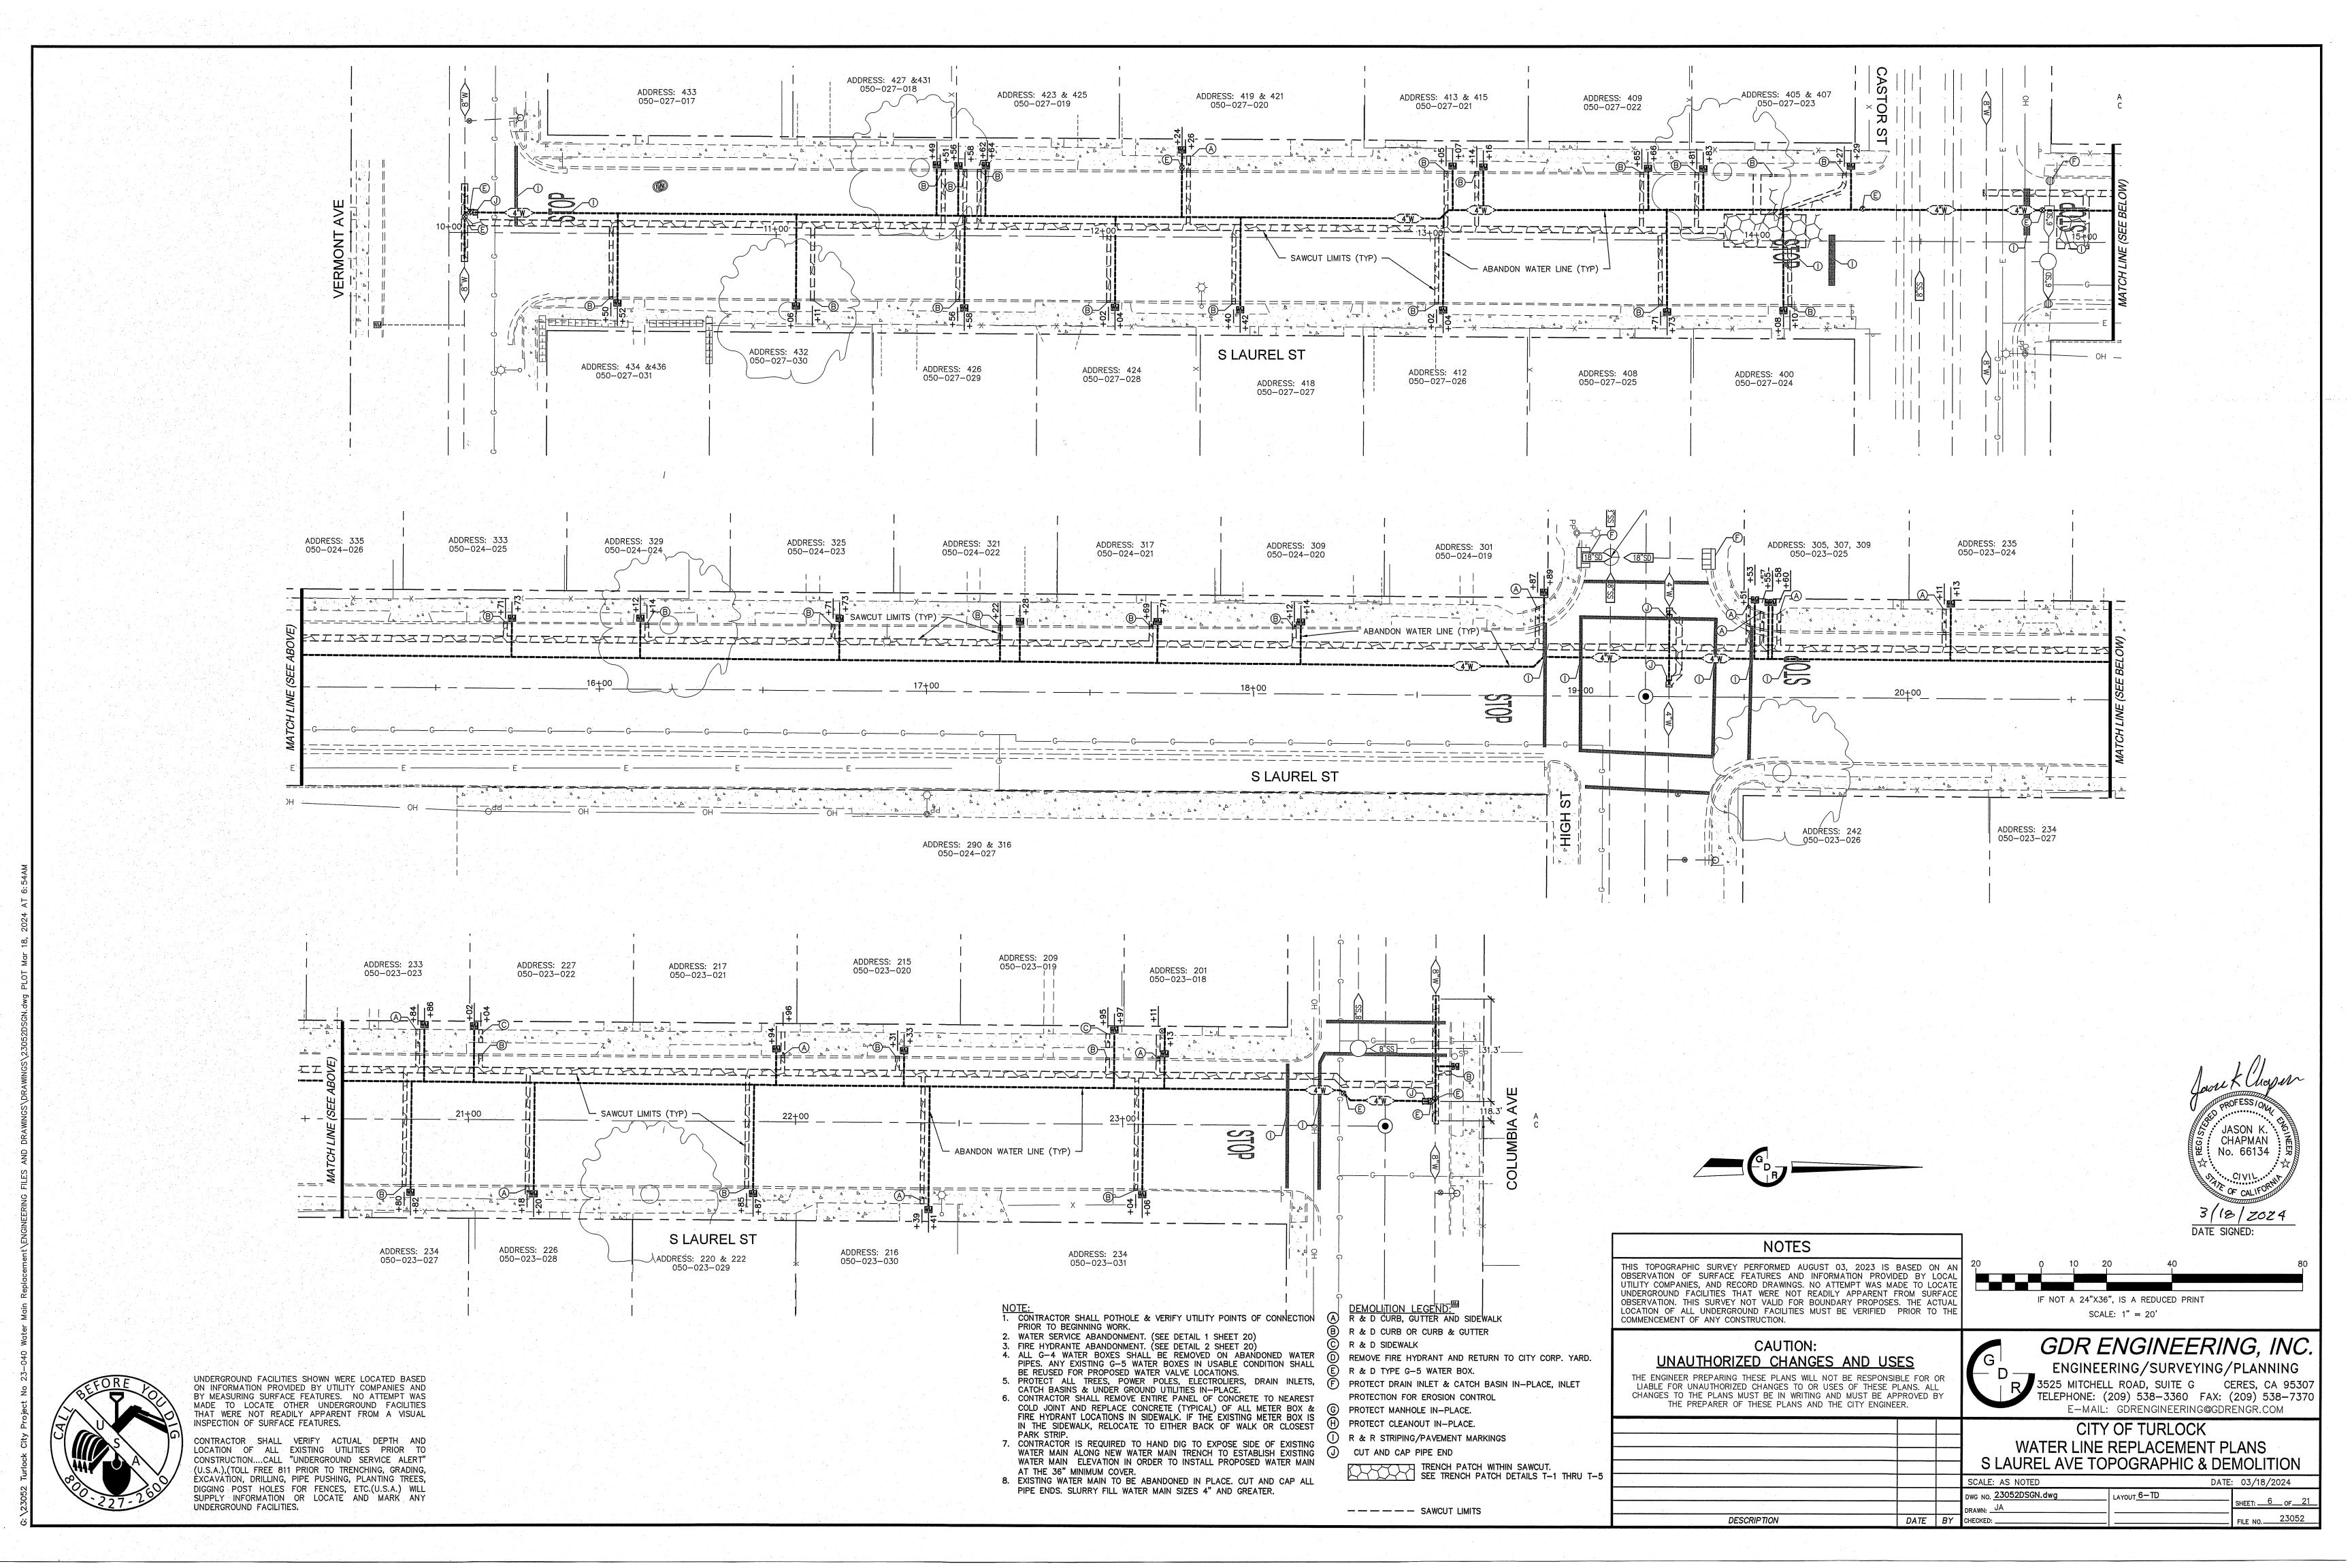



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NOTE:

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PAVING LEGEND:

TRENCH PATCH & GRINDING
SEE TRENCH PATCH DETAIL T-1 AND T-2

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	IF NOT A 24"X36", IS A REDUCED PRINT SCALE: 1" = 20' HOR, 1"=4' VERT	
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GDR ENGINEERING, INC.

ENGINEERING/SURVEYING/PLANNING

3525 MITCHELL ROAD, SUITE G CERES, CA 95307
TELEPHONE: (209) 538-3360 FAX: (209) 538-7370
E-MAIL: GDRENGINEERING@GDRENGR.COM


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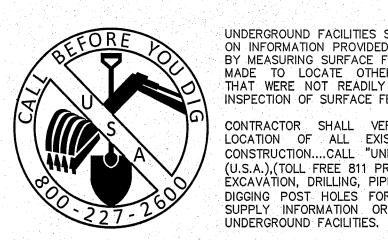
JASON K. CHAPMAN No. 66134

3/18/2024

CITY OF TURLOCK
WATER LINE REPLACEMENT PLANS
FLORENCE STREET PLAN AND PROFILE

DESCRIPTION



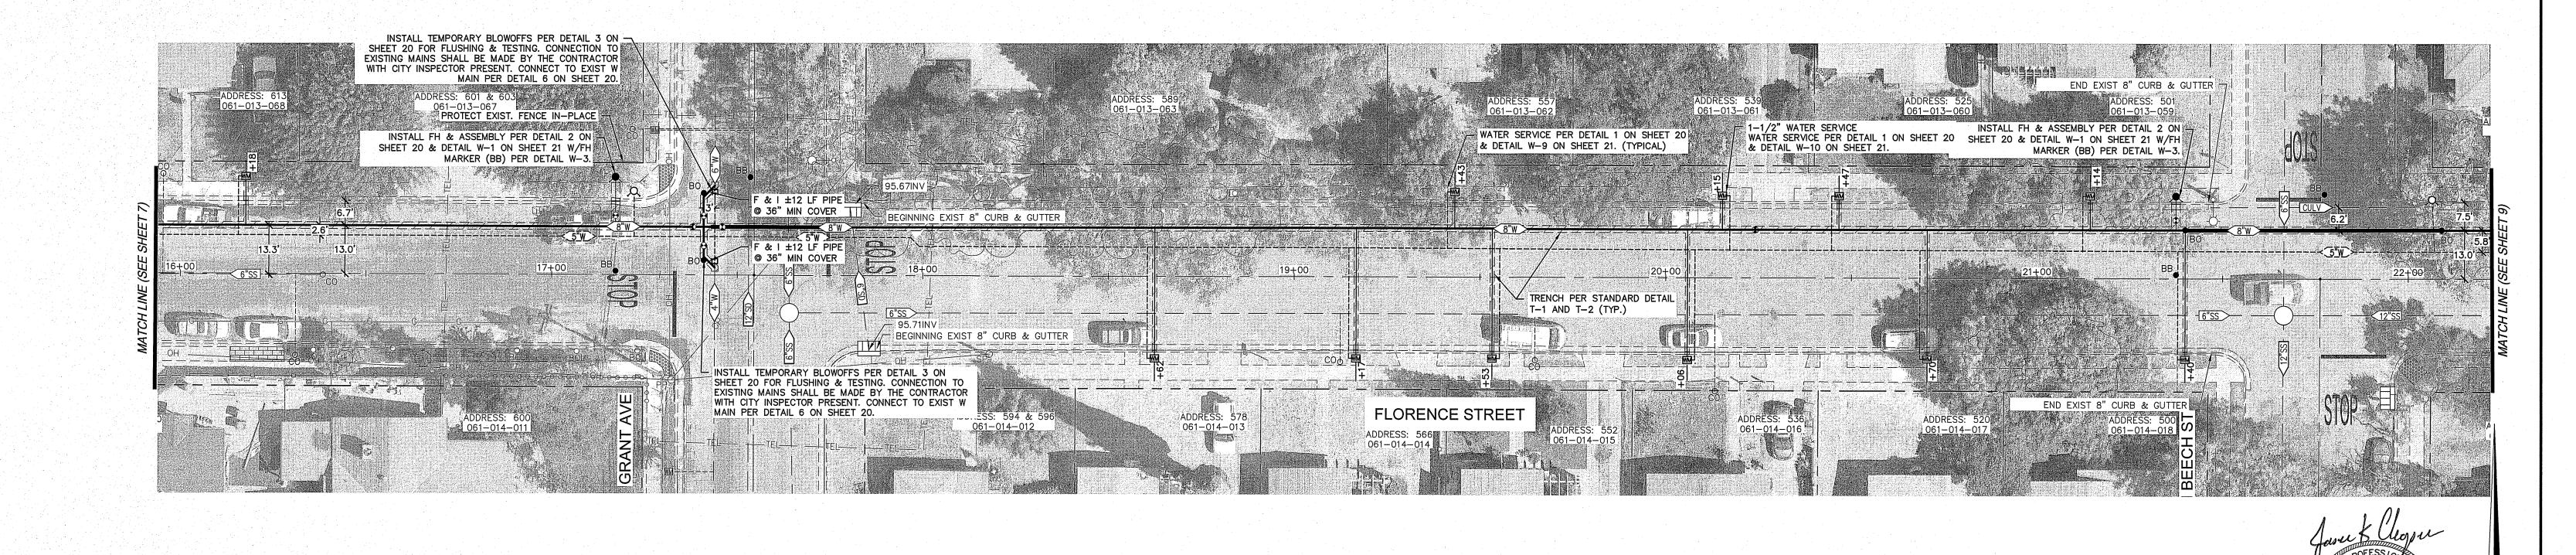

CONTRACTOR SHALL VERIFY ACTUAL DEPTH AND LOCATION OF ALL EXISTING UTILITIES PRIOR TO CONSTRUCTION....CALL "UNDERGROUND SERVICE ALERT" (U.S.A.), (TOLL FREE 811 PRIOR TO TRENCHING, GRADING, EXCAVATION, DRILLING, PIPE PUSHING, PLANTING TREES, DIGGING POST HOLES FOR FENCES, ETC.(U.S.A.) WILL SUPPLY INFORMATION OR LOCATE AND MARK ANY

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SCALE: 1" = 20' HOR, 1"=4' VERT

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GDR ENGINEERING, INC. ENGINEERING/SURVEYING/PLANNING 3525 MITCHELL ROAD, SUITE G CERES, CA 95307 TELEPHONE: (209) 538-3360 FAX: (209) 538-7370 CHANGES TO THE PLANS MUST BE IN WRITING AND MUST BE APPROVED BY
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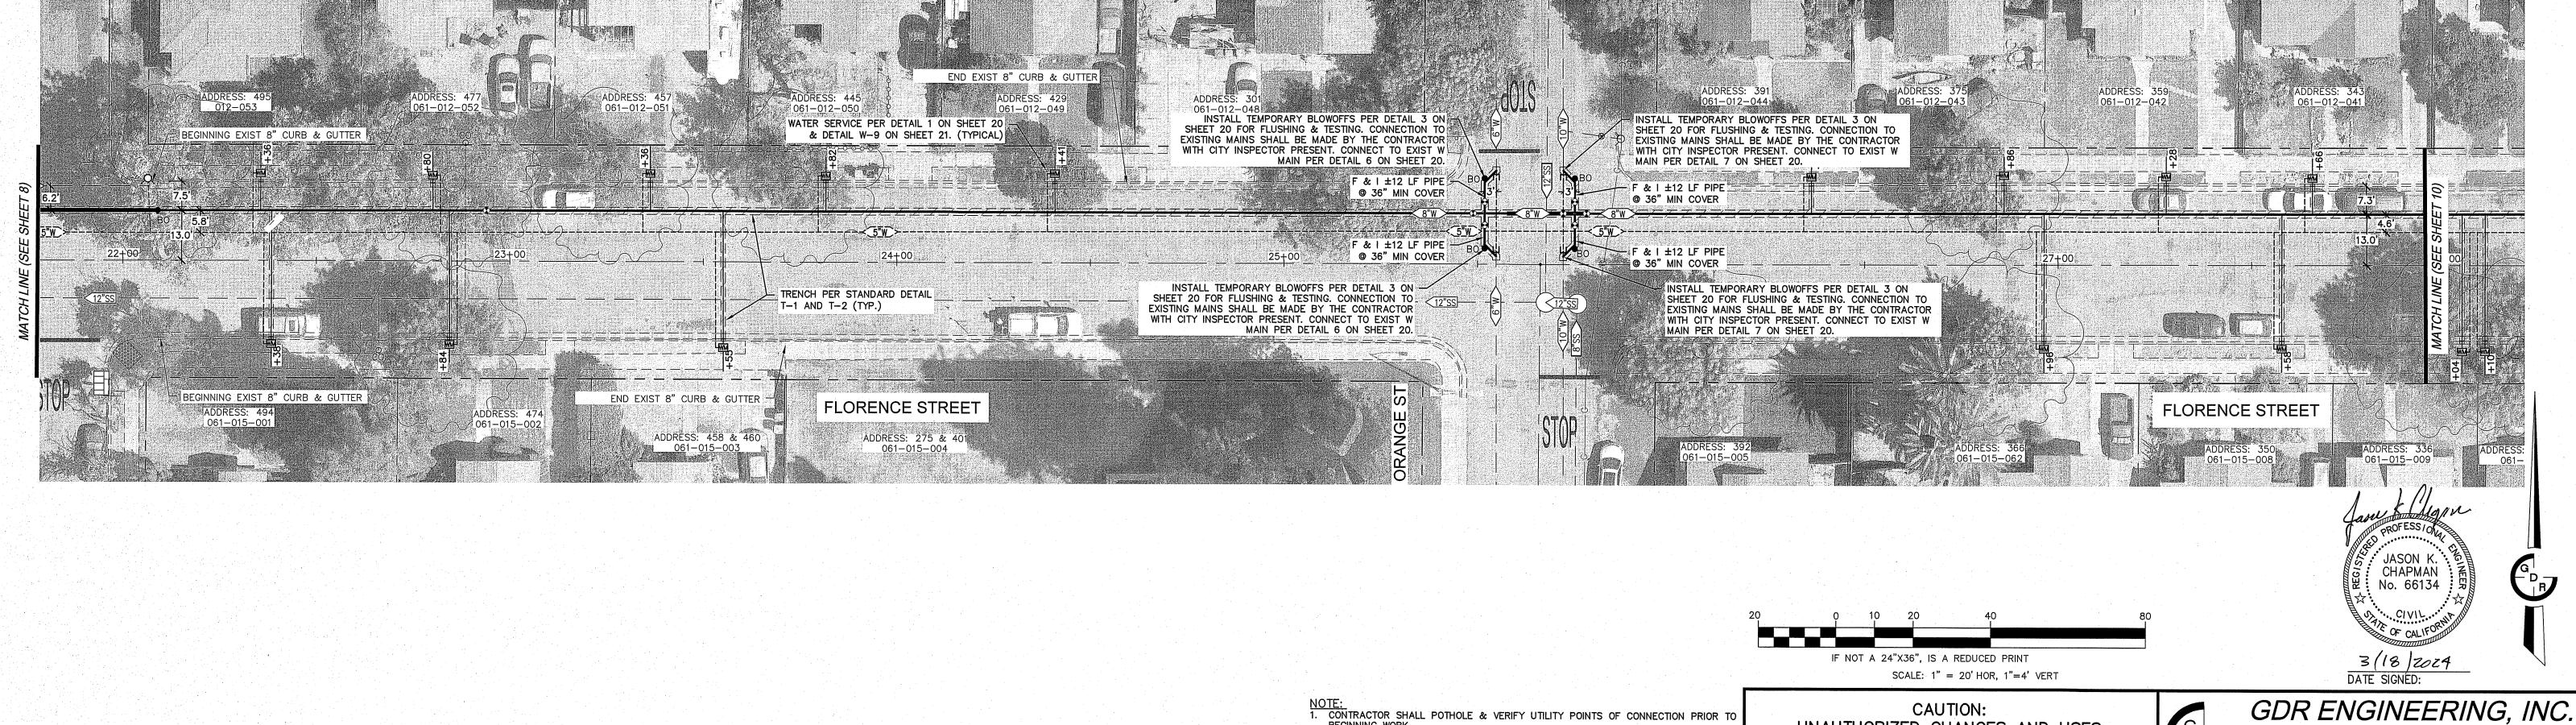
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CITY OF TURLOCK	RLOCK	CITY OF TURL			,		
WATER LINE REPLACEMENT PLANS	EMENT PLANS	WATER LINE REPLACE					
FLORENCE STREET PLAN AND PROFILE							


JASON K CHAPMAN No. 66134

3/18/2024

DATE' SIGNED:

		WATER LINE REPLACEMENT PLANS FLORENCE STREET PLAN AND PROFILE			
			SCALE: AS NOTED	DATE	: 03/18/2024
			DWG NO. 23052DSGN.dwg	LAYOUT 8-PP	SHEET: 8 OF 21
DESCRIPTION	DATE		DRAWN: _JA CHECKED:		FILE NO. 23052



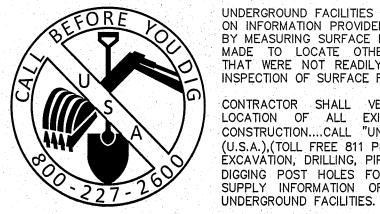

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	CITY (
	WATER LINE R

DESCRIPTION

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3525 MITCHELL ROAD, SUITE G CERES, CA 95307
TELEPHONE: (209) 538-3360 FAX: (209) 538-7370
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CITY OF TURLOCK
WATER LINE REPLACEMENT PLANS
FLORENCE STREET PLAN AND PROFILE


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DWG NO. 23052DSGN.dwg

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2306





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FULL PAVEMENT SECTION PER CITY STANDARD ST-1 3" ASPHALTIC CONCRETE OVER 6" AGGREGATE BASE @ 95% RELATIVE COMPACTION OVER 6" RECOMPACTED NATIVE SOIL

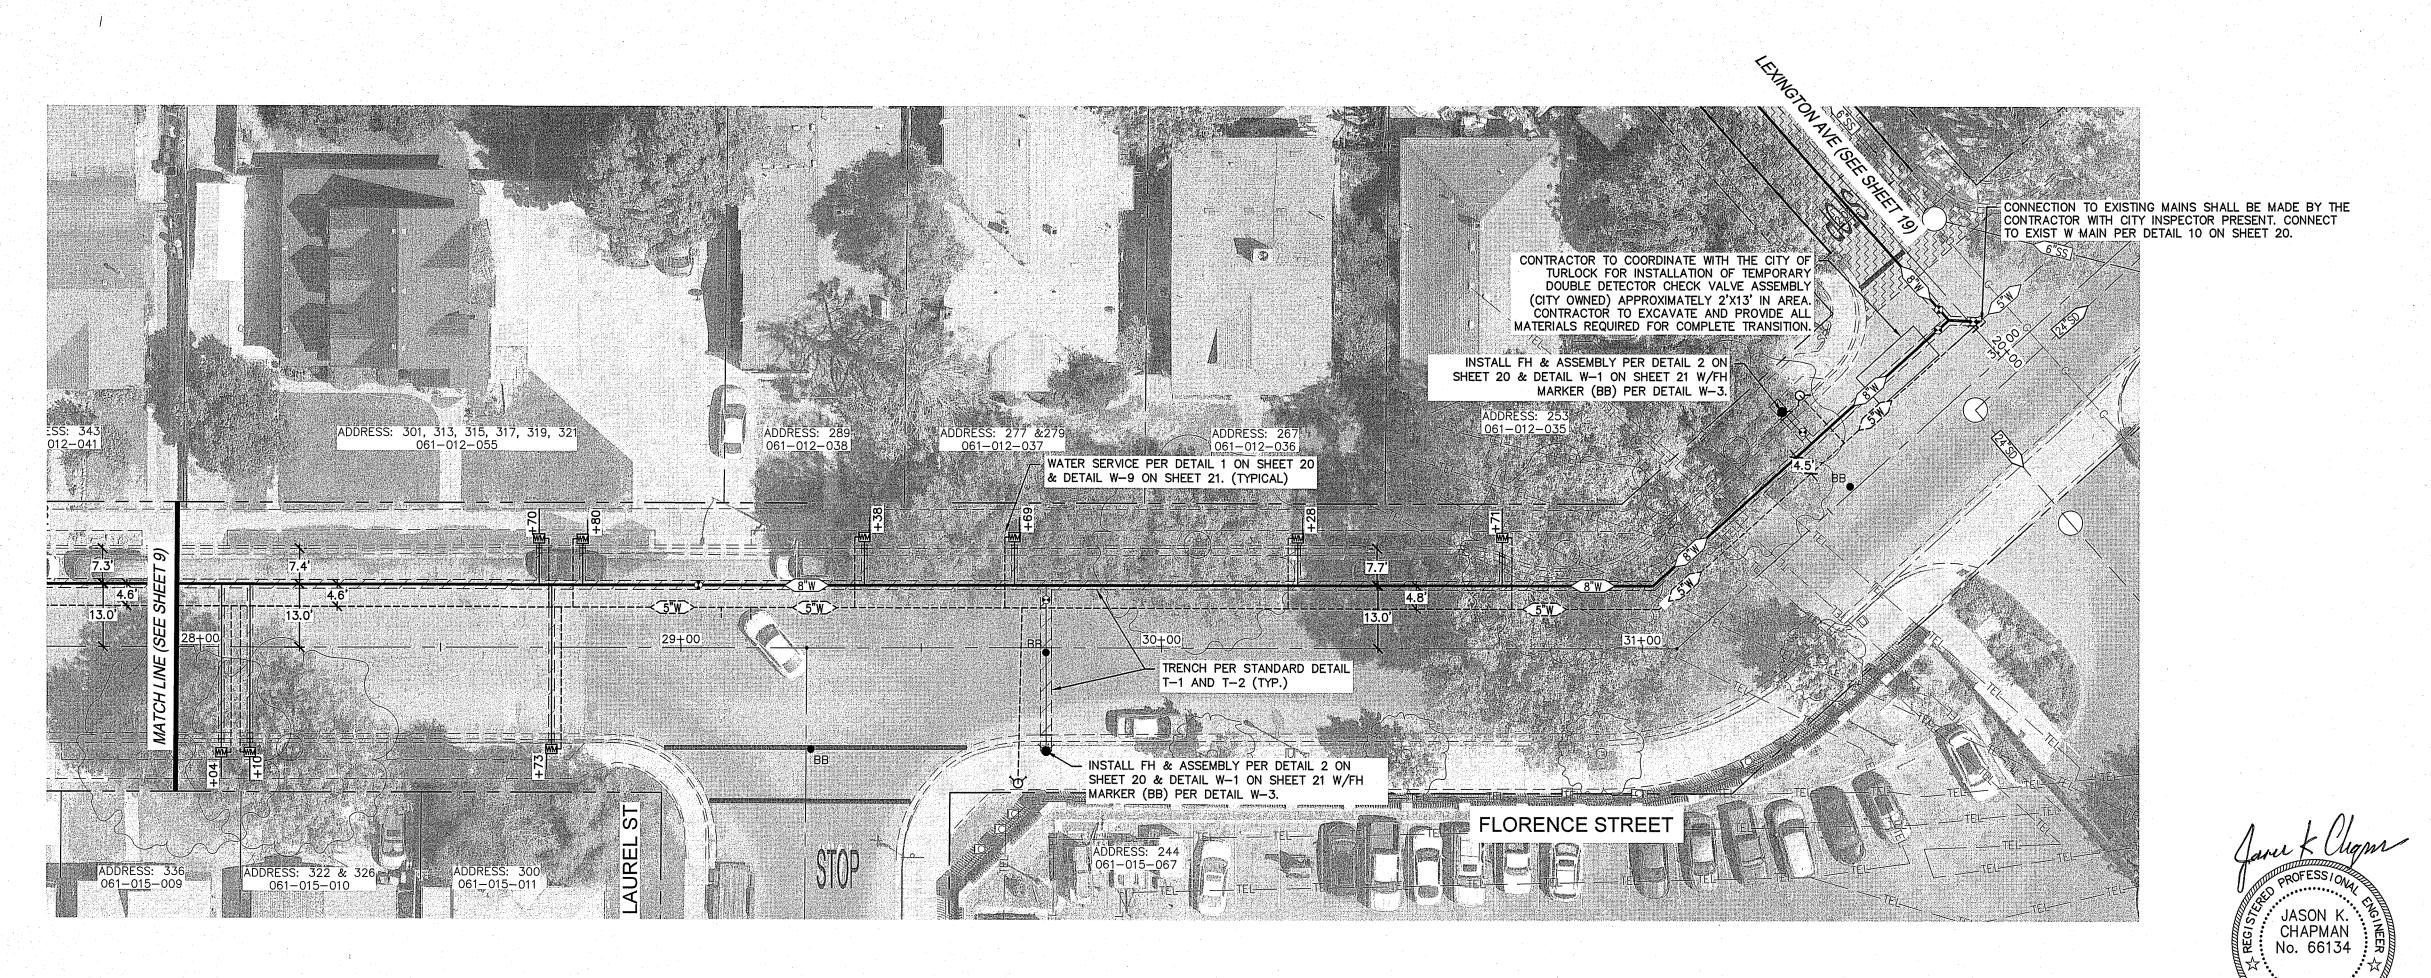IF NOT A 24"X36", IS A REDUCED PRINT

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GDR ENGINEERING, INC.


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CITY OF TURLOCK WATER LINE REPLACEMENT PLANS FLORENCE STREET PLAN AND PROFILE

SCALE: AS NOTED DATE: 03/18/2024 owg NO. 23052DSGN.dwg LAYOUT 10-PP RAWN: JA

DESCRIPTION DATE BY CHECKED: ___



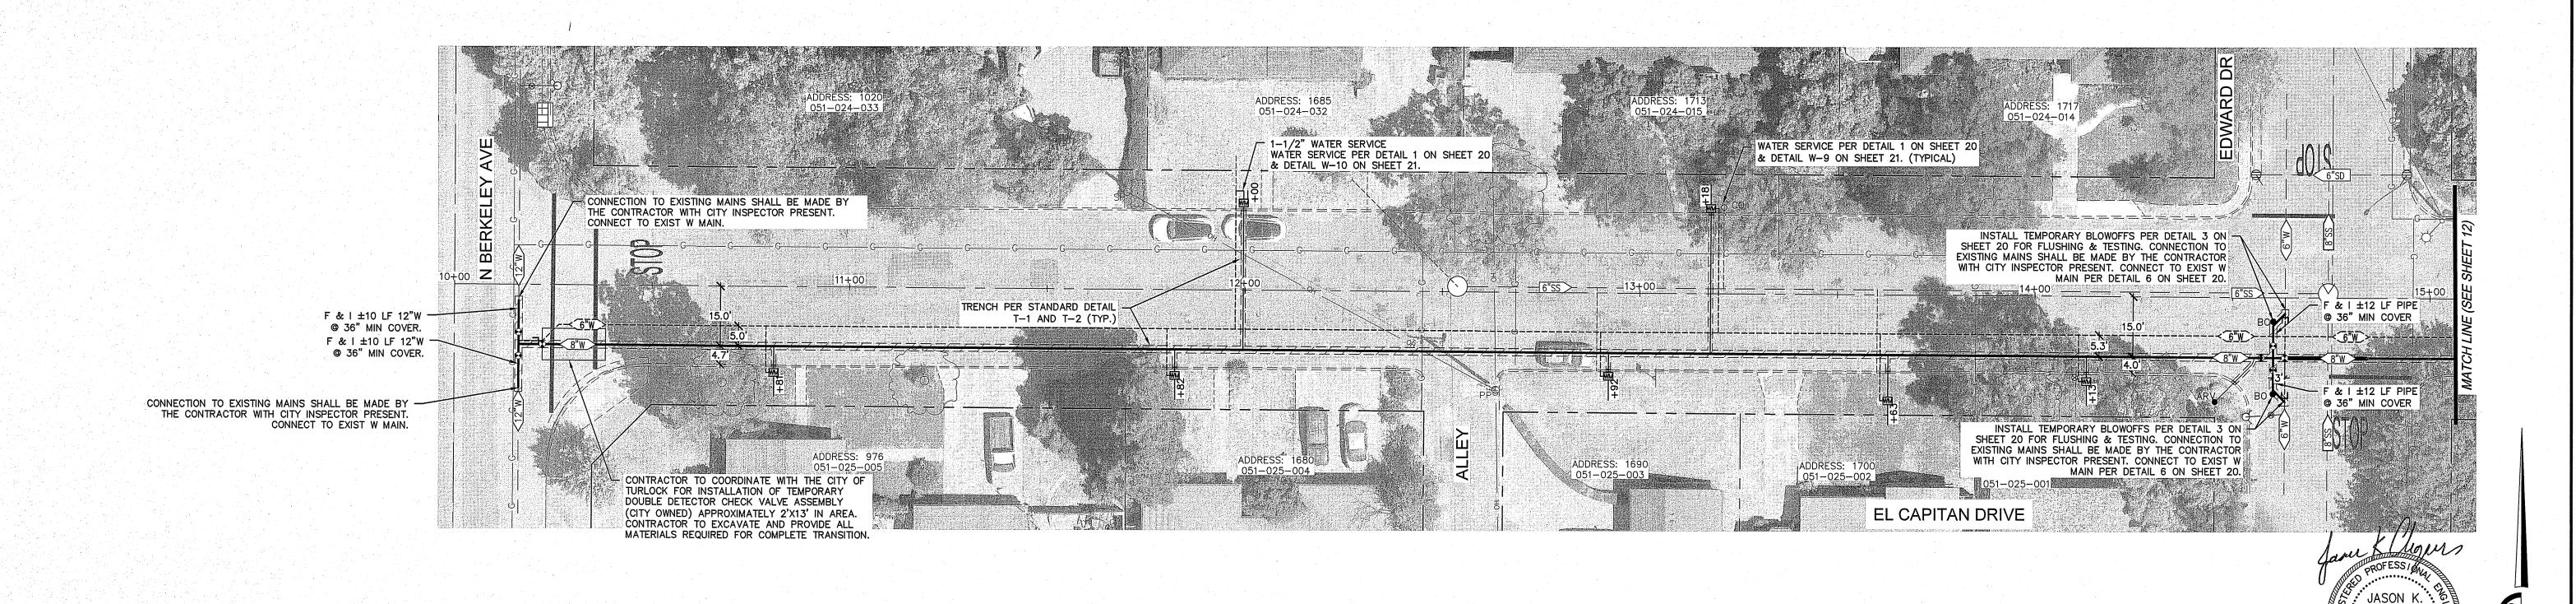

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	CITY OF TURLOCK WATER LINE REPLACEMENT PLANS
	EL CAPITAN DRIVE PLAN AND PROFILE SCALE: AS NOTED DATE: 03/18/2024
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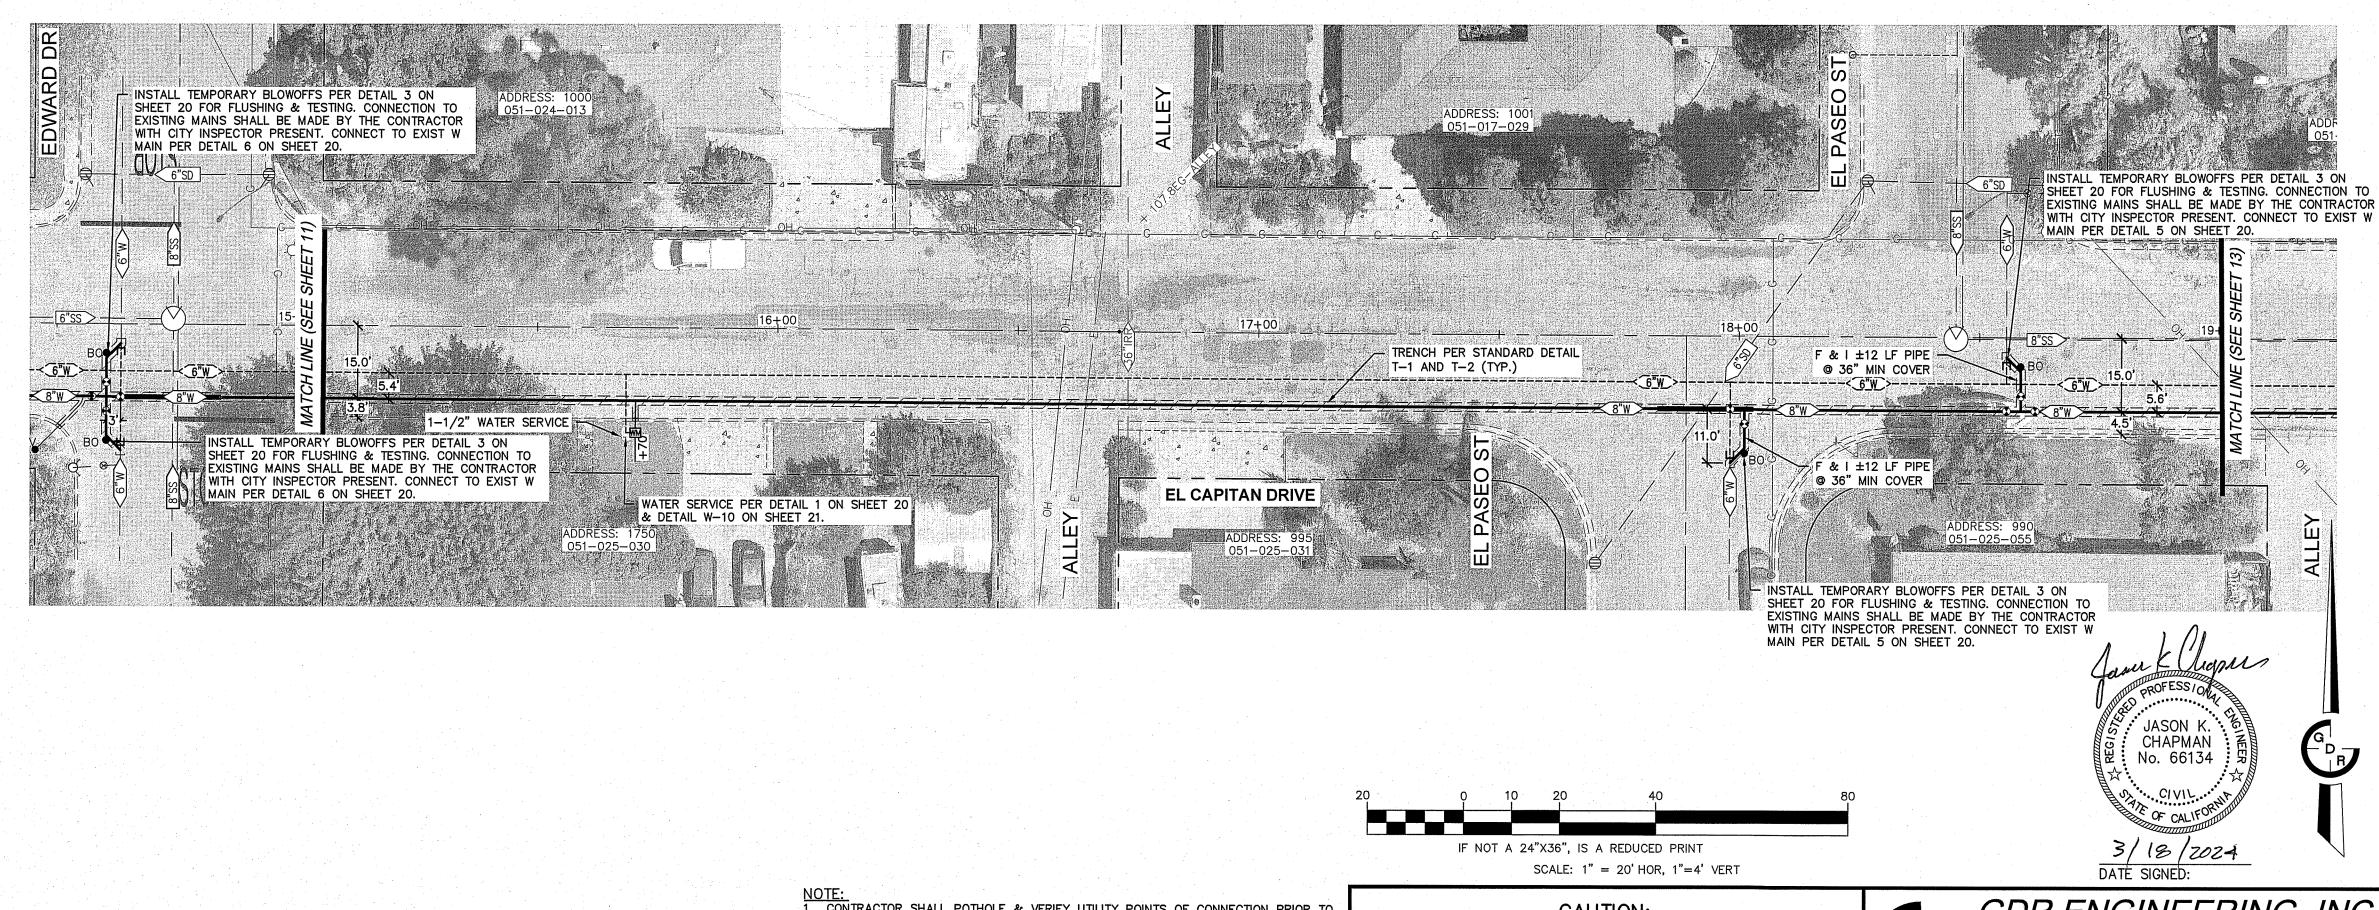
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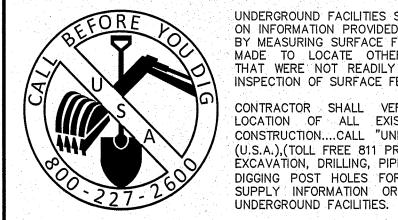
DATE BY

DESCRIPTION

CHAPMAN No. 66134

CONTRACTOR TO VERIFY DEPTH AND LOCATION OF EXISTING UTILITIES PRIOR 114 TO CONSTRUCTION. - EXIST GRADE AT EXIST CL 105.25INV(SW) EXIST 6"SD EXIST 6"W EXIST 6"W EXIST 6"W EXIST 6"W MIN 52" COVER 104 _______Exist_6"w F&I 53LF 8"W @ MIN. 52" CVR __F & I 299 LF 8"W @ MIN. 52" COVER_ STA: 17+83.0_ STA: 18+03.0 BEGIN SPECIAL PIPE END SPECIAL PIPE F & I 20 LF 8"W CENTERED UNDER EXISTING SD WITH 12" CLEARANCE— F & I 2—45 VERTICAL ELBOWS 15+00 16+00 17+00 18+00 19+00





UNDERGROUND FACILITIES SHOWN WERE LOCATED BASED ON INFORMATION PROVIDED BY UTILITY COMPANIES AND BY MEASURING SURFACE FEATURES. NO ATTEMPT WAS MADE TO LOCATE OTHER UNDERGROUND FACILITIES THAT WERE NOT READILY APPARENT FROM A VISUAL INSPECTION OF SURFACE FEATURES.

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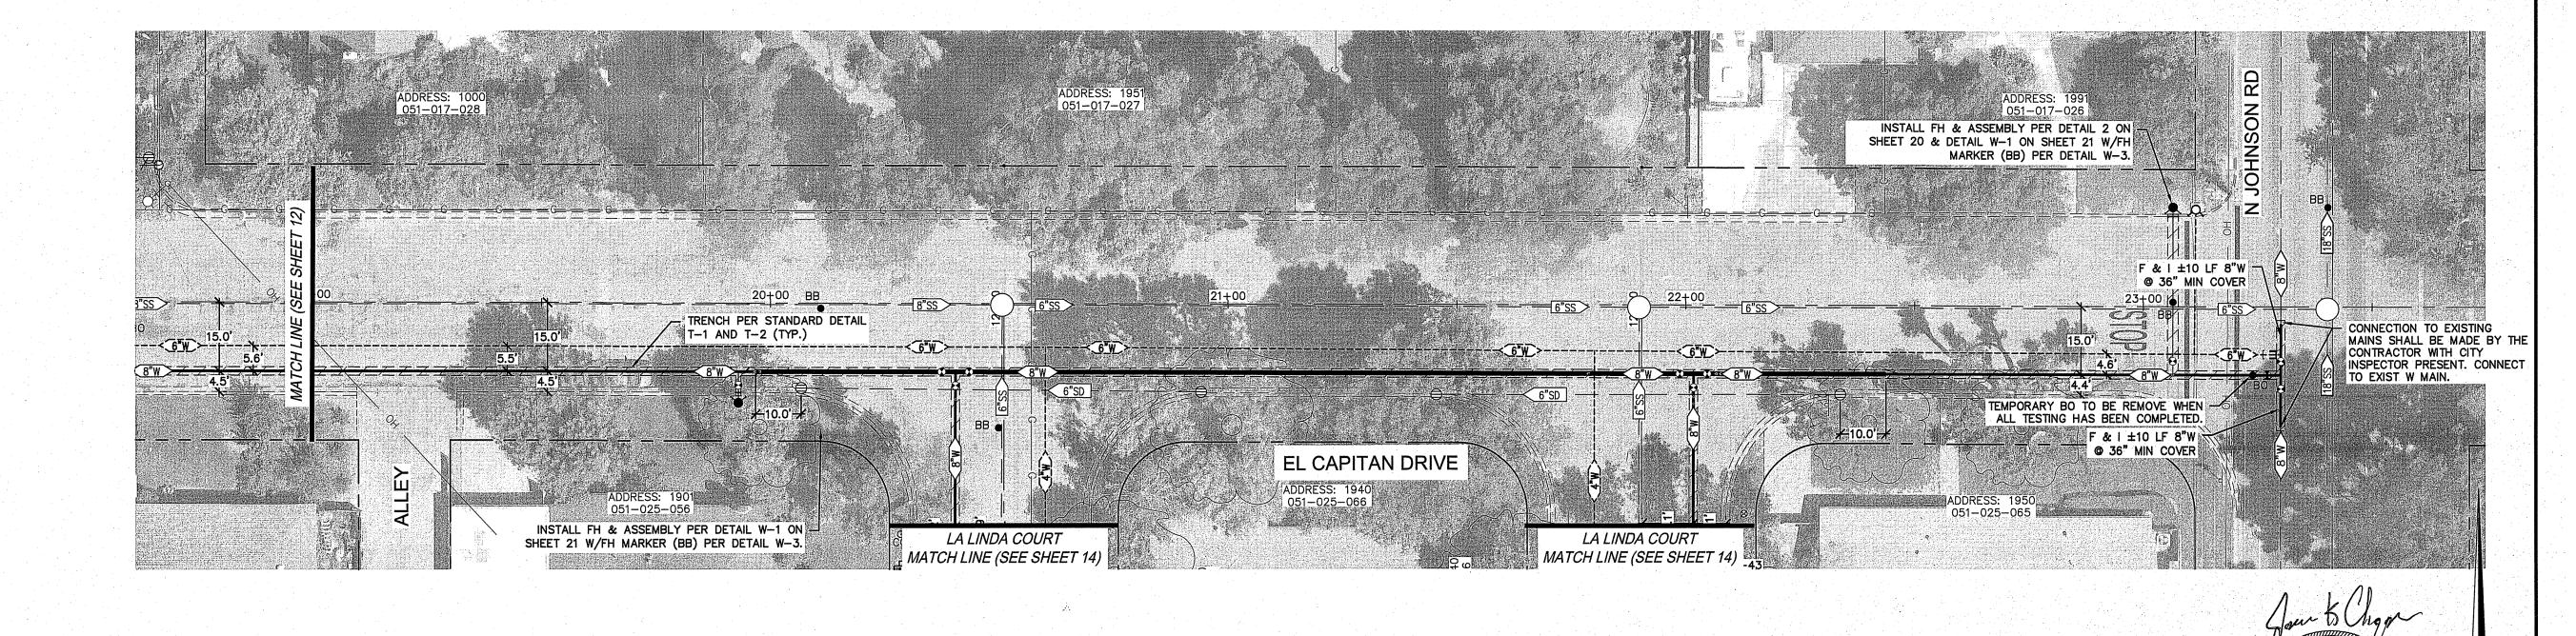
TRENCH PATCH & GRINDING
SEE TRENCH PATCH DETAIL T-1 AND T-2


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	CITY OF TURLOCK
	WATER LINE REPLACEMENT PLANS
	EL CAPITAN DRIVE PLAN AND PROFILE
	SCALE: AS NOTED DATE: 03/18/2024
	DWG NO. 23052DSGN.dwg LAYOUT 12-PP

DATE BY

DESCRIPTION

FILE NO. 23052



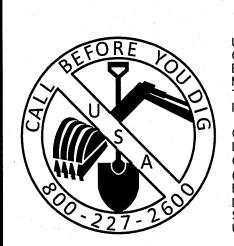

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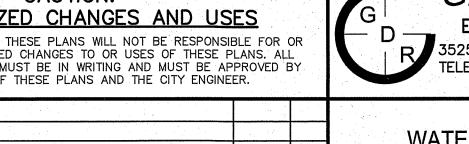
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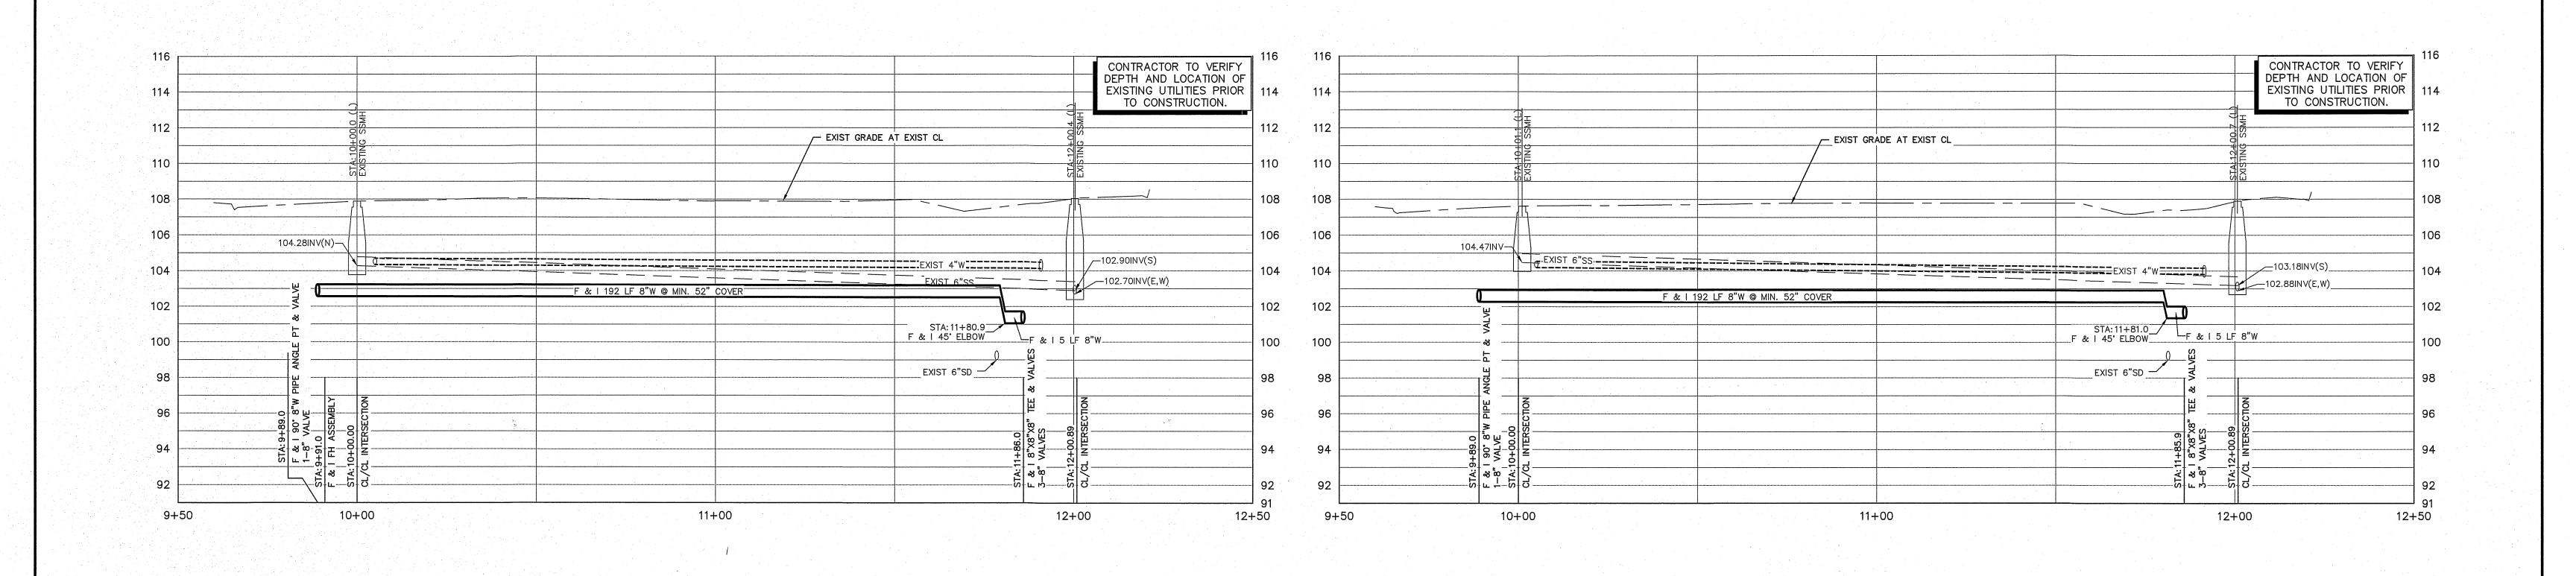
JASON K CHAPMAN No. 66134


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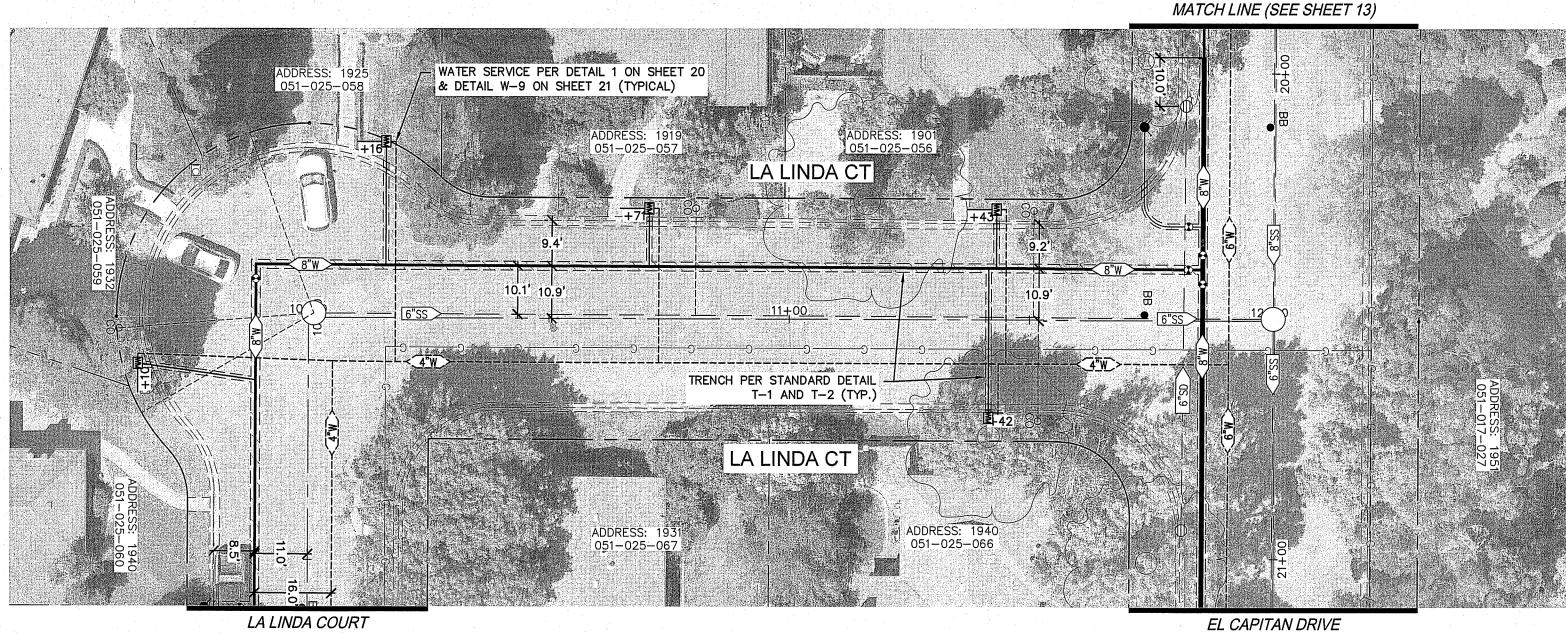
CITY OF TURLOCK

WATER LINE REPLACEMENT PLANS EL CAPITAN DRIVE PLAN AND PROFILE SCALE: AS NOTED DATE: 03/18/2024

DWG NO. 23052DSGN.dwg LAYOUT 13-PP DESCRIPTION DATE BY CHECKED: _





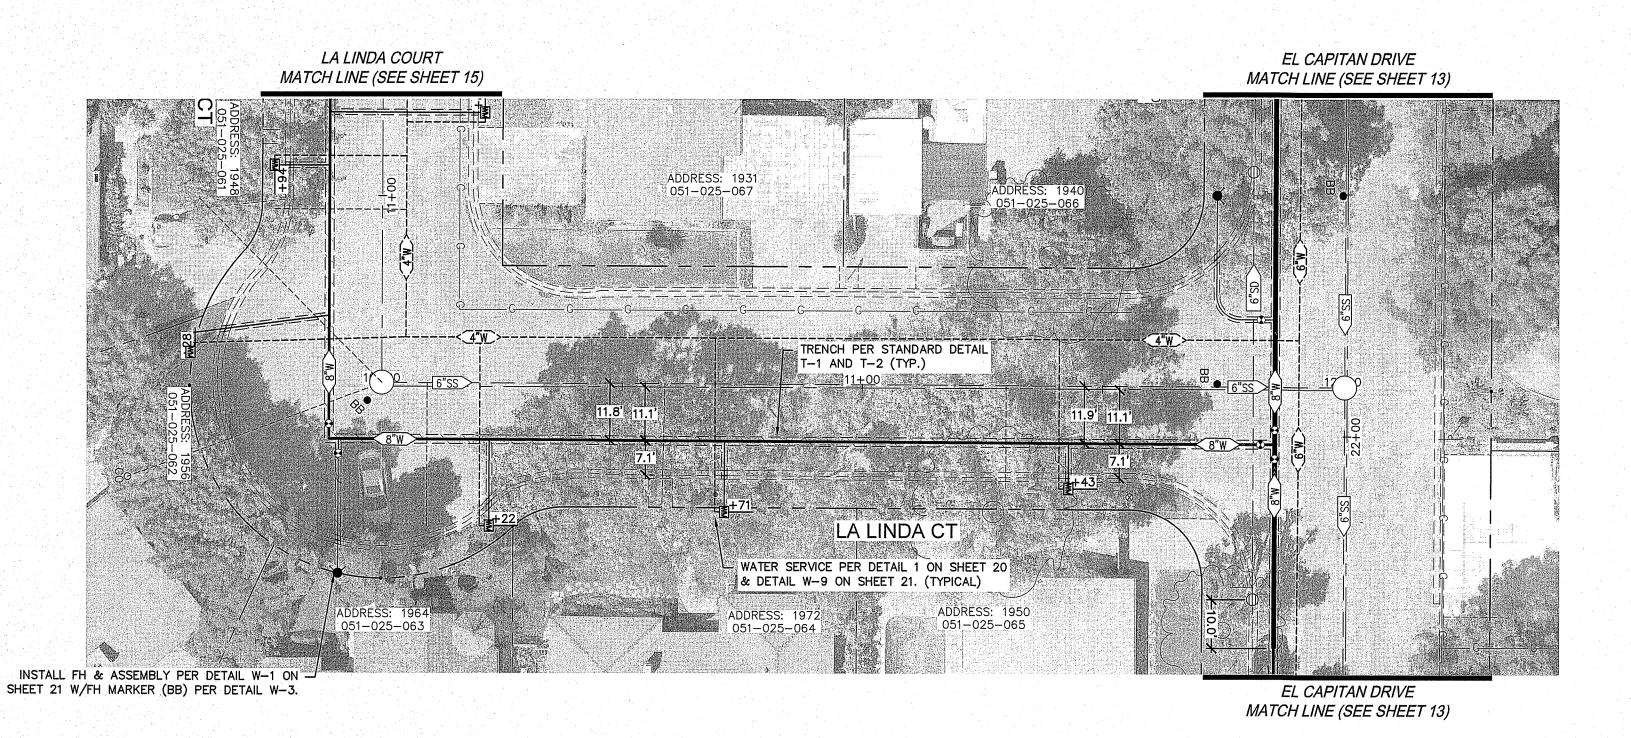

IF NOT A 24"X36", IS A REDUCED PRINT

MATCH LINE (SEE SHEET 13) · JASON K. CHAPMAN No. 66134 3/18/2024

EL CAPITAN DRIVE

SCALE: 1'' = 20' HOR, 1''=4' VERT

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TRENCH PATCH & GRINDING
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MATCH LINE (SEE SHEET 15)

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DATE BY

CHECKED: _

DESCRIPTION

GDR ENGINEERING, INC.

DATE SIGNED:


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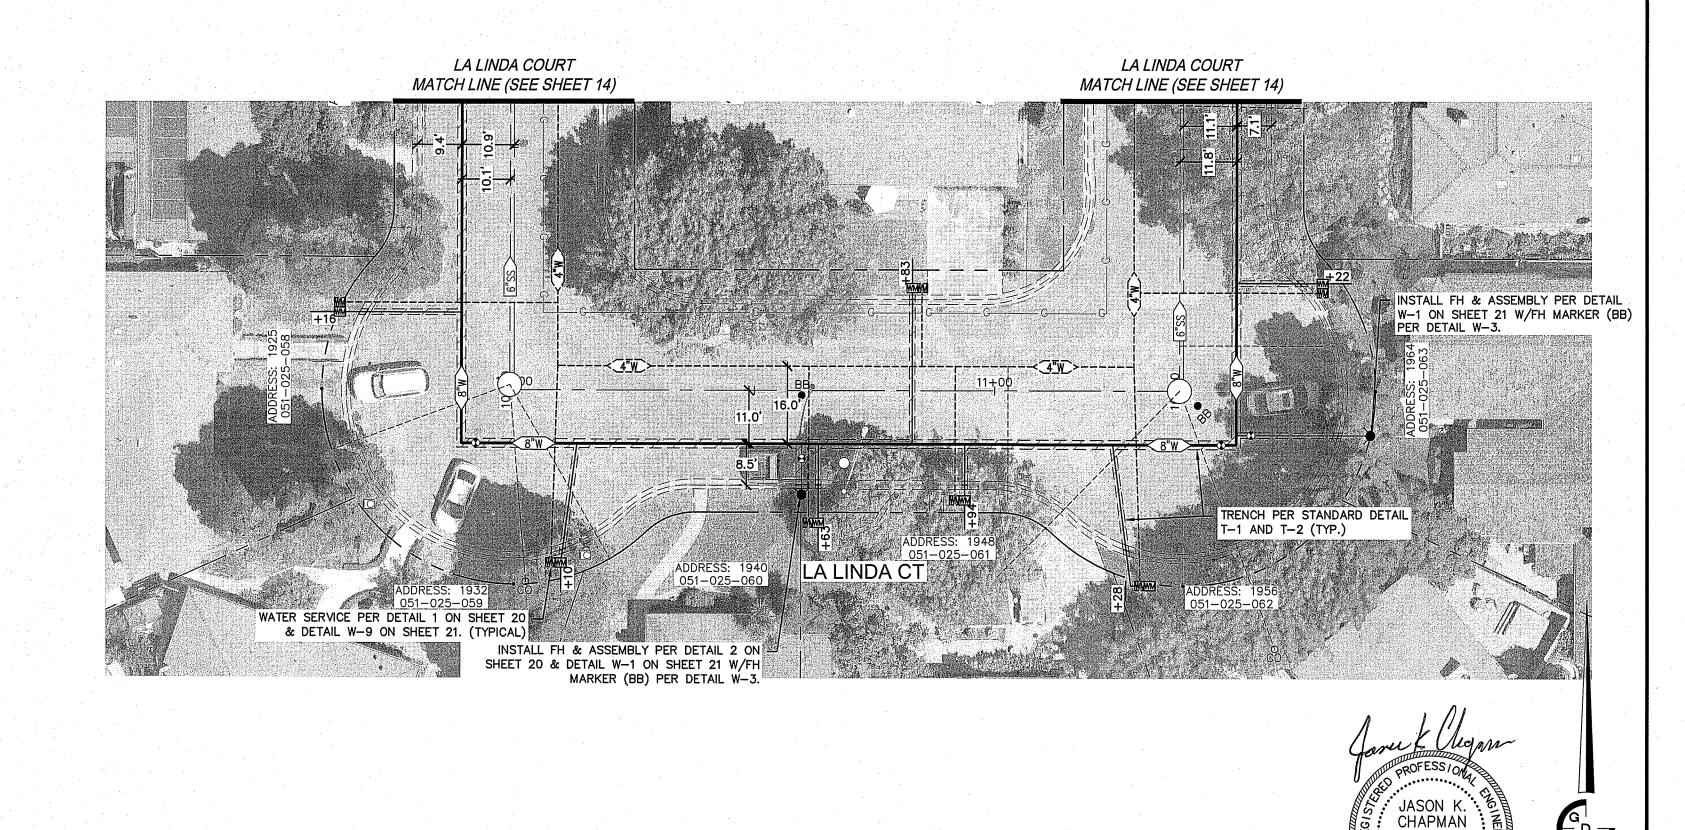
CITY OF TURLOCK WATER LINE REPLACEMENT PLANS LA LINDA COURT EAST & WEST PLAN AND PROFILE SCALE: AS NOTED DATE: 03/18/2024 WG NO. 23052DSGN.dwg LAYOUT 14-PP


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- 2. WATER SERVICE DETAIL AND REMOVAL. (SEE DETAIL 1 SHEET 20 & DETAILS W-9 & W-10 SHEET 21)

 3. CONTRACTOR IS REQUIRED TO HAND DIG TO EXPOSE SIDE OF EXISTING WATER MAIN ALONG NEW WATER MAIN TRENCH TO ESTABLISH EXISTING WATER MAIN ELEVATION
- IN ORDER TO INSTALL PROPOSED WATER MAIN AT THE SAME ELEVATION.
 4. REMOVE & REPLACE STRIPING & LEGEND IN KIND
- 5. INSTALL TYPE G-5 BOXES WITH DIRECTIONAL ARROWS TO SHOW CHANGE IN DIRECTION. (SEE DETAIL 4 SHEET 20 & W-5 SHEET 21. (TYP.) 6. DIRECTIONAL BOXES TO BE PLACED ON ALL 45° ANGLES. (SEE DETAIL 3 SHEET 20)
 7. CONTRACTOR TO USE CITY PROVIDED DOUBLE DETECTOR CHECK VALVE ASSEMBLY.
- 8. WATER SERVICES SHALL BE 1" IN SIZE UNLESS CALLED OUT OTHERWISE 9. WHERE CURBS ARE IDENTIFIED AS 8", CURB STOPS SHALL VARY BETWEEN 8" TO 12" FROM BOTTOM OF LID. PAVING LEGEND:

CAUTION: UNAUTHORIZED CHANGES AND USES THE ENGINEER PREPARING THESE PLANS WILL NOT BE RESPONSIBLE FOR OR LIABLE FOR UNAUTHORIZED CHANGES TO OR USES OF THESE PLANS. ALL
CHANGES TO THE PLANS MUST BE IN WRITING AND MUST BE APPROVED BY
THE PREPARER OF THESE PLANS AND THE CITY ENGINEER.

SCALE: 1" = 20' HOR, 1"=4' VERT

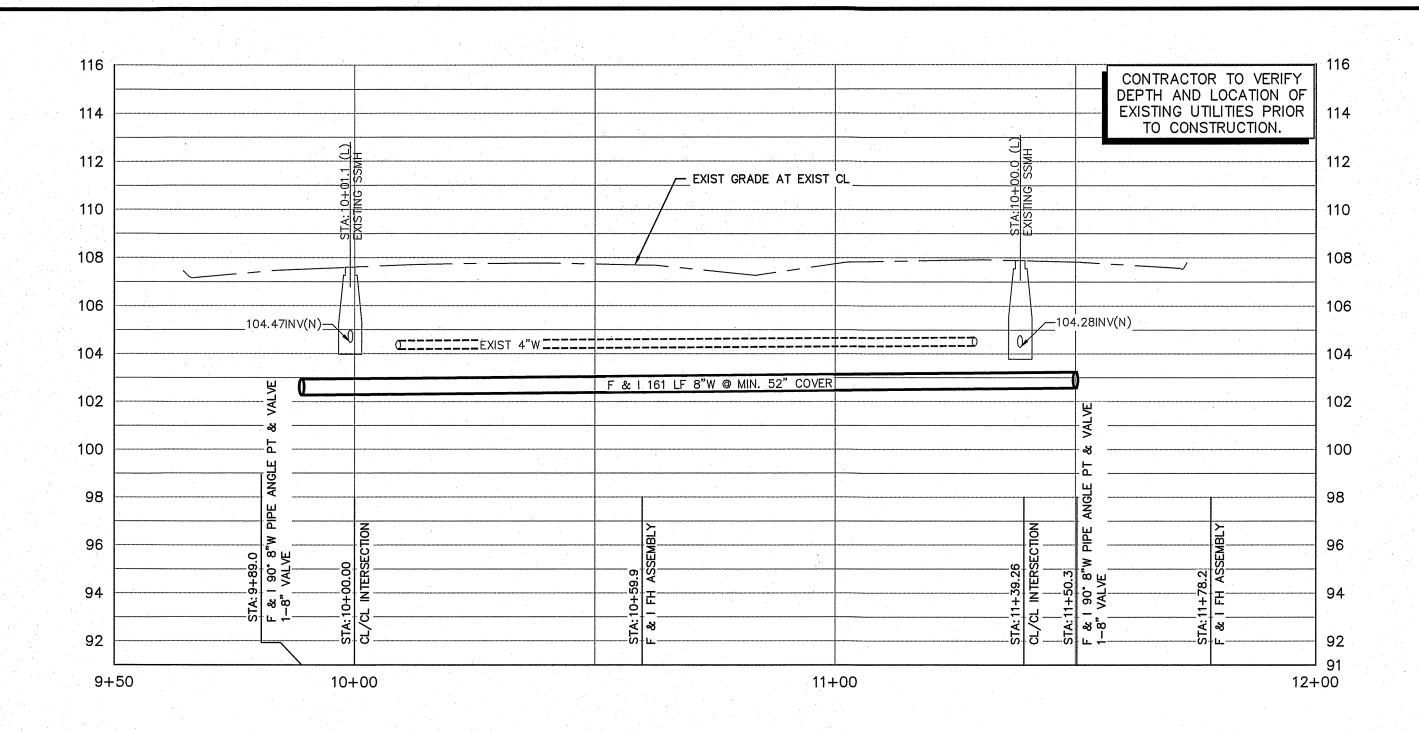IF NOT A 24"X36", IS A REDUCED PRINT

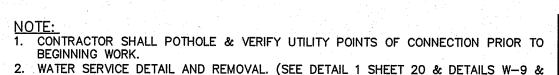3/18/2024 DATE SIGNED: GDR ENGINEERING, INC. ENGINEERING/SURVEYING/PLANNING


No. 66134


3525 MITCHELL ROAD, SUITE G CERES, CA 95307 TELEPHONE: (209) 538-3360 FAX: (209) 538-7370 E-MAIL: GDRENGINEERING@GDRENGR.COM

CITY OF TURLOCK WATER LINE REPLACEMENT PLANS


LA LINDA COURT SOUTH PLAN AND PROFILE SCALE: AS NOTED DATE: 03/18/2024 WG NO. 23052DSGN.dwg LAYOUT 15-PP SHEET: 15 OF 2 AWN: JA DESCRIPTION DATE BY CHECKED: ____

TRENCH PATCH & GRINDING
SEE TRENCH PATCH DETAIL T-1 AND T-2

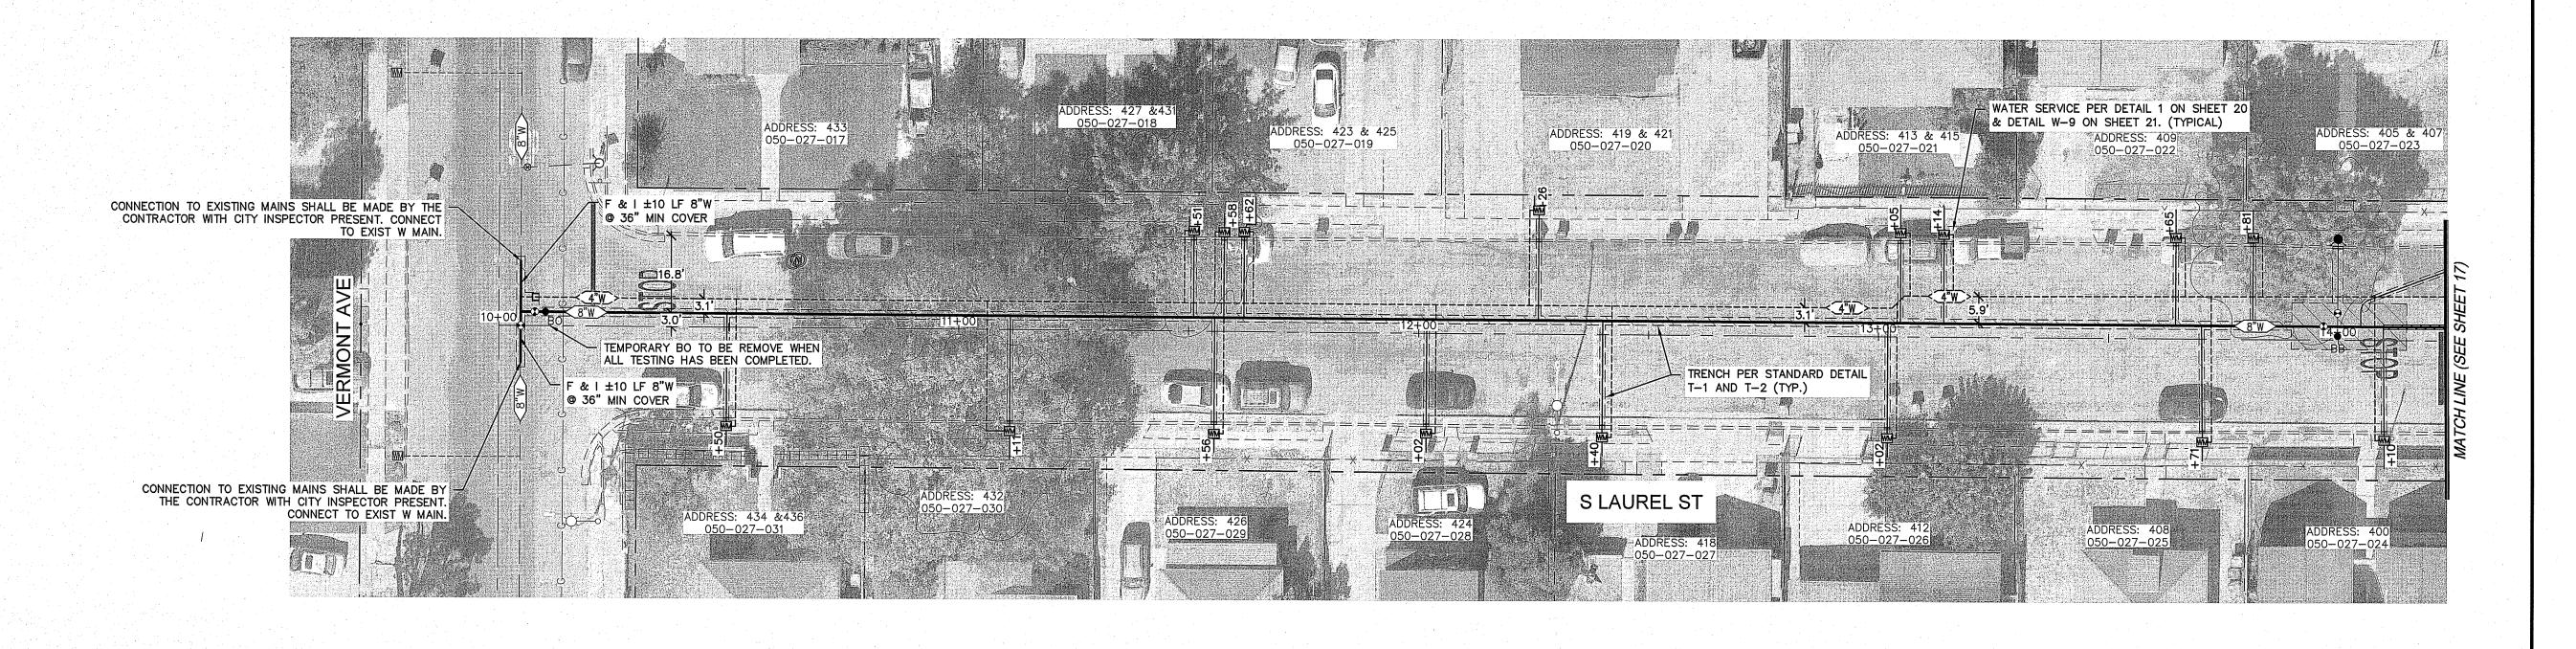

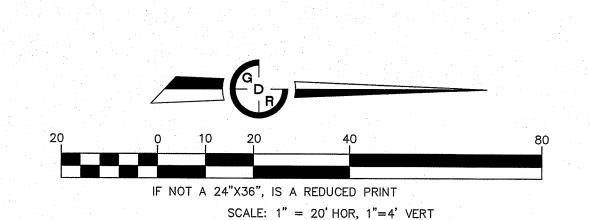

CAUTION:

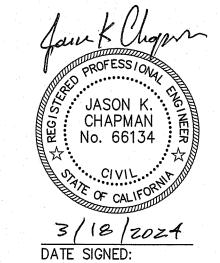

GDR ENGINEERING, INC.

ENGINEERING/SURVEYING/PLANNING

NOTE:

1. CONTRACTOR SHALL POTHOLE & VERIFY UTILITY POINTS OF CONNECTION PRIOR TO BEGINNING WORK.

AND DEMOVAL (SEE DETAIL 1 SHEET 20 & DETAILS W-9 & 2. WATER SERVICE DETAIL AND REMOVAL. (SEE DETAIL 1 SHEET 20 & W-10 SHEET 21)

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PAVING LEGEND:

TRENCH PATCH & GRINDING SEE TRENCH PATCH DETAIL T-1 AND T-2

ECTION PRIOR TO	CAUTION:
DETAILS W-9 &	UNAUTHORIZED CHANGES AND USES
TING WATER MAIN MAIN ELEVATION ATION.	THE ENGINEER PREPARING THESE PLANS WILL NOT BE RESPONSIBLE FOR OR LIABLE FOR UNAUTHORIZED CHANGES TO OR USES OF THESE PLANS. ALL CHANGES TO THE PLANS MUST BE IN WRITING AND MUST BE APPROVED BY THE PREPARER OF THESE PLANS AND THE CITY ENGINEER.
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AIL 3 SHEET 20) LVE ASSEMBLY.	
BETWEEN 8" TO	

3525 MITCHELL ROAD, SUITE G CERES, CA 95307 TELEPHONE: (209) 538-3360 FAX: (209) 538-7370 PREPARER OF THESE PLANS AND THE CITY ENGINEER. E-MAIL: GDRENGINEERING@GDRENGR.COM CITY OF TURLOCK


WATER LINE REPLACEMENT PLANS S LAURAL STREET PLAN AND PROFILE SCALE: AS NOTED DATE: 03/18/2024 DWG NO. 23052DSGN.dwg LAYOUT 16-PP

FILE NO. 23052 DESCRIPTION DATE BY CHECKED: _

UNDERGROUND FACILITIES SHOWN WERE LOCATED BASED ON INFORMATION PROVIDED BY UTILITY COMPANIES AND BY MEASURING SURFACE FEATURES. NO ATTEMPT WAS MADE TO LOCATE OTHER UNDERGROUND FACILITIES THAT WERE NOT READILY APPARENT FROM A VISUAL INSPECTION OF SURFACE FEATURES.

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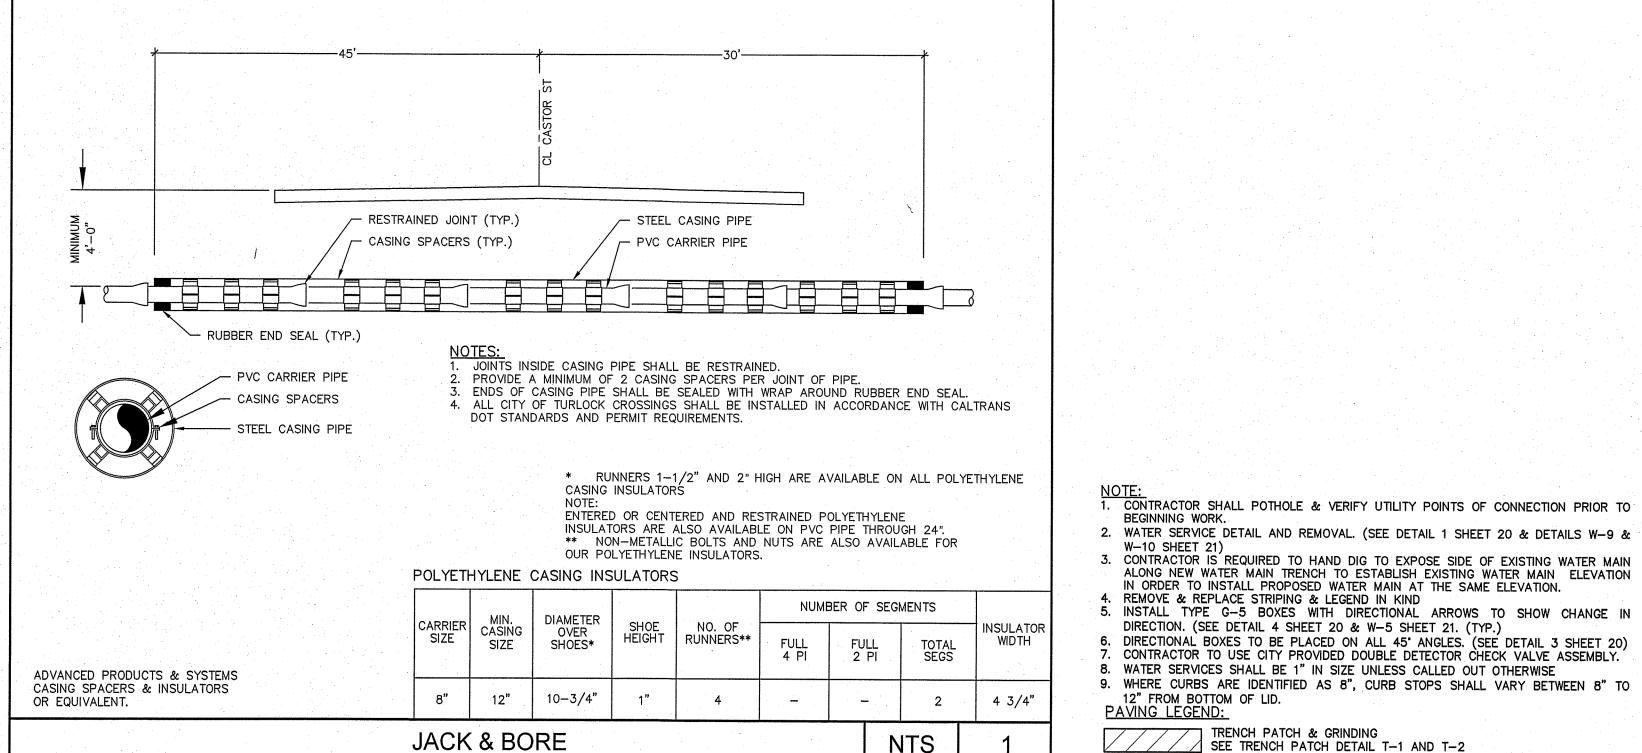
TRENCH PATCH & GRINDING

8. WATER SERVICES SHALL BE 1" IN SIZE UNLESS CALLED OUT OTHERWISE

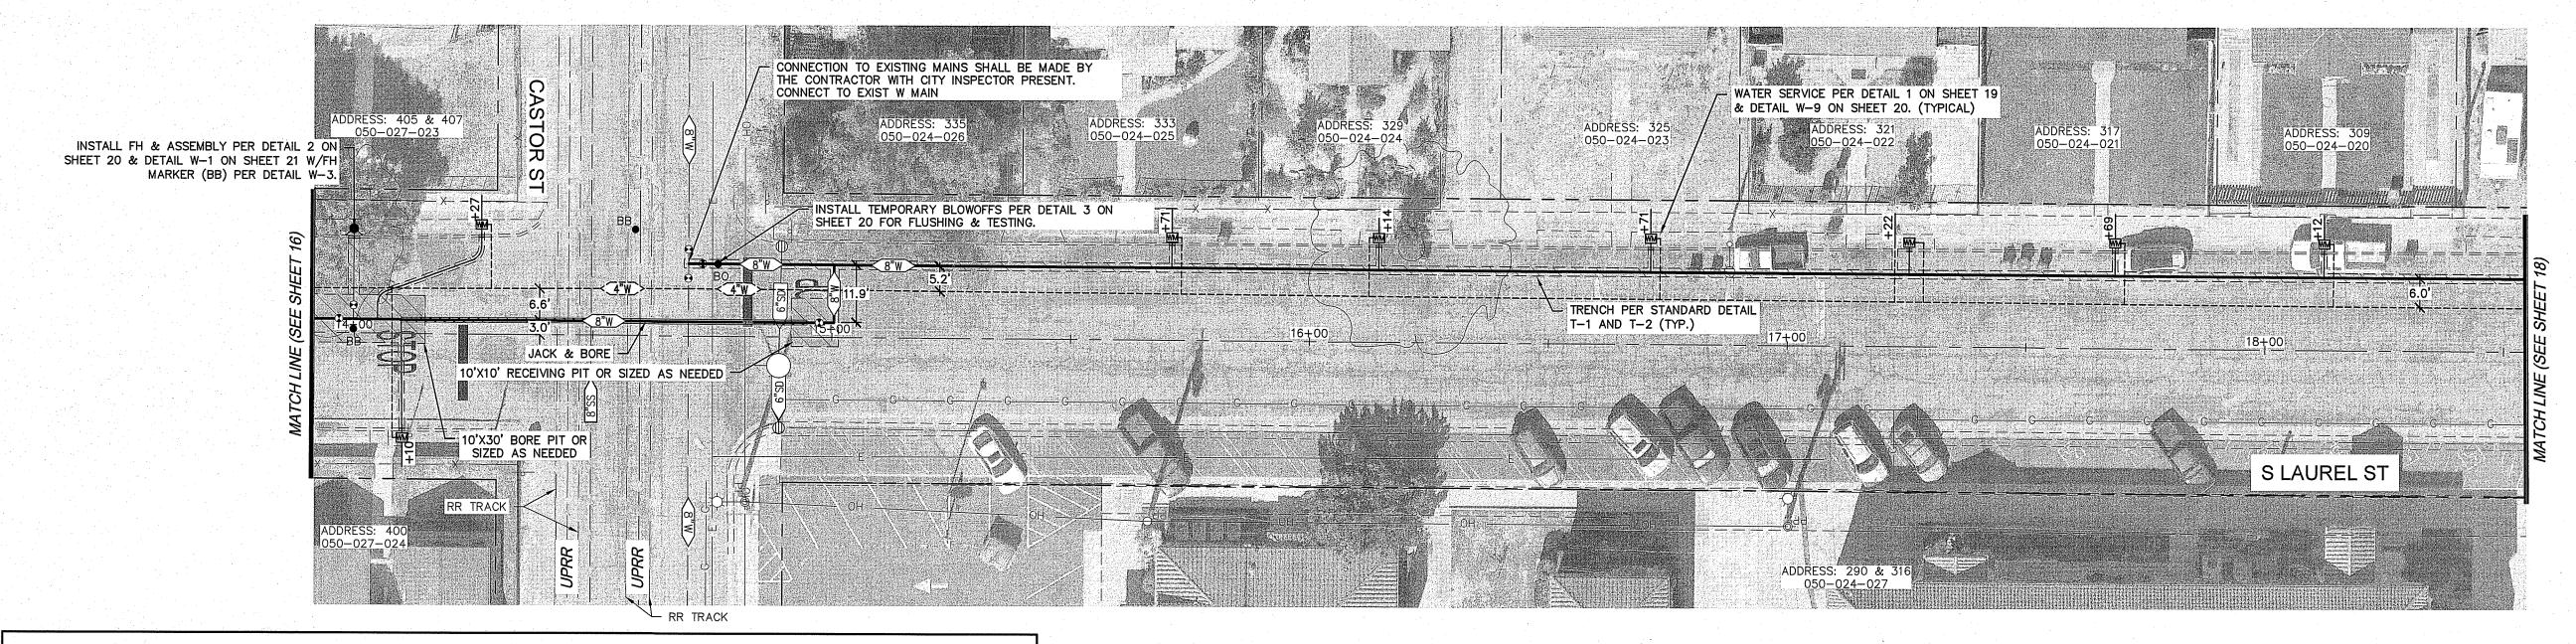SEE TRENCH PATCH DETAIL T-1 AND T-2

BEGINNING WORK.

12" FROM BOTTOM OF LID.
PAVING LEGEND:



IF NOT A 24"X36", IS A REDUCED PRINT SCALE: 1" = 20' HOR, 1"=4' VERT

JASON K. CHAPMAN No. 66134 3/18/2024

DATE SIGNED:

CAUTION:

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GDR ENGINEERING, INC. ENGINEERING/SURVEYING/PLANNING 3525 MITCHELL ROAD, SUITE G CERES, CA 95307 TELEPHONE: (209) 538-3360 FAX: (209) 538-7370 E-MAIL: GDRENGINEERING@GDRENGR.COM

CITY OF TURLOCK WATER LINE REPLACEMENT PLANS


S LAURAL STREET PLAN AND PROFILE


9. WHERE CURBS ARE IDENTIFIED AS 8", CURB STOPS SHALL VARY BETWEEN 8" TO DATE: 03/18/2024 DWG NO. 23052DSGN.dwg SHEET: 17 OF 2 DESCRIPTION

UNDERGROUND FACILITIES.


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CAUTION:

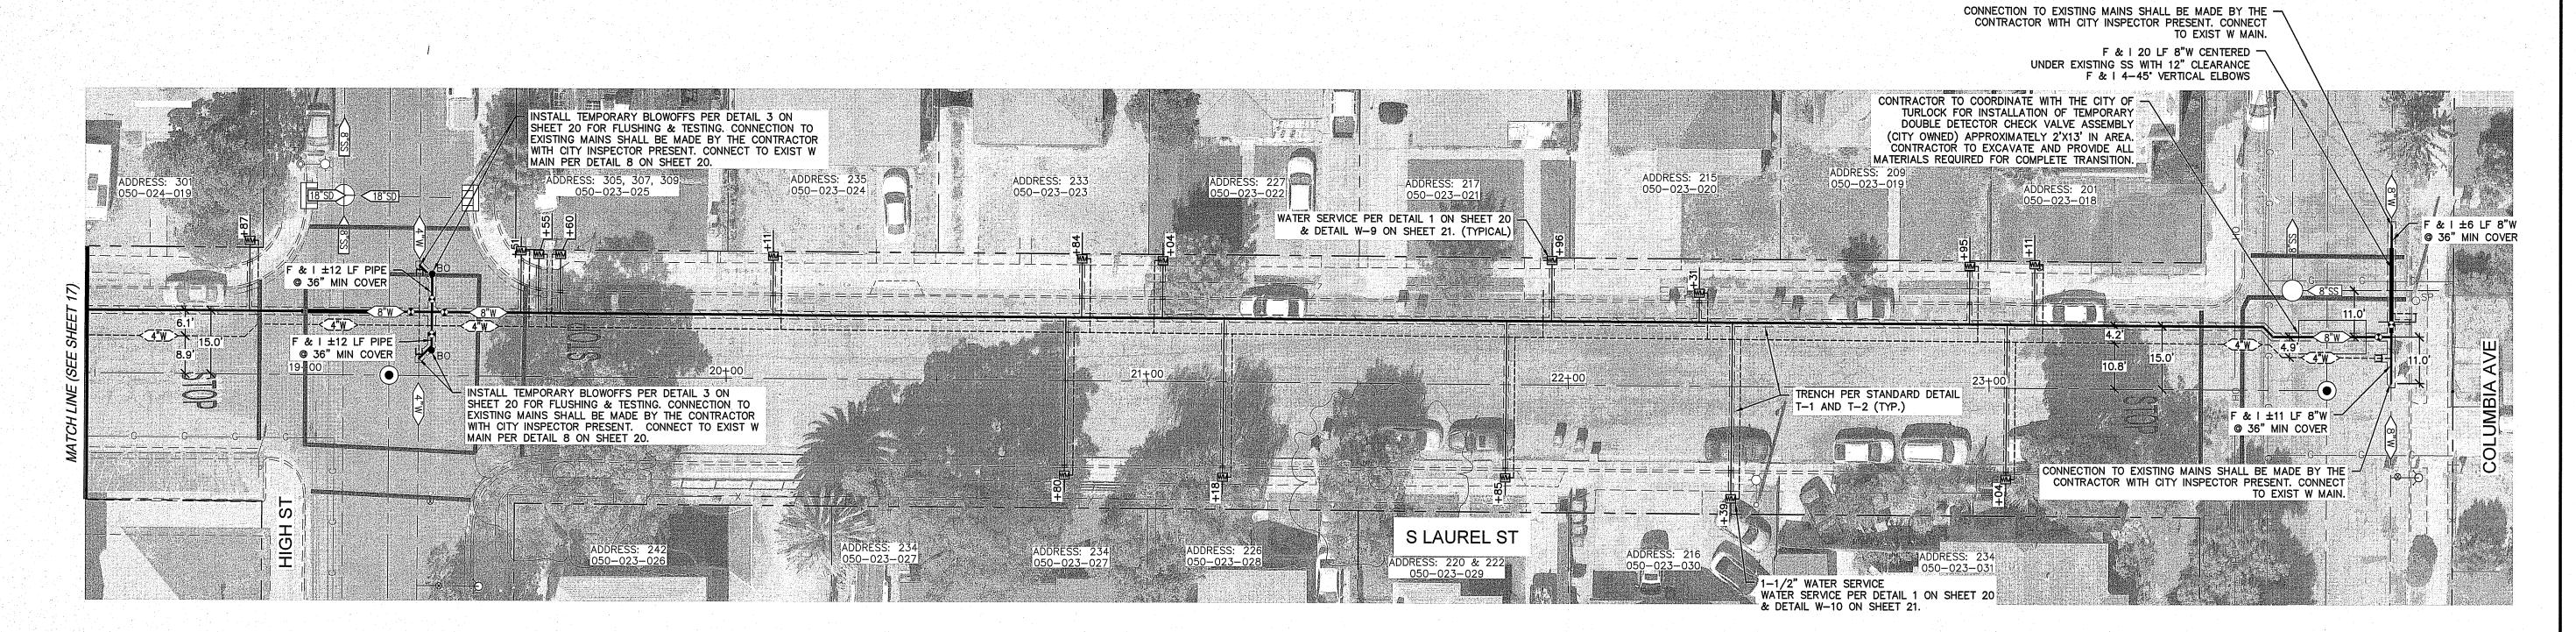

GDR ENGINEERING, INC.

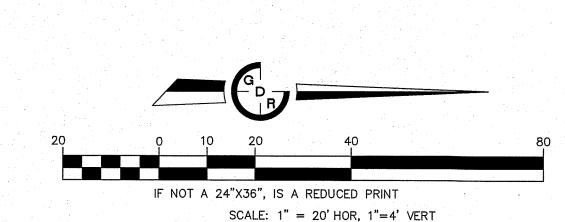ENGINEERING/SURVEYING/PLANNING

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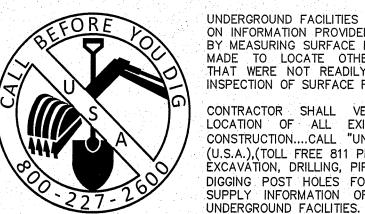
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TRENCH PATCH & GRINDING SEE TRENCH PATCH DETAIL T-1 AND T-2
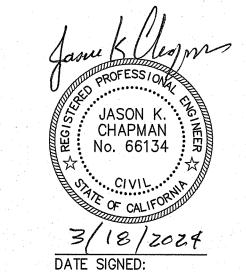
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E TWEEN 8" TO	


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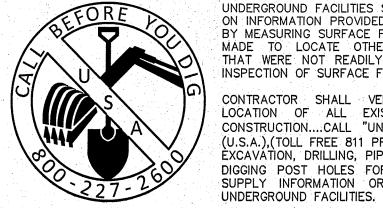
WATER LINE REPLACEMENT PLANS S LAURAL STREET PLAN AND PROFILE SCALE: AS NOTED DATE: 03/18/2024 wg NO. 23052DSGN.dwg LAYOUT 18-PP SHEET: 18 OF 21 DESCRIPTION DATE BY CHECKED:



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PAVING LEGEND:

TRENCH PATCH & GRINDING

SEE TRENCH PATCH DETAIL T-1 AND T-2

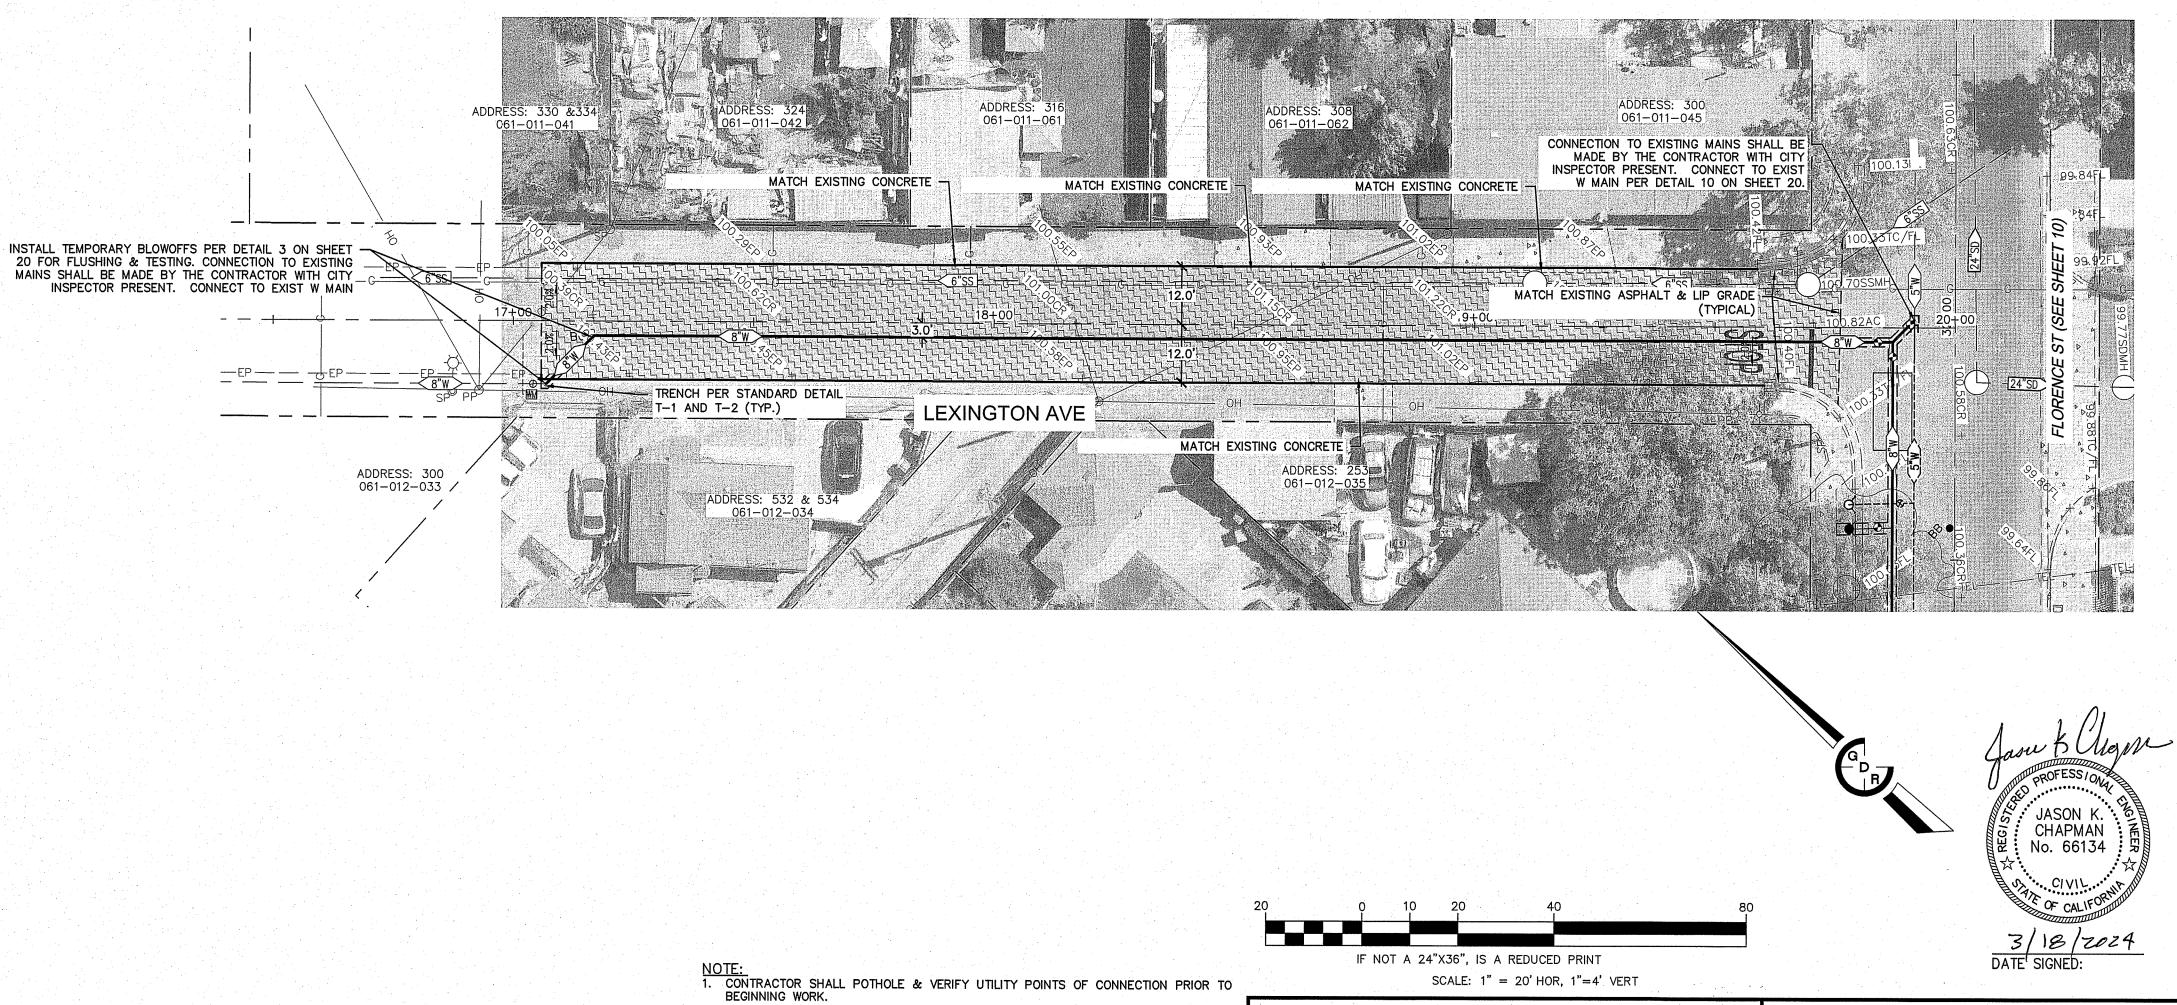FULL PAVEMENT SECTION PER CITY STANDARD ST-1 3" ASPHALTIC CONCRETE OVER 6" AGGREGATE BASE @ 95% RELATIVE COMPACTION OVER 6" RECOMPACTED NATIVE SOIL

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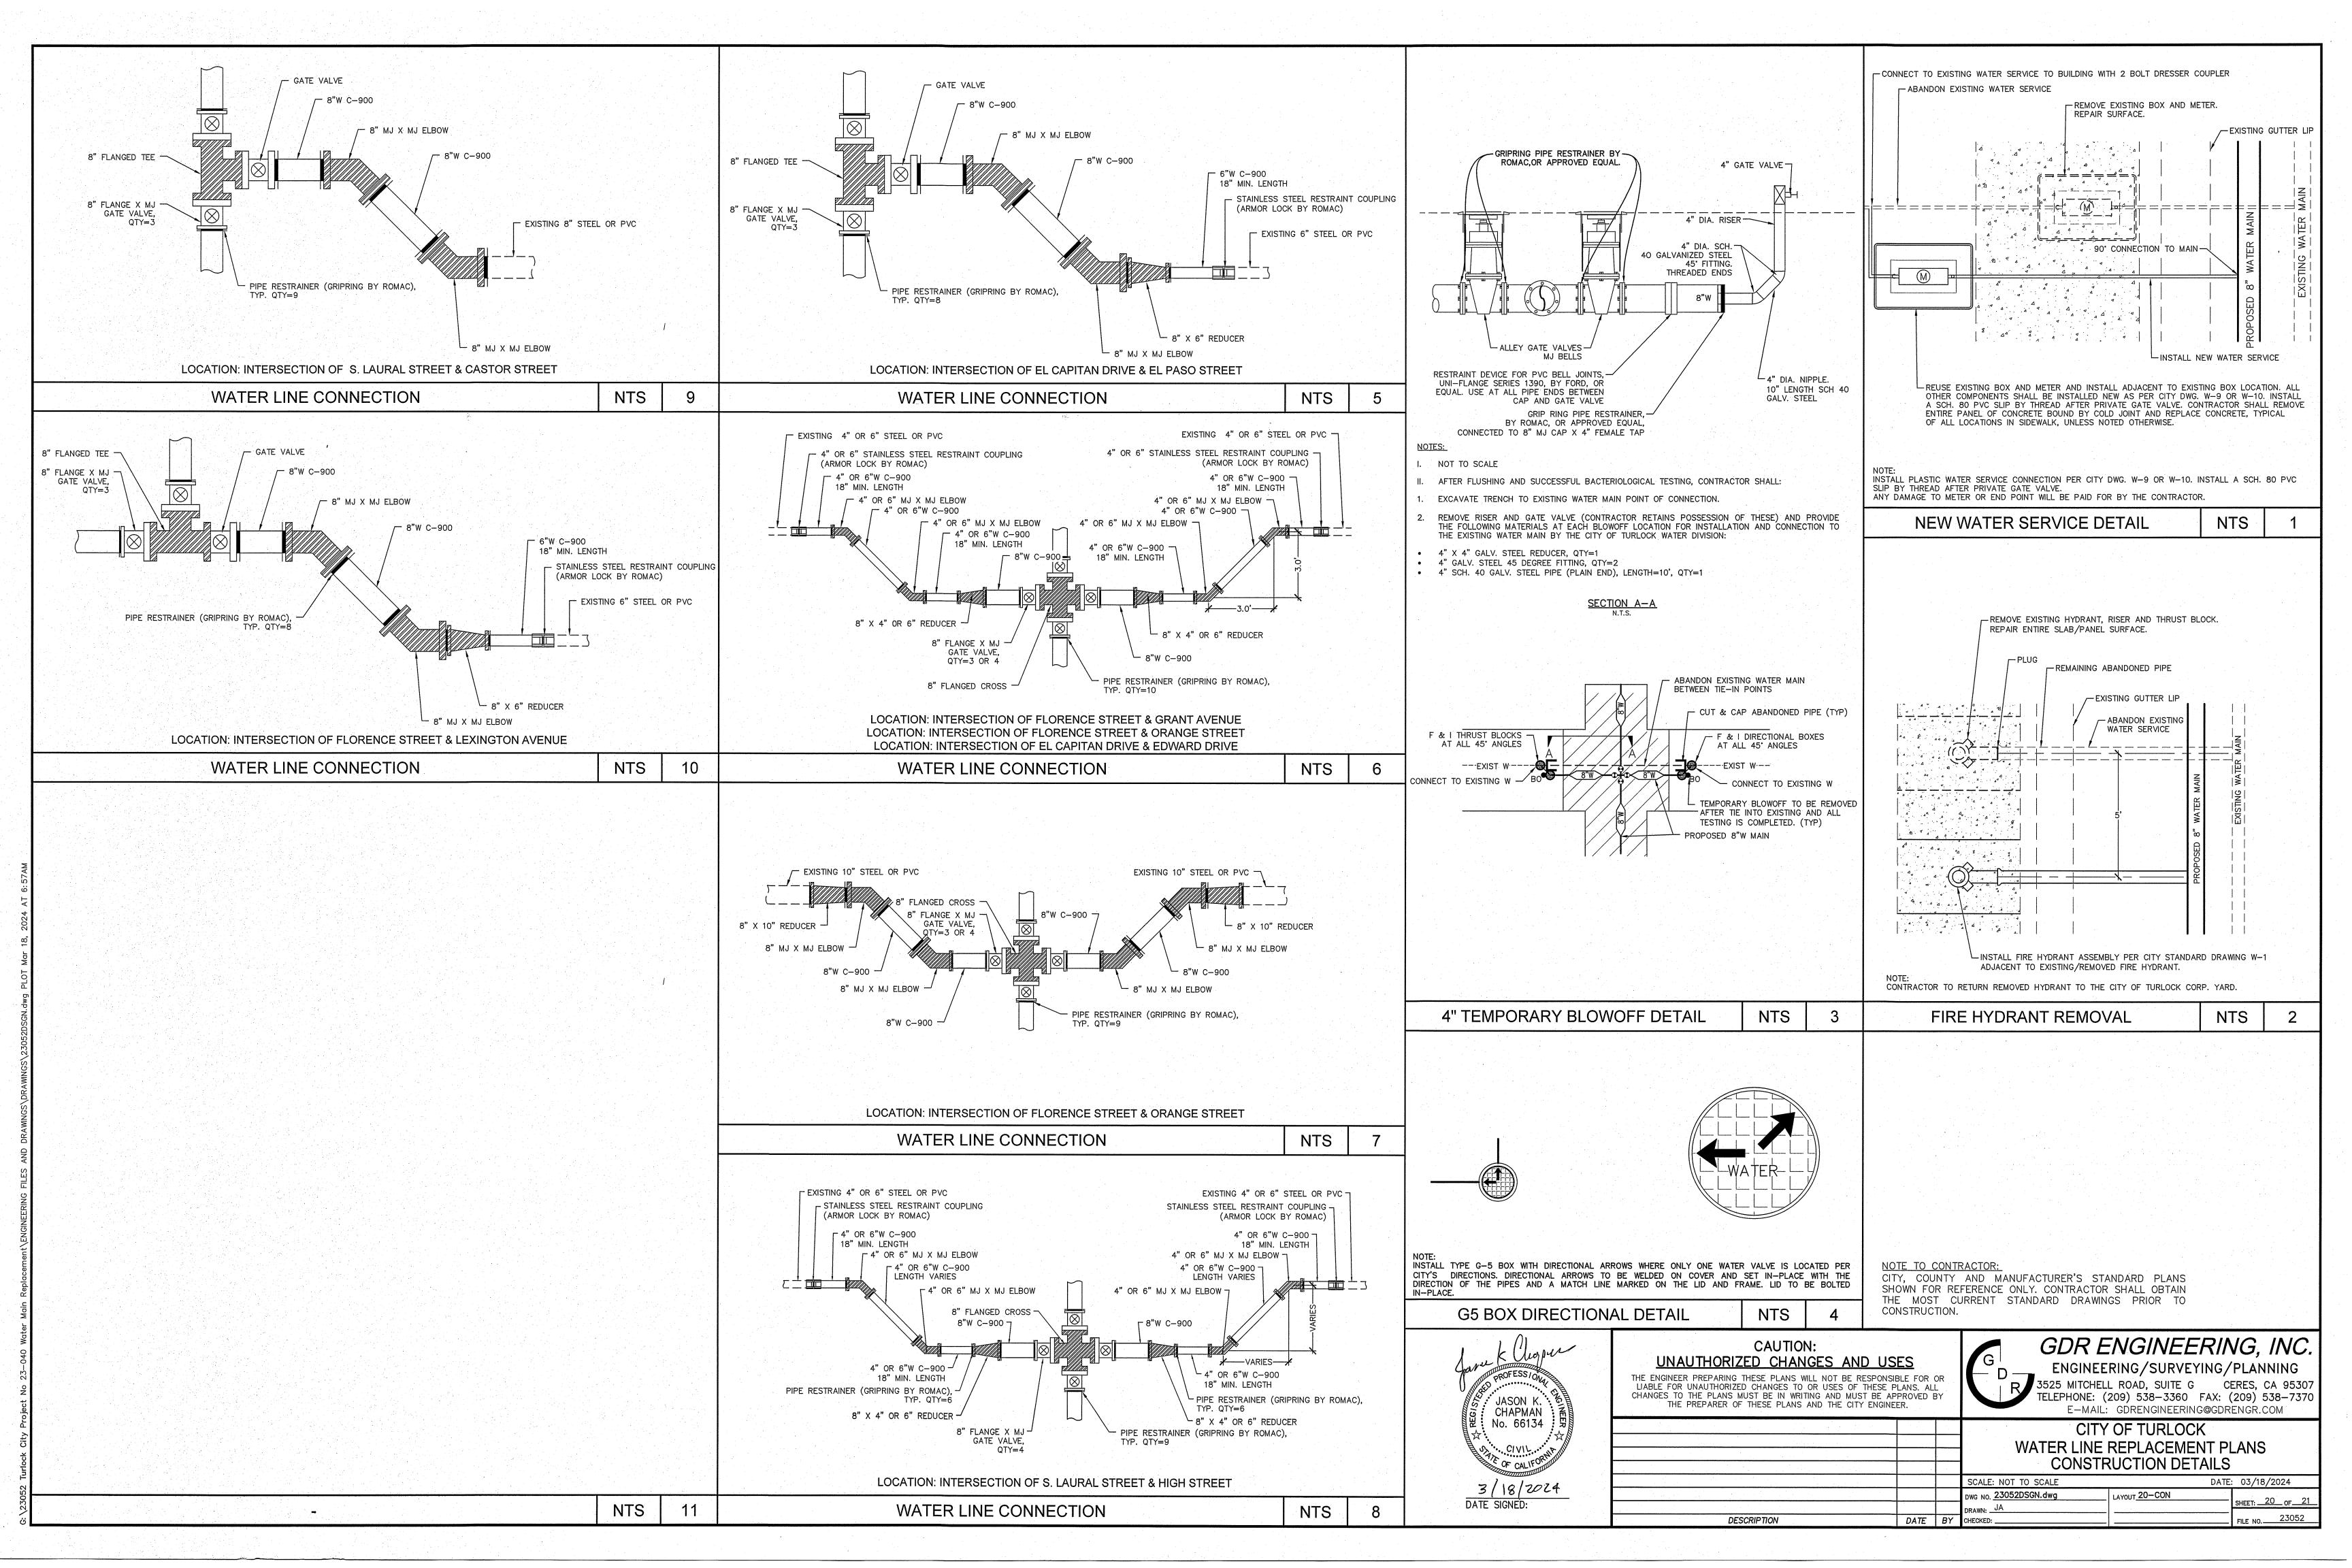
THE PREPARER OF THESE PLANS AND THE CITY ENGINEER.


GDR ENGINEERING, INC. ENGINEERING/SURVEYING/PLANNING

ENGINEERING/SURVETING/TEMES, CA 95307
3525 MITCHELL ROAD, SUITE G CERES, CA 95307
TELEPHONE: (209) 538-3360 FAX: (209) 538-7370
E-MAIL: GDRENGINEERING@GDRENGR.COM CITY OF TURLOCK

WATER LINE REPLACEMENT PLANS LEXINGTON AVENUE PLAN AND PROFILE

SCALE: AS NOTED DATE: 03/18/2024 DWG NO. 23052DSGN.dwg SHEET: 19 OF 2 DATE BY CHECKED:



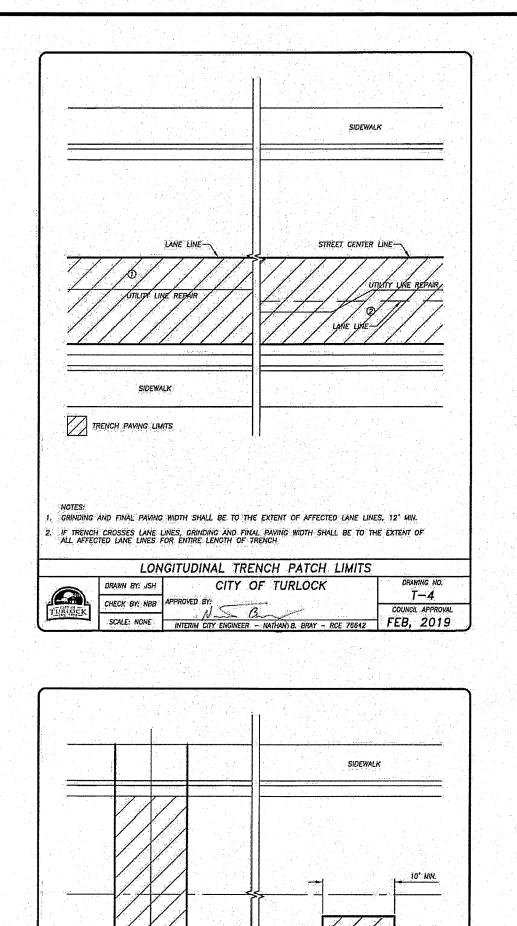

T-5

TRENCH PAVING LIMITS

DRAWN BY: JSH

CHECK BY: NBB APPROVED BY:


1. GRINDING AND PAVING WIDTH SHALL BE 10' MIN.

2. ALL CUTS SHALL BE SQUARE AND PERPENDICULAR TO THE TRAVEL LANE

PERPENDICULAR TRENCH PATCH LIMITS

CITY OF TURLOCK

SCALE: NONE INTERIM CITY ENGINEER - NATHAN B. BRAY - RCE 76642 FEB, 2019

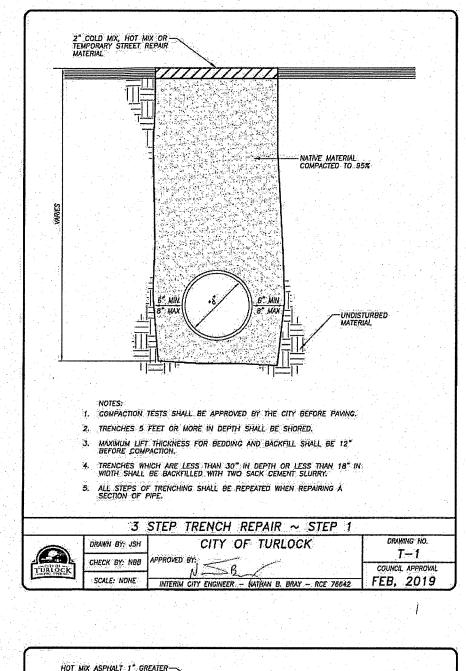

6 AGGREGATE BASE, CLASS 2.

1: STEP 1 MAY BE OMITTED IF STEP 2 IS PERFORMED SAME DAY AS TRENCH EXCAVATION

3. TRENCHES 5 FEET OR MORE IN DEPTH SHALL BE SHORED.

CHECK BY: NBB APPROVED BY

SCALE: NONE

2. COMPACTION TESTS SHALL BE APPROVED BY THE CITY BEFORE PAYING.

4. MAXIMUM LIFT THICKNESS FOR BEDDING AND BACKFILL SHALL BE 12" BEFORE COMPACTION.


5. TRENCHES WHICH ARE LESS THAN 30" IN DEPTH OR LESS THAN 18" IN WIDTH SHALL BE BACKFILLED WITH TWO SACK CEMENT SLURRY.


3 STEP TRENCH REPAIR ~ STEP 2

CITY OF TURLOCK

IMERIM CITY ENGINEER - NATHAN EL BRAY - RCE 76642 FEB, 2019


6. ALL STEPS OF TRENCHING SHALL BE REPEATED WHEN REPAIRING A SECTION OF PIPE:

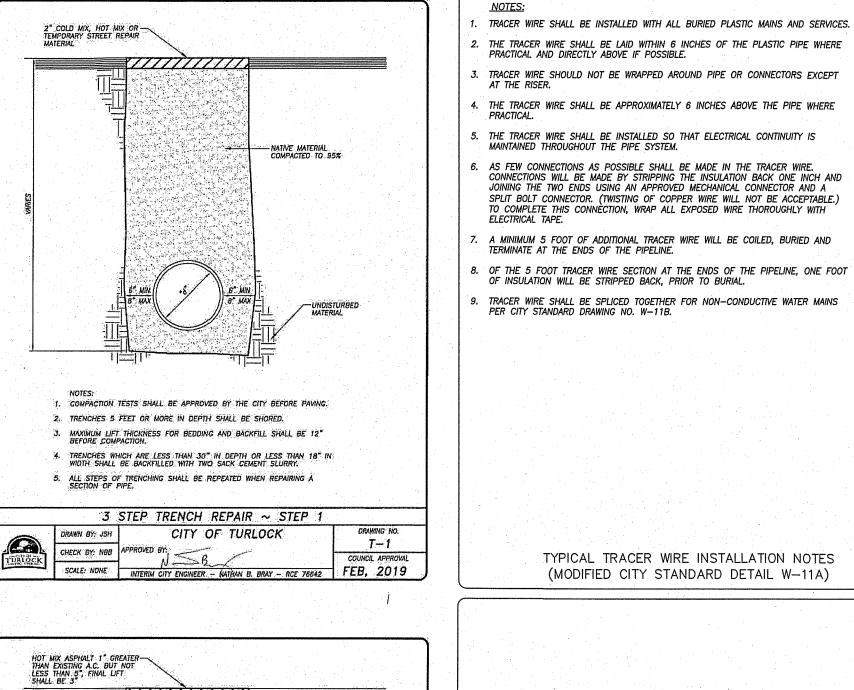


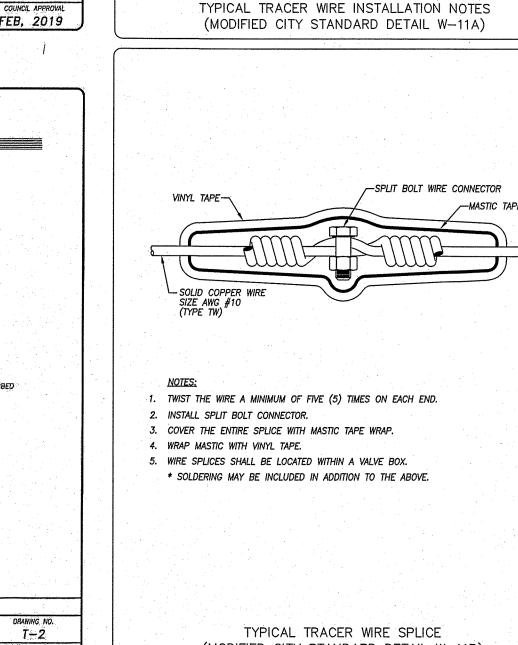

STANDARD WATER UNDER CROSSING


(MODIFIED CITY STANDARD DETAIL W-14)

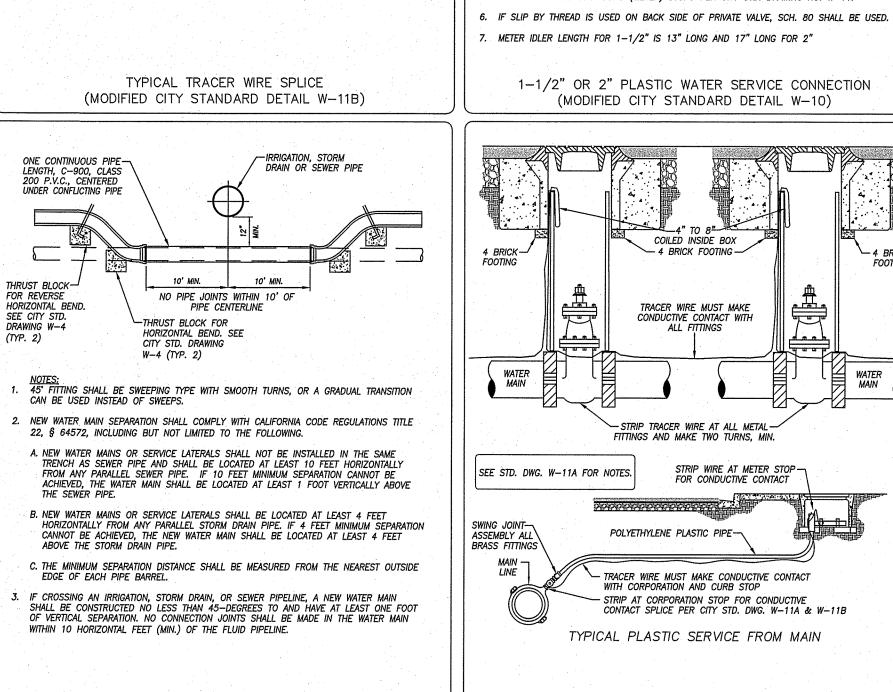

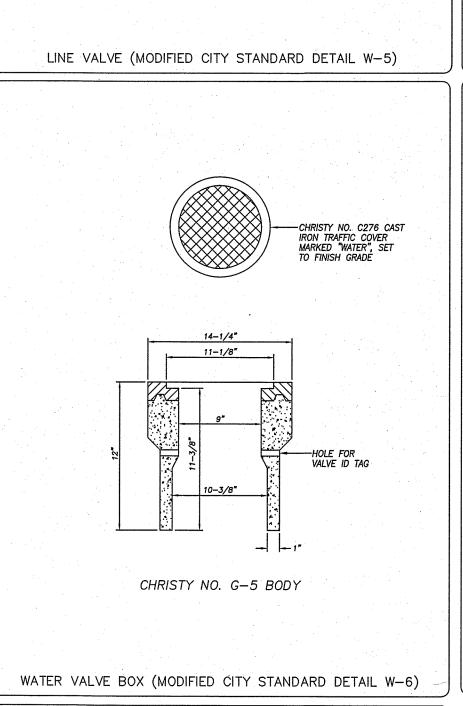

<u>m m m</u>

IF DEPTH IS GREATER THAN 48" VALVE, NUT EXTENSION SHALL BE REQUIRED.

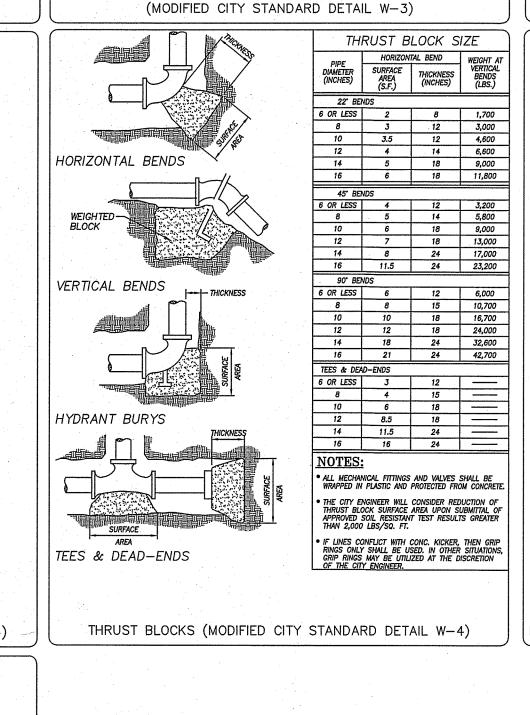

FIRE HYDRANT PAVEMENT MARKER LOCATION

MULTI LANE STREET

AT INTERSECTION

TWO LANE STREET


TWO LANE STREET AT INTERSECTION


EXPRESSWAYS

■ BLUE PAVEMENT MARKER (TYPE BB)

LEGEND

FH-Q FIRE HYDRANT

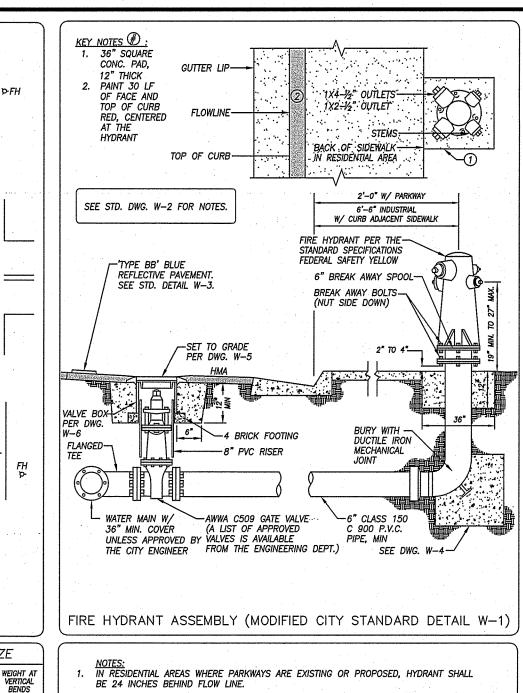


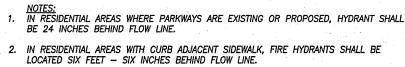


- FIRE HYDRANTS SHALL BE LOCATED A. AT STREET CORNERS WHENEVER POSSIBLE
- B. IN RESIDENTIAL ZONED AREAS, NO MORE THAN 500 FEET APART AND NOT GREATER THAN 300 FEET FROM DEAD-END STREETS
- C. FOR ALL OTHER ZONES: NO MORE THAN 300 FEET APART AND NOT GREATER THAN 300 FEET FROM DEAD—END STREETS
- OTHER LOCATIONS DEEMED NECESSARY BY THE CITY ENGINEER TO PROVIDE ADEQUATE FIRE PROTECTION TO THE PROPERTY.
- ON ARTERIAL, EXPRESSWAY, OR DIVIDED COLLECTOR STREETS, AS DESIGNATED IN THE GENERAL PLAN, SPECIFICATIONS, AND MASTER PLANS. THE HYDRANT SPACING SHALL BE APPLICABLE TO EACH SIDE OF THE STREETS.
- MINIMUM 36" CLEARANCE AROUND ALL FIRE HYDRANTS TO INCLUDE ALL DRIVEWAYS.
- . IF BOLLARDS ARE REQUIRED IN PROJECT PLANS, BOLLARDS SHALL COMPLY WITH ALL OF THE FOLLOWING REQUIREMENTS AND BE IN ACCORDANCE WITH CITY STD. DWG. ST-22.


 A. SPACED NOT MORE THAN 3 FEET BETWEEN POSTS ON CENTER.
- B. LOCATED NOT LESS THAN 3 FEET FROM THE PROTECTED OBJECT.

FIRE HYDRANT LOCATIONS (MODIFIED CITY STANDARD DETAIL W-2)

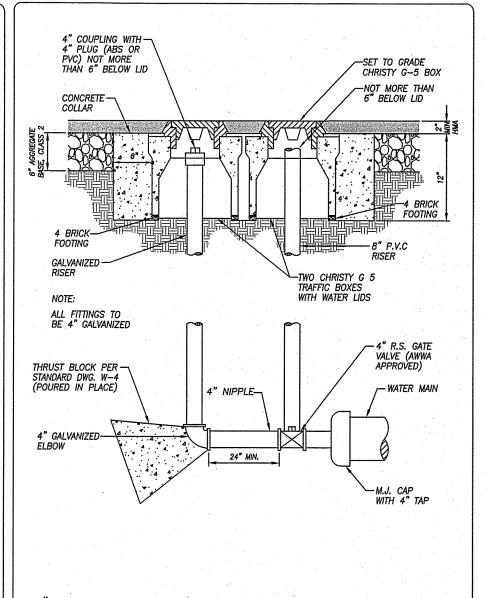


CITY, COUNTY AND MANUFACTURER'S STANDARD PLANS SHOWN FOR REFERENCE ONLY. CONTRACTOR SHALL OBTAIN THE MOST CURRENT STANDARD DRAWINGS PRIOR TO

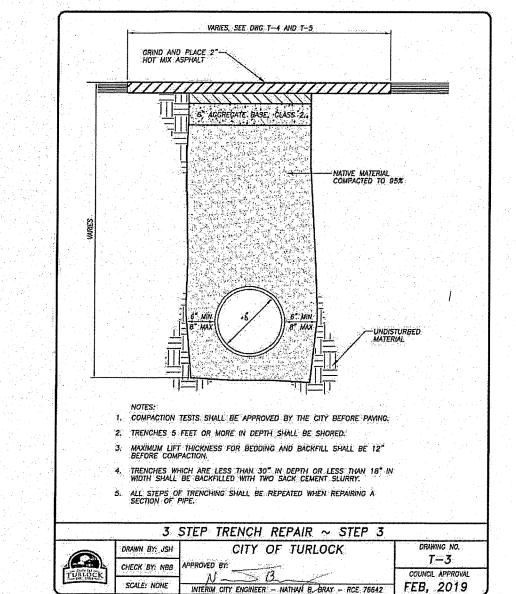

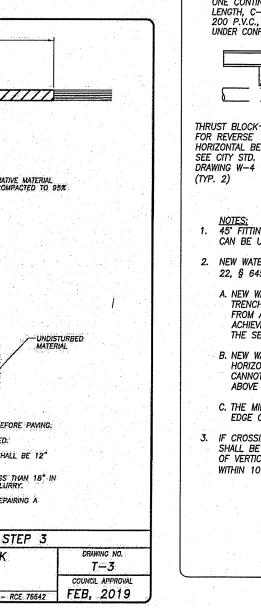

COUNCIL APPROVAL

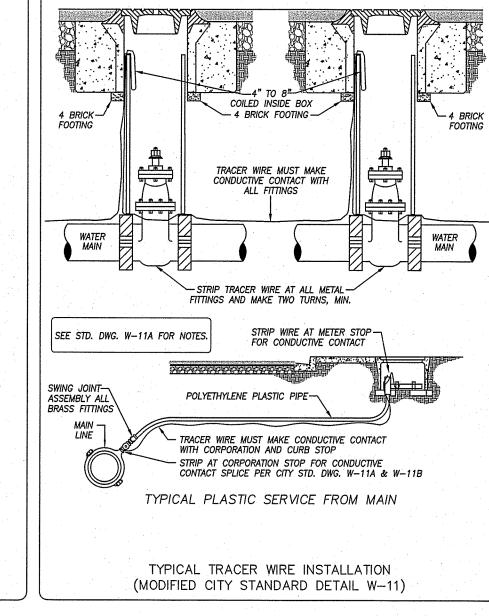

(TYP. 2)

STAINLESS STEEL MORTARED BOTTOM DRAIN INSERT TO 1" WEEP HOLE

-ONE 4" BRICK

—SEAL PENETRATIONS

-ONE 4" BRICK

(TYP. 2)

TO 1" WEEP HOLE

STAINLESS STEEL MORTARED BOTTOM DRAIN INSERT TO 1" WEEP HOLE

SEE STANDARD DWG. NO. W-6

BRICK FOOTING— (4 EACH)

TRACER WIRE-

4" TO 8" COILED -

8" DIA. PVC RISER-

SPECIFICATIONS

SEE DETAILS BELOW

- PACK JOINT ASSEMBLY JONES E-2606 OR APPROVED EQUAL

CLAMP, ROMAC 202NS, MUELLER

CURB STOP (BALL METER VALVE TYPE),
FORD BA-63-444W, JONES J-1962W
OR APPROVED EQUAL WITH STAINLESS
STEEL INSERT, JONES J-2805, FORD
INSERT-74 FOR 1-1/2" OR INSERT-75

FOR 2" OR APPOVED EQUAL

CURB STOP (BALL METER VALVE TYPE),— FORD BA-63-444W, JONES J-1962W OR APPROVED EQUAL WITH STAINLESS STEEL INSERT, JONES J-2806, FORD INSERT-53-72 OR APPROVED EQUAL

-3/4" OR 1" DIA. PLASTIC

-SWING JOINT ASSEMBLY

PRIVATE BRASS GLOBE VALVE PER STANDARD -

SPECIFICATIONS. IF SERVICE HAS A BACKFLOW DEVICE, LOCATE VALVE PER CITY STD. DWG. W-13

ALL BOX COVERS SHALL BE SET TO GRADE AND SHALL NOT BE SITUATED IN DRIVEWAYS OR

2. CURB STOP SHALL VARY BETWEEN 6" TO 10" FROM BOTTOM OF LID. WHERE CURBS ARE IDENTIFIED AS 8", CURB STOPS SHALL VARY BETWEEN 8" TO 12" FROM BOTTOM OF LID.

4. A "W", 3" HIGH, SHALL BE STAMPED OR CHISELED ON THE CURB FACE OVER SERVICE LINES.

5. PLACE A #12 TRACER WIRE IN THE SERVICE TRENCH TO MAKE CONDUCTIVE CONTACT WITH

6. IF SLIP BY THREAD IS USED ON BACK SIDE OF PRIVATE VALVE, SCH. 80 SHALL BE USED.

3/2" OR 1" PLASTIC WATER SERVICE CONNECTION

(MODIFIED CITY STANDARD DETAIL W-9)

1-1/2" OR 2" DIA. PLASTIC SEE DETAILS BELOW

THE CORPORATION AND CURB (METER) STOPS PER CITY STD. DRAWING NO. W-11.

7. METER IDLER LENGTH FOR 3/4" IS 7-1/2" LONG AND 10-1/4" LONG FOR 1".

- PACK JOINT ASSEMBLY JONES E-2606 OR APPROVED EQUAL

POLYETHYLENE) WITH #12

RED-WHITE GATE VALVE #206 OR APPROVED ----

ALL BOX COVERS SHALL BE SET TO GRADE AND SHALL NOT BE SITUATED IN DRIVEWAYS OR

CURB STOP SHALL VARY BETWEEN 6" TO 10" FROM BOTTOM OF LID. WHERE CURBS ARE

IDENTIFIED AS 8", CURB STOPS SHALL VARY BETWEEN 8" TO 12" FROM BOTTOM OF LID.

5. PLACE A #12 TRACER WIRE IN THE SERVICE TRENCH TO MAKE CONDUCTIVE CONTACT WITH

THE METER BOX SHALL BE CHRISTY B-36 AND LID SHALL BE CHRISTY FL36D.

4. A "W", 3" HIGH, SHALL BE STAMPED ON THE CURB FACE OVER SERVICE LINES.

EQUAL PER STANDARD SPECIFICATIONS. IF SERVICE HAS A BACKFLOW DEVICE, LOCATE VALVE PER CITY

-SWING JOINT ASSEMBLY

6" CRUSHED ROCK

3. THE METER BOX SHALL BE CHRISTY B-16 AND LID SHALL BE CHRISTY FL16D.

