
CITY OF TURLOCK

CAPITAL PROJECT No. 22-001 CITYWIDE STREET RECONSTRUCTION AND IMPROVEMENT PROJECT PACKAGE 3 FOSBERG ROAD

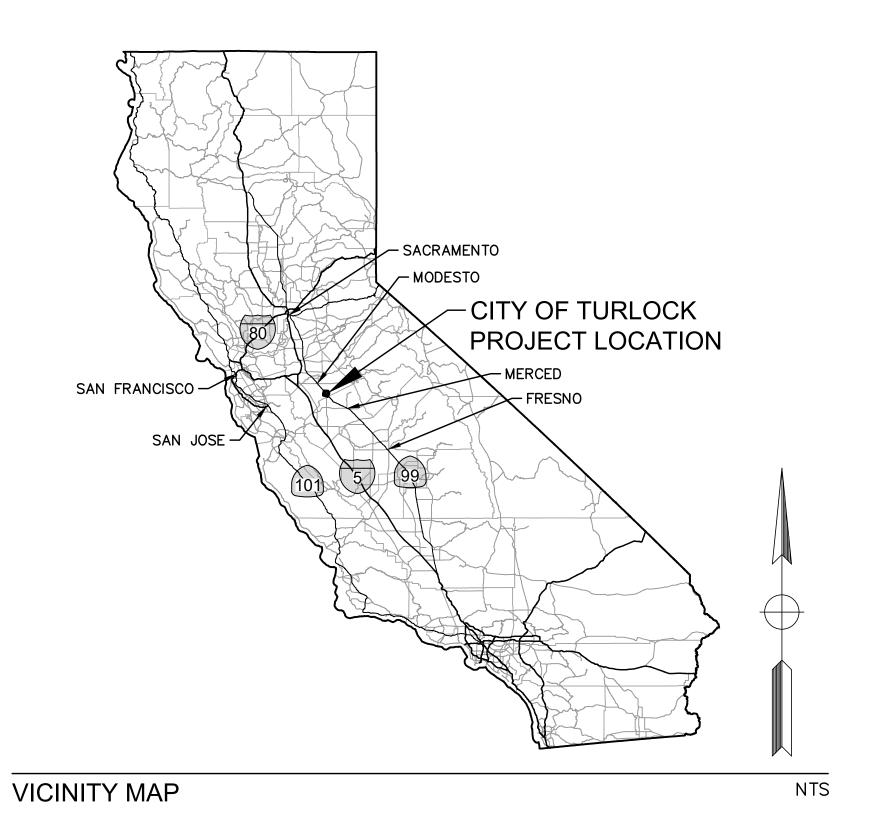

CONTACTS

CITY OF TURLOCK PUBLIC WORKS DEPARTMENT (209) 668-5520, engineering@turlock.ca.us

CITY OF TURLOCK ELECTRICAL

(209) 678-5823 DOYLE PERRY, dperry@turlock.ca.us

CITY OF TURLOCK STORM AND SEWER

(209) 345-2169 CARLOS GUERRERO, cquerrero@turlock.ca.us

CITY OF TURLOCK WATER (209) 740-3868 ORLANDO GUITERREZ, ogutierrez@turlock.ca.us

TURLOCK IRRIGATION DISTRICT (ELECTRICAL)

(209) 605-0945 DAVID PORATH, dnporath@tid.org

TURLOCK IRRIGATION DISTRICT (IRRIGATION)

(209) 535-1882 TODD TROGLIN, trtroglin@tid.org

CHARTER COMMUNICATIONS (209) 633-3303 ABRAHAM ZAMORA, abraham.zamora@charter.com

PACIFIC GAS & ELECTRIC (GAS)

(209) 470-0697 DAVID LOOMIS, d1lo@pge.com

<u>AT&T</u>

(209) 549-5847 SHARON DINNELL, sd1568@att.com

FIRE DEPARTMENT (NON-EMERGENCY)

(209) 668 - 5580

POLICE DEPARTMENT (NON-EMERGENCY)

 $(209) 668 - 1\overline{200}$

<u>AMBULANCE</u> (209) 632 - 2271

TURLOCK SCAVENGER

(209) 668 - 7274



CIVIL IMPROVEMENT LIMITS

THE CITY OF TURLOCK'S FOSBERG ROAD REHABILITATION AND IMPROVEMENT PROJECT WILL IMPROVE THE EXISTING ROADWAY FROM E MONTE VISTA AVE TO E CHRISTOFFERSEN PKWY IN THE CITY OF TURLOCK, CALIFORNIA.

GOVERNING CODES AND ADOPTED STANDARDS

ALL MATERIALS, WORKMANSHIP, AND CONSTRUCTION SHALL BE DONE IN ACCORDANCE WITH THE REQUIREMENTS OF THE CURRENT CITY OF TURLOCK STANDARD SPECIFICATIONS AND DRAWINGS; THE LATEST EDITION OF THE AMERICANS WITH DISABILITIES ACT AND THE LATEST EDITION OF THE STATE OF CALIFORNIA, DEPARTMENT OF TRANSPORTATION, STANDARD SPECIFICATIONS. CITY OF TURLOCK STANDARD DRAWINGS ARE AVAILABLE AT THE OFFICE OF THE CITY ENGINEER.

SHEET INDEX

SHEET	DRAWING	TITLE_
SHEET		
1	C-01	COVER SHEET
2	GN-01	NOTES SHEET
3	PC-01	SURVEY BENCHMARKS AND CONTROL POINTS
4	X-01	TYPICAL CROSS SECTIONS
5	K-01	KEY MAP
6-9	L-01 - L-04	PLAN AND PROFILE
10	U-01	UTILITY PLAN
11-12	DU-01 - DU-02	DRAINAGE PLAN
13	DU-03	DRAINAGE DETAILS
14-15	TC-01 - TC-02	TRAFFIC CONTROL
16-17	TD-01 - TD-02	TRAFFIC DETOUR
18-19	SS-01 - SS-02	SIGNING AND STRIPING PLAN
20-24	CD-01 - CD-05	CONSTRUCTION DETAILS
25-28	CD-06 - CD-09	CONSTRUCTION DETAILS - INTERSECTION
29	Q-01	SUMMARY OF QUANTITIES

CITY OF TURLOCK APPROVAL

NANDA K. GOTTIPARTHY. P.E. DATE CONTRACT CITY ENGINEER

DRAWN BY: R. LIM

3/6/2023

DRAWING No.



NOTE: ALL REFERENCES AND WRITTEN DIMENSIONS SHALL SUPERCEDE ALL SCALED DISTANCES AND SHALL BE VERIFIED IN THE FIELD. ANY DISCREPANCY SHALL BE BROUGHT TO THE ATTENTION OF THE ENGINEER PRIOR TO THE COMMENCEMENT


Maman & Arrain SULAIMAN ARAIN P.E. LICENSE No. C78364

PLANS APPROVAL DATE

★Exp. 9/30/2023

Michael Baker 500 YGNACIO VALLEY RD SUITE 300 WALNUT CREEK, CA 94596

(925) 906-1460

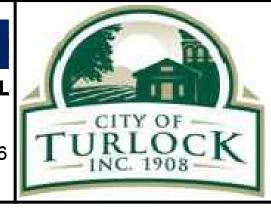

CITY OF TURLOCK PUBLIC WORKS DEPARTMENT **ENGINEERING DIVISION** 156 S. BROADWAY. SUITE 150 (209) 668 - 5520

COVER SHEET

CAPITAL PROJECT No. 22-001 CITYWIDE STREET RECONSTRUCTION AND IMPROVEMENT PROJECT

VERIFY	SC	ALE
BAR IS		
ORIGINAL 1/4"		
0	Í	
1/. IF NOT 0		INC

ON THIS SHEET, ADJUST SCALES ACCORDINGLY

REV. BY: C-01 CH. BY: S. ARAIN 08/29/2022 AS SHOWN SCALE: OF 29

GENERAL NOTES:

- 1. THE CONTRACTOR AGREES TO ASSUME SOLE AND COMPLETE RESPONSIBILITY FOR JOB SITE CONDITIONS DURING THE COURSE OF CONSTRUCTION OF THIS PROJECT, INCLUDING SAFETY OF ALL PERSONS AND PROPERTY; THAT THIS REQUIREMENT SHALL APPLY CONTINUOUSLY AND NOT BE LIMITED TO NORMAL WORKING HOURS; AND THAT THE CONTRACTOR SHALL DEFEND, INDEMNIFY AND HOLD THE OWNER, THE ENGINEER AND THE CITY HARMLESS FROM ANY AND ALL LIABILITY, REAL OR ALLEGED, IN CONNECTION WITH THE PERFORMANCE OF WORK ON THIS PROJECT, EXCEPTING FOR LIABILITY ARISING FROM THE SOLE NEGLIGENCE OF THE OWNER OR THE ENGINEER.
- 2. UNLESS OTHERWISE STATED, ALL STATIONS INDICATED ON THE IMPROVEMENT PLANS ARE REFERENCED TO THE CENTER LINE OF THE STREET. ALL STATIONS ON THE CURBS ARE PERPENDICULAR TO OR RADIALLY OPPOSITE CENTER LINE STATIONS, UNLESS OTHERWISE NOTED.
- 3. IT IS THE CONTRACTOR'S RESPONSIBILITY TO VERIFY THE LOCATION OF ALL EXISTING FACILITIES.
- 4. THE CONTRACTOR SHALL PROVIDE ALL LIGHTS, SIGNS, BARRICADES, FLAGMEN OR OTHER DEVICES NECESSARY TO PROVIDE FOR PUBLIC SAFETY IN ACCORDANCE WITH THE CURRENT EDITION OF STATE OF CALIFORNIA, DEPARTMENT OF TRANSPORTATION, MANUAL ON UNIFORM TRAFFIC CONTROL DEVICES.
- 5. ALL MATERIALS, WORKMANSHIP, AND CONSTRUCTION SHALL BE DONE IN ACCORDANCE WITH THE REQUIREMENTS OF THE CURRENT CITY OF TURLOCK STANDARD SPECIFICATIONS AND DRAWINGS: AND THE LATEST EDITION OF THE STATE OF CALIFORNIA, DEPARTMENT OF TRANSPORTATION, STANDARD SPECIFICATIONS. CITY OF TURLOCK STANDARD DRAWINGS ARE AVAILABLE AT THE OFFICE OF THE PUBLIC WORKS DEPARTMENT.
- CONSTRUCTION STAKING AND SURVEY IS THE RESPONSIBILITY OF THE CONTRACTOR. CONSTRUCTION STAKING SHALL BE PERFORMED BY A REGISTERED SURVEYOR OR ENGINEER RETAINED AND PAID FOR BY THE CONTRACTOR. THE SURVEYOR OR ENGINEER SHALL CERTIFY ON THE FINAL CONSTRUCTION DRAWING THAT THE STAKING WAS PERFORMED ACCORDING TO THE APPROVED PLANS.
- 7. TO SCHEDULE AN INSPECTION, THE CONTRACTOR SHALL CALL MANUEL QUINTERO (209)668-5484, AT LEAST 24-HOURS PRIOR TO THE REQUIRED INSPECTION. THE CITY PUBLIC WORKS DEPARTMENT WILL MAKE EVERY EFFORT TO PERFORM THE INSPECTION WITHIN THE NEXT BUSINESS DAY.
- 8. THE CITY OF TURLOCK OR ASSOCIATED UTILITY COMPANY AND RESIDENCES TO BE AFFECTED SHALL BE NOTIFIED IMMEDIATELY UPON ANY UTILITY SERVICE DISRUPTION AND A 48 HOUR NOTICE SHALL BE GIVEN FOR ANY PLANNED DISRUPTION.
- 9. DUST SHALL BE CONTROLLED BY THE CONTRACTOR AT ALL TIMES, INCLUDING HOLIDAYS AND WEEKENDS, PER SECTION 10 OF THE 2018 STATE OF CALIFORNIA, DEPARTMENT OF TRANSPORTATION, STANDARD SPECIFICATIONS AND THE CITY OF TURLOCK STANDARD SPECIFICATIONS. WATER USED FOR DUST CONTROL AND COMPACTION MAY BE PURCHASED FROM THE APPROPRIATE AGENCY PRIOR TO THE START OF ANY WORK, AND ANY FEES OR DEPOSITS ARE THE RESPONSIBILITY OF THE CONTRACTOR. IT IS ALSO THE CONTRACTOR'S RESPONSIBILITY TO MAINTAIN CLEANLINESS OF THE EXISTING IMPROVED STREETS IN THE CONSTRUCTION AREA.
- 10. THE CONTRACTOR IS REQUIRED TO MAINTAIN PUBLIC SAFETY AT ALL TIMES. ANY OPERATION OR SITUATION THAT THREATENS THE SAFETY OF THE WORKERS OR PUBLIC. INCLUDING IMPROPER TRAFFIC CONTROL, WILL CAUSE THE SUSPENSION OF WORK UNTIL CORRECTIONS ARE MADE AND NO ADJUSTMENTS TO WORKING DAYS WILL BE GRANTED.
- 11. IT IS THE CONTRACTOR'S RESPONSIBILITY TO MAINTAIN A CLEAN AND SAFE WORKSITE AT ALL TIMES. IF THE CONTRACTOR FAILS TO MAINTAIN A CLEAN WORKSITE, THE CITY MAY ORDER STREET SWEEPING OR ORDER CORRECTIVE ACTION AT COST TO THE CONTRACTOR.
- 12. MATERIALS TESTING IS THE RESPONSIBILITY OF THE CONTRACTOR AND SHALL BE COORDINATED WITH THE ENGINEER.
- 13. STANDARD DRAWING NUMBERS SHOWN ON THE PLANS REFER TO DRAWINGS CONTAINED IN THE CITY OF TURLOCK STANDARD SPECIFICATIONS AND DRAWINGS, SHOWN THUS; (I. E. STD C-1)
- 14. THE CONTRACTOR SHALL SECURE A TRENCH PERMIT FROM THE CALIFORNIA DEPARTMENT OF INDUSTRIAL RELATIONS. DIVISION OF OCCUPATIONAL SAFETY AND HEALTH PRIOR TO THE EXCAVATION OF ANY TRENCH OVER FIVE FEET IN DEPTH. UTILITY TRENCHING SHALL BE PERFORMED IN ACCORDANCE WITH THE TRENCHING AND COMPACTION REQUIREMENTS OF THE CITY OF TURLOCK STANDARD SPECIFICATIONS AND DRAWINGS. REFER TO STD T-1. T-2. AND T-3.
- 15. THE CONTRACTOR SHALL VERIFY LOCATIONS OF ALL EXISTING UNDERGROUND UTILITIES AND SHALL CONTACT THE RESPECTIVE UTILITY COMPANIES PRIOR TO COMMENCEMENT OF WORK. THE CONTRACTOR SHALL BE RESPONSIBLE FOR THE LOCATION AND PRESERVATION OF ALL SUCH FACILITIES IN THE AREA OF CONSTRUCTION AND SHALL NOTIFY UNDERGROUND SERVICE ALERT OF NORTHERN CALIFORNIA FORTY-EIGHT (48) HOURS IN ADVANCE OF ANY CONSTRUCTION.
- 16. THE CONTRACTOR SHALL BE RESPONSIBLE FOR COORDINATION OF THE REMOVAL OR RELOCATIONS OF ALL EXISTING UTILITIES WITH RESPECTIVE UTILITY COMPANIES.
- 17. MANHOLE CASTINGS AND COVERS SHALL BE ADJUSTED TO FINAL GRADES BY THE CONTRACTOR AFTER STREET IMPROVEMENTS ARE COMPLETED. ALL EXISTING MANHOLE LIDS WITHIN LIMITS OF STREET IMPROVEMENT SHALL BE MARKED AND TIED TO SURVEY PRIOR TO ADJUSTMENT.
- 18. FOR ALL WORK PERFORMED WITHIN PUBLIC RIGHT-OF-WAYS, THE CONTRACTOR SHALL OBTAIN AN ENCROACHMENT PERMIT. PRESERVE THE INTEGRITY AND LOCATION OF ANY AND ALL PUBLIC UTILITIES. AND PROVIDE NECESSARY CONSTRUCTION TRAFFIC CONTROL FOR STREET IMPROVEMENTS. THE CONTRACTOR SHALL. THROUGH THE ENCROACHMENT PERMIT PROCESS. VERIFY THE NEED FOR ANY DETOUR PLAN WITH THE CITY OF TURLOCK. IF A PLAN IS REQUIRED. CONTRACTOR SHALL PROVIDE PLAN AND RECEIVE APPROVAL PRIOR TO CONSTRUCTION.
- 19. THE CONTRACTOR SHALL OBTAIN ALL PERMITS AND LICENSES REQUIRED FOR THE CONSTRUCTION AND COMPLETION OF THE PROJECT.
- 20. THE CONTRACTOR SHALL COMPLY WITH BUSINESS AND PROFESSIONS CODE SECTION 8771(b) REGARDING REFERENCING, PRESERVING, AND RECONSTRUCTING MONUMENTS. PRESERVATION OF EXISTING MONUMENTS SHALL BE THE RESPONSIBILITY OF THE CONTRACTOR. THE CONTRACTOR SHALL NOTIFY THE ENGINEER OF ALL MONUMENTS THAT ARE DISTURBED BY CONSTRUCTION OPERATIONS. THE ENGINEER WILL TIE OFF SAID MONUMENTS AND PROVIDE THE CONTRACTOR NOTICE TO PROCEED.

- 21. PRIOR TO COMMENCING ANY WORK, IT SHALL BE THE CONTRACTOR'S RESPONSIBILITY TO ENSURE THAT ALL CURRENT STANDARDS FOR THE CITY OF TURLOCK ARE FOLLOWED AS WELL AS TO HAVE EACH UTILITY COMPANY LOCATE, IN THE FIELD, THEIR MAIN AND SERVICE LINES. THE CONTRACTOR SHALL NOTIFY MEMBERS OF THE UNDERGROUND SERVICE ALERT (USA) 48 HOURS IN ADVANCE OF PERFORMING ANY EXCAVATION WORK BY CALLING THE TOLL FREE NUMBER (800) 642-2444. THE CONTRACTOR SHALL RECORD THE U.S.A. ORDER NUMBER AND FURNISH ORDER NUMBER TO OWNER PRIOR TO ANY EXCAVATION. IT SHALL BE THE CONTRACTOR'S SOLE RESPONSIBILITY TO POSITIVELY LOCATE (POTHOLE) AND PROTECT ALL EXISTING UTILITIES THAT MAY CONFLICT WITH ANY WORK ASSOCIATED WITH THIS CONTRACT SO THAT NO DAMAGE RESULTS TO THEM DURING THE PERFORMANCE OF THIS CONTRACT. ANY NECESSARY REPAIRS TO DAMAGED UTILITIES SHALL BE PAID FOR BY THE CONTRACTOR. THE CONTRACTOR SHALL BE REQUIRED TO COOPERATE WITH OTHER CONTRACTORS AND UTILITY COMPANIES INSTALLING NEW STRUCTURES, UTILITIES AND SERVICE TO THE DEVELOPMENT.
- 22. THE CONTRACTOR SHALL REACH OUT TO AFFECTED RESIDENTS PRIOR TO CONSTRUCTION TO INFORM THEM OF THE RELOCATION OF ANY FENCE OR
- 23. THE CONTRACTOR SHALL RESTORE ALL EXISTING LANDSCAPING AND/OR IRRIGATION DISTURBED DURING CONSTRUCTION ACTIVITIES AND REPLACE LANDSCAPING WITH SOD WHERE GRASS IS DISTURBED. THE CONTRACTOR SHALL RELOCATE SPRINKLERS AS NECESSARY SO AS TO WATER OWNER'S LANDSCAPING, BUT NOT NEW CONCRETE SURFACES, TYPICAL OF ALL LOCATIONS WHERE GRASS OR BUSHES HAVE BEEN PLANTED BY OWNERS. THE CONTRACTOR SHALL BE RESPONSIBLE FOR MAINTAINING IRRIGATION IN THE CASE OF ANY INTERRUPTION OF SERVICE, INCLUDING DURING HOLIDAYS AND WEEKENDS. ANY DEAD LANDSCAPING DUE TO CONSTRUCTION ACTIVITIES OR INTERRUPTION OF IRRIGATION SERVICE SHALL BE REPLACED IN KIND BY THE CONTRACTOR AT NO ADDITIONAL COST.
- 24. THE CONTRACTOR SHALL RE-PAINT IN KIND ALL EXISTING PAINTED CURB WITHIN LIMITS OF PROJECT. THIS INCLUDES BUT IS NOT LIMITED TO RED CURB, WHITE CURB
- 25. THE CONTRACTOR SHALL BE RESPONSIBLE FOR PROTECTING TREES, SHRUBS AND OTHER PLANTS THAT ARE NOT TO BE REMOVED. OVERHEAD UTILITY POLES/LINES, FENCES, SIGNS, MARKERS AND MONUMENTS, BUILDINGS AND STRUCTURES, CONDUITS, PIPELINES UNDER OR ABOVE GROUND, SEWER AND WATER LINES, SPRINKLER SYSTEMS ABOVE OR BELOW GROUND, ALL ROADWAY FACILITIES, AND ANY OTHER IMPROVEMENTS OR FACILITIES WITHIN OR ADJACENT TO THE RIGHT-OF-WAY SHALL BE PROTECTED BY THE CONTRACTOR FROM INJURY OR DAMAGE. IF ORDERED BY ENGINEER, THE CONTRACTOR SHALL PROVIDE AND INSTALL SUITABLE SAFEGUARDS, APPROVED BY ENGINEER, TO PROTECT SUCH OBJECTS FROM INJURY OR DAMAGE.
- 26. THE CONTRACTOR SHALL COMPLETE ALL REQUIRED EARTHWORK, GRADING, AND INITIAL PAVING (FIRST LIFT) WITHIN EIGHT (8) CALENDAR DAYS AFTER PAVEMENT REMOVAL. THE CONTRACTOR IS NOT ALLOWED TO DEMO ALL OF THE PEDESTRIAN CURB RAMPS AT THE SAME TIME. THE CONTRACTOR SHALL SCHEDULE THE CURB RAMP REPLACEMENT WORK TO PROVIDE PEDESTRIAN ACCESS AT ALL TIMES.

CLEARING NOTES:

1. THE CONTRACTOR IS RESPONSIBLE FOR CLEARING AND GRUBBING, PRUNING AND REMOVING TREE ROOTS THAT INTERFERE WITH THE WORK. THE CONTRACTOR SHALL BE RESPONSIBLE FOR ENSURING THAT NO TREE ROOTS ARE PRUNED OR CUT THAT COULD COMPROMISE THE STABILITY OF THE TREE. THE CONTRACTOR SHALL RETAIN AN ARBORIST, AT THEIR OWN EXPENSE PRIOR TO BEGINNING THE WORK. THE CONTRACTOR'S ARBORIST SHALL PROVIDE A WORK PLAN THAT DESCRIBES THE METHOD OF PRUNING AND REMOVING MINOR TREE ROOTS THAT MAY BE ENCOUNTERED DURING CONSTRUCTION. THE ARBORIST WILL PROVIDE RECOMMENDATIONS FOR REVIEW BY THE CITY.

DUST CONTROL NOTES:

- SPRAY WATER ON ALL EXPOSED EARTH SURFACED DURING CLEARING, GRADING, EARTH MOVING AND OTHER SITE PREPARATION ACTIVITIES THROUGHOUT THE DAY TO MINIMIZE DUST. USE TARPAULINS OR OTHER EFFECTIVE COVERS ON ALL STOCKPILED EARTH MATERIAL AND ON ALL HAUL TRUCKS TO MINIMIZE DUST. SWEEP THE ADJACENT STREET FRONTAGES AT LEAST ONCE A DAY OR AS NEEDED TO REMOVE SILT AND OTHER DIRT WHICH IS EVIDENT FROM CONSTRUCTION ACTIVITIES. ENSURE THAT CONSTRUCTION VEHICLES ARE CLEANED PRIOR TO LEAVING THE SITE TO PREVENT DUST AND DIRT FROM BEING TRACKED OFF SITE.
- 2. ALL EXPOSED SURFACES SHALL BE WATERED A MINIMUM OF TWICE DAILY INCLUDING ON HOLIDAYS AND WEEKENDS, UNLESS DEEMED UNNECESSARY DUE TO WEATHER. WATER SHALL BE APPLIED AS PROVIDED IN SECTION 17 OF 2018 CALTRANS STANDARD SPECIFICATIONS.
- 3. DUST PALLIATIVES MAY BE SUBSTITUTED FOR WATERING UPON THE APPROVAL OF THE ENGINEER. DUST PALLIATIVES SHALL BE APPLIED AS PROVIDED IN SECTION 18 OF 2018 CALTRANS STANDARD SPECIFICATIONS.

STORM WATER POLLUTION PREVENTION:

1. PRIOR TO COMMENCING CONSTRUCTION, THE CONTRACTOR SHALL SUBMIT TO THE ENGINEER A COMPLETED STORM WATER POLLUTION PREVENTION PLAN (SWPPP) SIGNED AND CERTIFIED BY A QUALIFIED SSWPP DEVELOPER (QSD). ONCE APPROVED, CONTRACTOR SHALL SUBMIT SWPPP AND NOTICE OF INTENT (NOI) WITH THE CALIFORNIA DEPARTMENT OF WATER QUALITY CONTROL BOARD. THE CONTRACTOR SHALL ADHERE TO THE SWPPP AT ALL TIMES. THE CONTRACTOR SHALL FILE THE ANNUAL REPORT WHEN THE PROJECT IS COMPLETED.

CALTRANS STANDARD PLAN 2018:

	A3A A3B A3C A20A	ABBREVIATIONS (SHEET 1 OF 3) ABBREVIATIONS (SHEET 2 OF 3) ABBREVIATIONS (SHEET 3 OF 3) PAVEMENT MARKERS AND TRAFFIC LINES TYPICAL DETAILS
RSP	A20B	PAVEMENT MARKERS AND TRAFFIC LINES TYPICAL DETAILS
RSP	A20C	PAVEMENT MARKERS AND TRAFFIC LINES TYPICAL DETAILS
RSP	A20D	PAVEMENT MARKERS AND TRAFFIC LINES TYPICAL DETAILS
	A24A	PAVEMENT MARKINGS ARROWS
	A24B	PAVEMENT MARKINGS ARROWS AND SYMBOLS
	A24C	PAVEMENT MARKINGS SYMBOLS AND NUMERALS
	A24D	PAVEMENT MARKINGS WORDS
RSP	A24E	PAVEMENT MARKINGS WORDS
	A24F	PAVEMENT MARKINGS CROSSWALKS
RSP	A24G	PAVEMENT MARKINGS YIELD LINES, LIMIT LINES, AND WRONG WAY DETAILS


PAVEMENT REPORTS:

CRAWFORD & ASSOCIATES, INC.

9/26/2022 FINAL

PAVEMENT DATA REPORT CITY OF TURLOCK - 2022 ROAD REPAIR LIST PROJECT TURLOCK, STANISLAUS COUNTY, CA

LEGEND AND SYMBOLS:

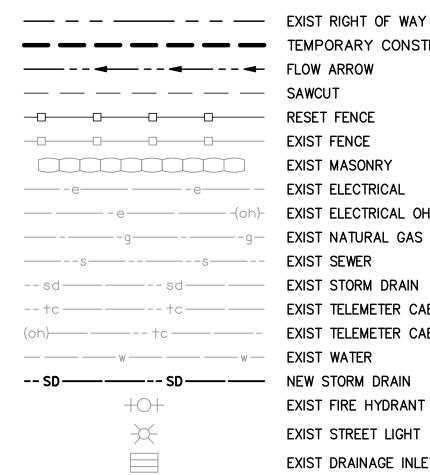

TEMPORARY CONSTRUCTION EASEMENT

EXIST MASONRY EXIST ELECTRICAL EXIST NATURAL GAS EXIST SEWER EXIST STORM DRAIN EXIST TELEMETER CABLE EXIST TELEMETER CABLE OH

EXIST FIRE HYDRANT EXIST STREET LIGHT EXIST DRAINAGE INLET

EXIST MANHOLE EXIST POLE **EXIST SIGN EXIST TRAFFIC SIGNAL EXIST TREE**

> **NEW DRAINAGE INLET** NEW STORM DRAIN MANHOLE **NEW STREET LIGHT**

REMOVE CONCRETE PROPOSED CONCRETE/SIDEWALK

DETAIL NUMBER/SHEET NUMBER

PROPOSED CURB AND GUTTER PROPOSED DETECTABLE WARNING SURFACE

AC REPLACEMENT

Δ· · · Δ Δ·· ·

XX

EXIST ELEVATION (XXX.XX) EXIST MONUMENT LOCATIONS

MANUAL ON UNIFORM TRAFFIC CONTROL DEVICES:

1. ALL SIGN PANELING SHALL CONFORM TO THE CALIFORNIA MANUAL ON UNIFORM TRAFFIC CONTROL DEVICES, 2014 EDITION REVISION 6, DATED MARCH 20 2021.

ABBREVIATIONS:

AGGREGATE BASE

ASPHALT CONCRETE

AB

APPROX APPROXIMATE AVE AVENUE **BEGIN CURVE** BEG BEGIN BLVD BOULEVARD CENTERLINE CURB AND GUTTER CB CATCH BASIN DET **DETAIL** DR DRIVE DWG DRAWING DRIVEWAY END CURVE EXISTING GRADE

ELEVATION EDGE OF PAVEMENT EDGE OF TRAVELED WAY EXIST **EXISTING** FINISHED GRADE FIRE HYDRANT

FEET G/0 GRIND AND OVERLAY GAS VALVE

FLOWLINE

HORIZ **HORIZONTAL** HIGH POINT INCHES IRON PIPE IRON PIPE NO WELL

IPW IRON PIPE IN WELL **KILOVOLT** K۷ LINEAR FEET LOW POINT

LANDSCAPING LEFT MANHOLE MAG NAIL

NUMBER NTS NOT TO SCALE OG ORIGINAL GROUND **OVERHEAD**

MODIFIED

POINT OF COMPOUND CURVE POINT OF INTERSECTION PROTECT IN PLACE POWER POLE PEDESTRIAN PUSH BUTTON POINT OF REVERSE CURVE POINT or POINT OF TANGENCY

ORNAMENTAL

RED CURB REINFORCED CONCRETE PIPE RT RIGHT

R/W RIGHT OF WAY SD STORM DRAIN SHOULDER STREET LIGHT SANITARY SEWER ST STREET STA STATION STD **STANDARD** SIDEWALK

TOP OF CURB TRAFFIC SIGNAL UTILITY POLE **VARIES**

VERTICAL WATER VALVE

Before You Dig lof work.

ALL REFERENCES AND WRITTEN DIMENSIONS SHALL SUPERCEDE ALL SCALED DISTANCES AND SHALL BE VERIFIED IN THE FIELD. ANY DISCREPANCY SHALL BE BROUGHT TO THE ATTENTION OF THE ENGINEER PRIOR TO THE COMMENCEMENT

Maman & Arram


PLANS APPROVAL DATE

SULAIMAN ARAIN P.E. LICENSE No. C78364

★\Exp. 9/30/2023

Michael Baker INTERNATIONA

500 YGNACIO VALLEY RD SUITE 300 WALNUT CREEK, CA 94596 (925) 906-1460

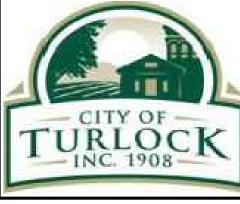

CITY OF TURLOCK PUBLIC WORKS **DEPARTMENT** ENGINEERING DIVISION 156 S. BROADWAY. SUITE 150 (209) 668 - 5520

NOTES SHEET

CAPITAL PROJECT No. 22-001 CITYWIDE STREET RECONSTRUCTION AND IMPROVEMENT PROJECT

VERIFY SCALE BAR IS 1" ON ORIGINAL DRAWING 1/4" 3/4" 0 _____1 1/2" IF NOT ONE INCH

ON THIS SHEET, ADJUST SCALES ACCORDINGLY

DRAWN BY: R. LIM DRAWING No. REV. BY: GN-01 CH. BY: S. ARAIN 08/29/2022 DATE: SHEET: SCALE: AS SHOWN 2 OF 29 MBI PROJECT No. 187020

REFERENCE DATA:

HORIZONTAL DATUM HORIZONTAL DATUM IS BASED ON THE CITY OF TURLOCK G.P.S. CONTROL NETWORK SURVEY FILED IN BOOK 20 OF SURVEYS AT PAGE 56, STANISLAUS COUNTY RECORDS. SAID SURVEY IS BASED ON THE 1983 NORTH AMERICAN DATUM AND ADJUSTMENT AS SHOWN ON THE FACE OF SAID SURVEY. POINTS K10 AND K14 AS SHOWN ON THE SURVEY WERE USED AS THE BASE CONTROL FOR THIS PROJECT.

COORDINATE SYSTEM

THE CALIFORNIA COORDINATE SYSTEM OF 1983 (CCS83), ZONE III.

<u>VERTICAL DATUM</u> CITY OF TURLOCK

PROJECT BENCHMARK - FOSBERG ROAD CITY OF TURLOCK BENCHMARK 2-2-2 BRASS PLUG ON THE SOUTHEAST CORNER OF ZEERING ROAD AT FOSBERG ROAD. ELEVATION = 108.853 FEET

SURVEY NOTES:

1. THE FIELD WORK FOR THIS SURVEY WAS CONDUCTED IN FEBRUARY 2022.


- 2. PHYSICAL ITEMS SHOWN ON THIS SURVEY ARE LIMITED TO THOSE SURFACE—VISIBLE STRUCTURES, FACILITIES, AND FEATURES OBSERVED AT THE FIELD SURVEY.
- 3. SUBSURFACE OBJECTS, IF ANY, WERE NOT LOCATED IN THIS SURVEY. NO WARRANTY IS IMPLIED AS TO THE ACCURACY OR COMPLETENESS OF ANY SUBSURFACE OBJECTS REPRESENTED BY SYMBOLS, LINES OR LABELS SHOWN HEREON. SAID SUBSURFACE OBJECTS MAY INCLUDE, BUT ARE NOT LIMITED TO, CONCRETE FOOTINGS, SLABS, SHORING, BASEMENTS, STRUCTURAL PILES, UTILITY VAULTS, PIPING, UNDERGROUND TANKS, UNDERGROUND UTILITY LINES.
- 4. NO ATTEMPT WAS MADE TO IDENTIFY THE NATURE OF USE OF UNDERLYING LAND SHOWN HEREON. ANY POTENTIAL PAST USES, INCLUDING THOSE WHICH MAY HAVE RESULTED IN SIGNIFICANT ENVIRONMENTAL OR CULTURAL IMPACTS, WERE NOT ASSESSED BY THIS SURVEY.
- 5. PRIOR TO COMMENCEMENT OF ANY CONSTRUCTION ON THIS SITE, IT IS ADVISED THAT ALL INVOLVED PARTIES REVIEW SECTION 8771 AND SECTION 8725 OF THE CALIFORNIA BUSINESS AND PROFESSIONS CODE, AND SECTION 605 OF THE CALIFORNIA PENAL CODE TO ENSURE THAT MONUMENT CONSERVATION HAS BEEN PROPERLY ADDRESSED.
- 6. NOTHING ON THIS SURVEY SHALL BE INTERPRETED IN A MANNER CONTRARY TO THE ABOVE STATEMENTS.

	CONTROL PT. NO.	NORTHING	EASTING	ELEVATION	DESCRIPTION
	1	2015300.554	6461825.108	108.48	MAG NAIL AT CROSS WALK
-	4	2013295.164	6461828.338	108.52	MAG NAIL AT STOP BAR
	5	2012738.144	6461797.305	107.09	MAG NAIL AT CROSS WALK
	K10	2002072.055	6460437.205	_	CENTER OF OPEN 2" O.D. IRON PIPE, 14" DOWN IN MONUMENT WELL, ON NOMINAL CENTER LINE INTERSECTION WEST MAIN STREET AND NORTHBOUND LANES LANDER AVENUE.
	K14	2001943.186	6471087.264		RAISED POINT IN 3" SQUARE BRASS PLATE IN CONCRETE, IN 6" P.V.C. WELL WITH WATER VALVE COVER, 50' \pm SOUTH OF NOMINAL CENTER LINE EAST AVENUE AND $1/2$ \pm MILE EAST OF NORTH QUINCY ROAD.





NOTE:
ALL REFERENCES AND WRITTEN
DIMENSIONS SHALL SUPERCEDE
ALL SCALED DISTANCES AND
SHALL BE VERIFIED IN THE
FIELD. ANY DISCREPANCY
SHALL BE BROUGHT TO THE ATTENTION OF THE ENGINEER PRIOR TO THE COMMENCEMENT

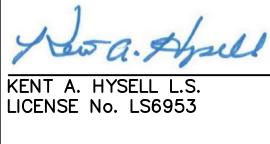


PLANS APPROVAL DATE





MODESTO, CA 95354


(209) 524-3525

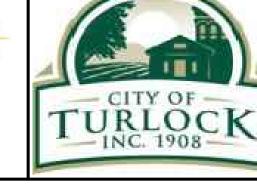

CITY OF TURLOCK PUBLIC WORKS DEPARTMENT **ENGINEERING DIVISION** 156 S. BROADWAY, SUITE 150 (209) 668-5520


SURVEY BENCHMARKS AND CONTROL POINTS

CAPITAL PROJECT No. 22-001 CITYWIDE STREET RECONSTRUCTION AND IMPROVEMENT PROJECT

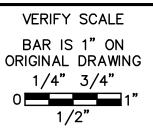


ACCORDINGLY


DRAWN BY: R. LIM DRAWING No. REV. BY: PC-01 CH. BY: K. HYSELL 08/29/2022 IF NOT ONE INCH ON THIS SHEET, ADJUST SCALES SCALE: AS SHOWN 3 OF 29

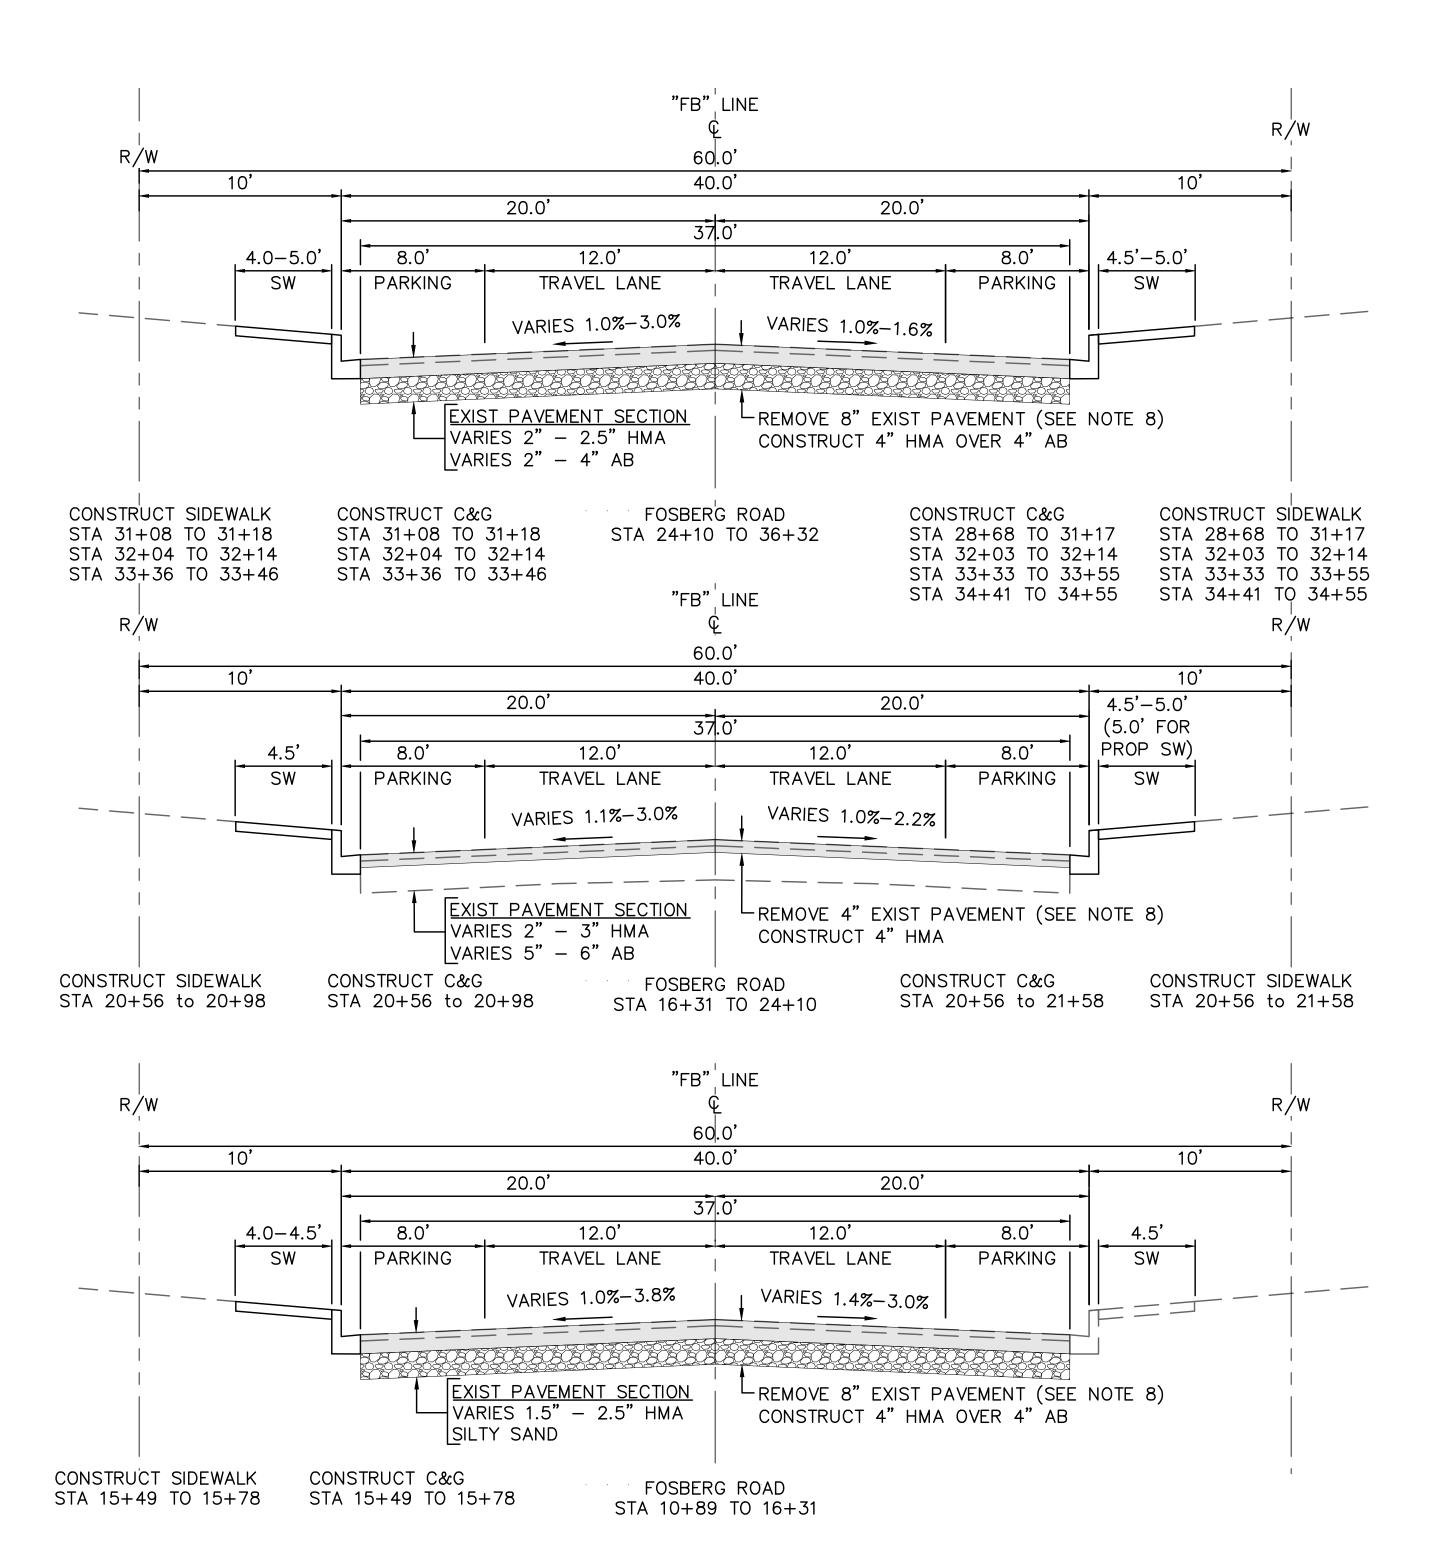

- 1. DIMENSIONS OF PAVEMENT STRUCTURAL SECTION ARE SUBJECT TO TOLERANCES SPECIFIED IN THE PLANS AND TECHNICAL SPECIFICATIONS.
- 2. FOR LOCATIONS OF PAVEMENT REHABILITATION, SEE LAYOUT SHEETS.
- 3. CONSTRUCT 6" CURB AND GUTTER PER CITY STD C-1. FOR LOCATIONS AND LIMITS OF CURB AND GUTTER REPLACEMENT, SEE LAYOUT SHEETS.
- 4. CONSTRUCT CONCRETE SIDEWALK PER CITY STD C-3. FOR LOCATIONS AND LIMITS OF SIDEWALK REPLACEMENT, SEE LAYOUT SHEETS.
- 5. PAVEMENT SHALL BE REPLACED AS SHOWN. CROSS SLOPE OF PAVEMENT SHALL MAINTAIN POSITIVE DRAINAGE. THERE SHALL BE NO LOW POINTS COLLECTING SURFACE RUNOFF.
- 6. EXISTING CURB, GUTTER, SIDEWALK, AND DRIVEWAY SHALL BE PROTECTED IN PLACE, UNLESS OTHERWISE NOTED ON THE PLANS.
- 7. DIMENSIONS SHOWN ON TYPICAL SECTIONS ARE APPROXIMATE. CONTRACTOR TO VERIFY DIMENSIONS WITH THE ENGINEER IN THE FIELD.
- 8. EXISTING PAVEMENT THICKNESS VARIES THROUGHOUT THE PROJECT. REMOVAL OF EXISTING PAVEMENT INCLUDES ASPHALT, AGGREGATE BASE, AND SUB BASE AS NECESSARY IN ORDER TO ACHIEVE TO REQUIRED REMOVAL DEPTH.
- 9. COMPACT AND PREPARE SUBGRADE PRIOR TO PLACING AGGREGATE BASE. COMPACT AND PREPARE BASE LAYER PRIOR TO PLACING HMA.
- 10. SEE PLANS FOR PROPOSED PAVEMENT TREATMENT WITHIN INTERSECTION GRADING LIMITS. WHERE APPLICABLE.

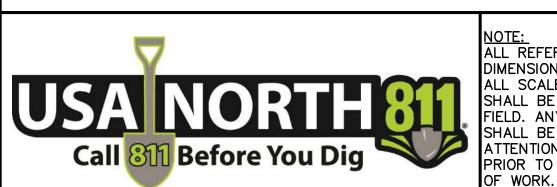

NOTE:
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DIMENSIONS SHALL SUPERCEDE
ALL SCALED DISTANCES AND
SHALL BE VERIFIED IN THE
FIELD. ANY DISCREPANCY
SHALL BE BROUGHT TO THE
ATTENTION OF THE ENGINEER
PRIOR TO THE COMMENCEMENT

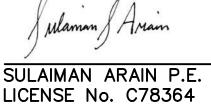


PLANS APPROVAL DATE

No. C78364


Exp. 9/30/2023

C1V1

OF CALIFORNIA

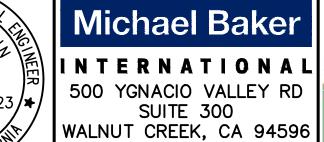

(925) 906-1460

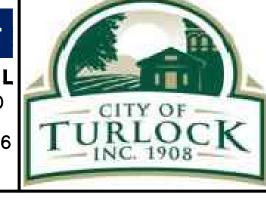

CITY OF TURLOCK
PUBLIC WORKS
DEPARTMENT
ENGINEERING DIVISION
156 S. BROADWAY,
SUITE 150
(209) 668-5520

TYPICAL SECTIONS

CAPITAL PROJECT No. 22-001 CITYWIDE STREET RECONSTRUCTION AND IMPROVEMENT PROJECT

VERIFY SCALE
BAR IS 1" ON ORIGINAL DRAWING 1/4" 3/4"
01"
1/2"
IF NOT ONE INCH

ON THIS SHEET,

ADJUST SCALES

ACCORDINGLY

DRAWN BY: A. FRONING

REV. BY:

CH. BY: S. ARAIN

DATE: 08/29/2022

CH. BY: S. ARAIN

DATE: 08/29/2022

SCALE: NOT TO SCALE


MBI PROJECT No. 187020

X-01

SHEET:
4 OF 29

DRAWING No.




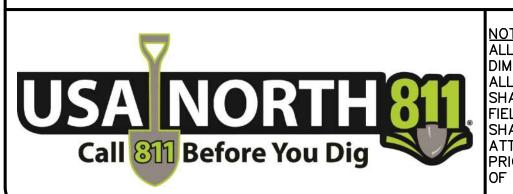


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PRIOR TO THE COMMENCEMENT
OF WORK.

Julaman & Arrain SULAIMAN ARAIN P.E. LICENSE No. C78364

PLANS APPROVAL DATE

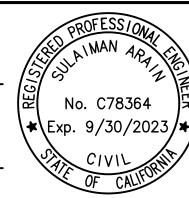

Michael Baker 500 YGNACIO VALLEY RD SUITE 300 WALNUT CREEK, CA 94596 (925) 906–1460

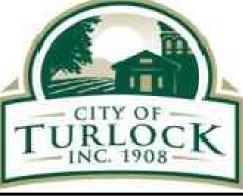

CITY OF TURLOCK
PUBLIC WORKS
DEPARTMENT
ENGINEERING DIVISION
156 S. BROADWAY,
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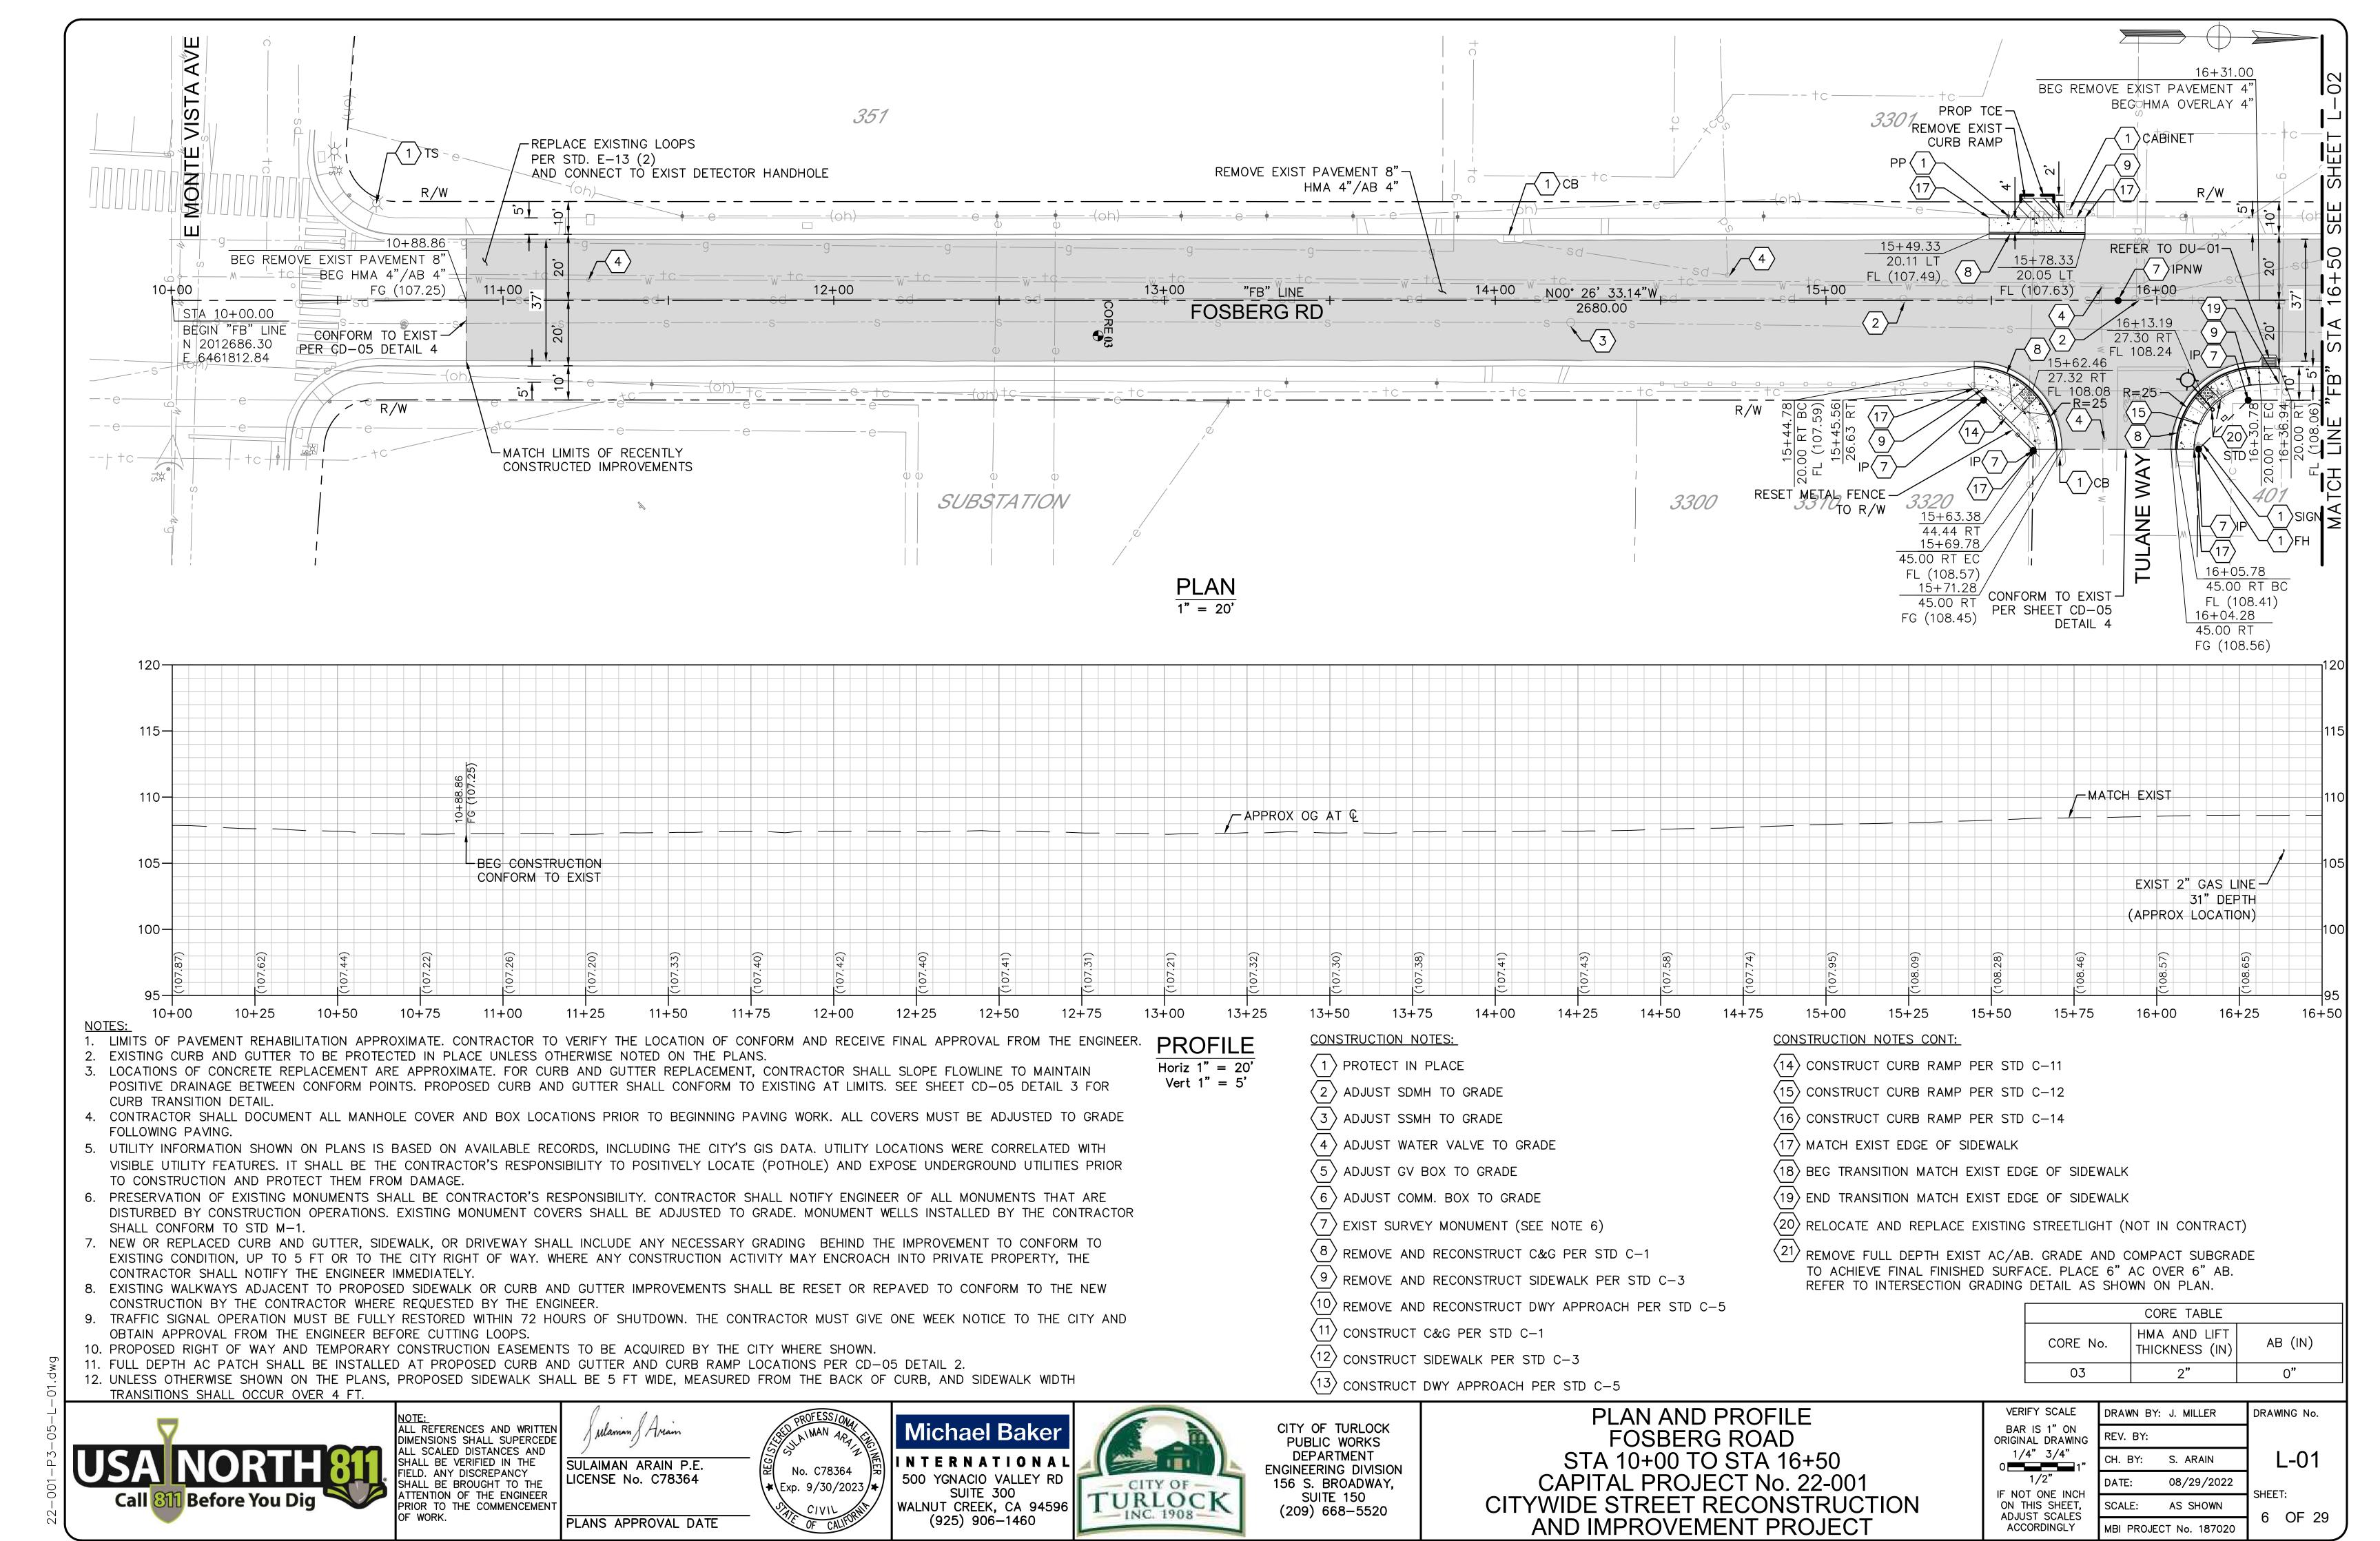
KEY MAP


CAPITAL PROJECT No. 22-001 CITYWIDE STREET RECONSTRUCTION AND IMPROVEMENT PROJECT


VERIFY SCALE
BAR IS 1" ON ORIGINAL DRAWING 1/4" 3/4"
0 1/2"
IF NOT ONE INCH ON THIS SHEET, ADJUST SCALES ACCORDINGLY


DRAWING No. DRAWN BY: R. LIM REV. BY: CH. BY: S. ARAIN 08/29/2022

K-01 AS SHOWN 5 OF 29 MBI PROJECT No. 187020



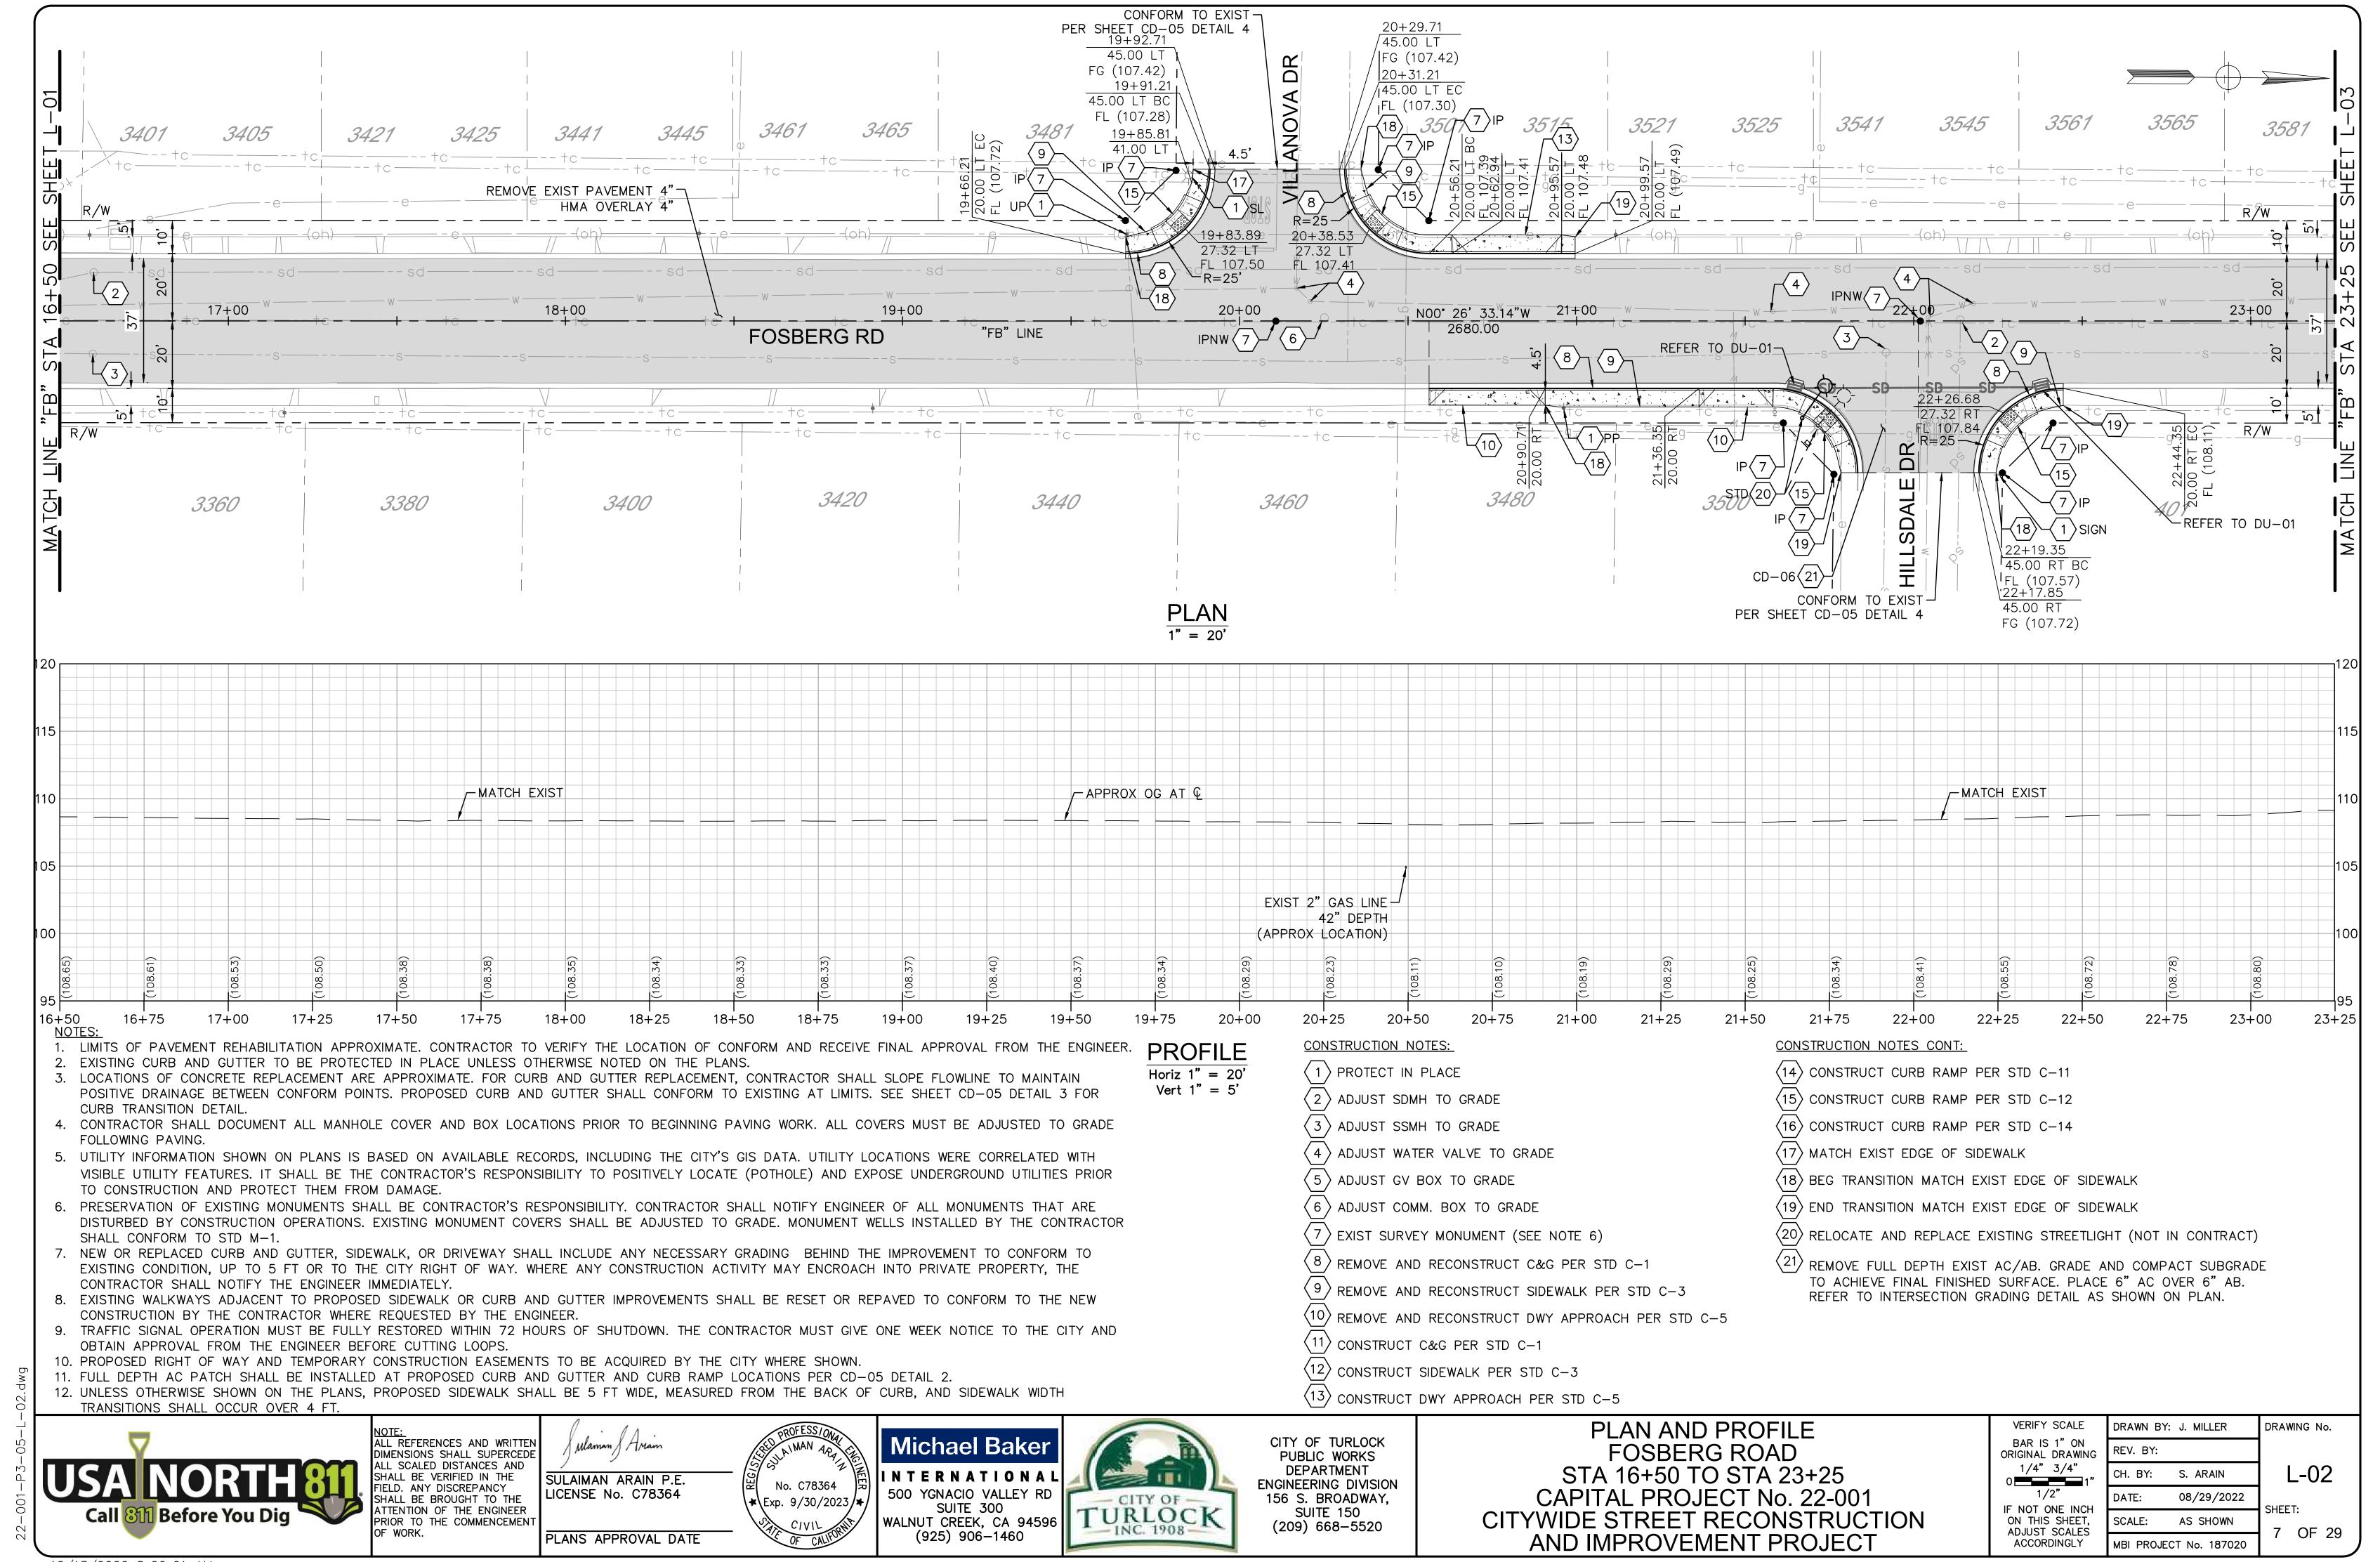

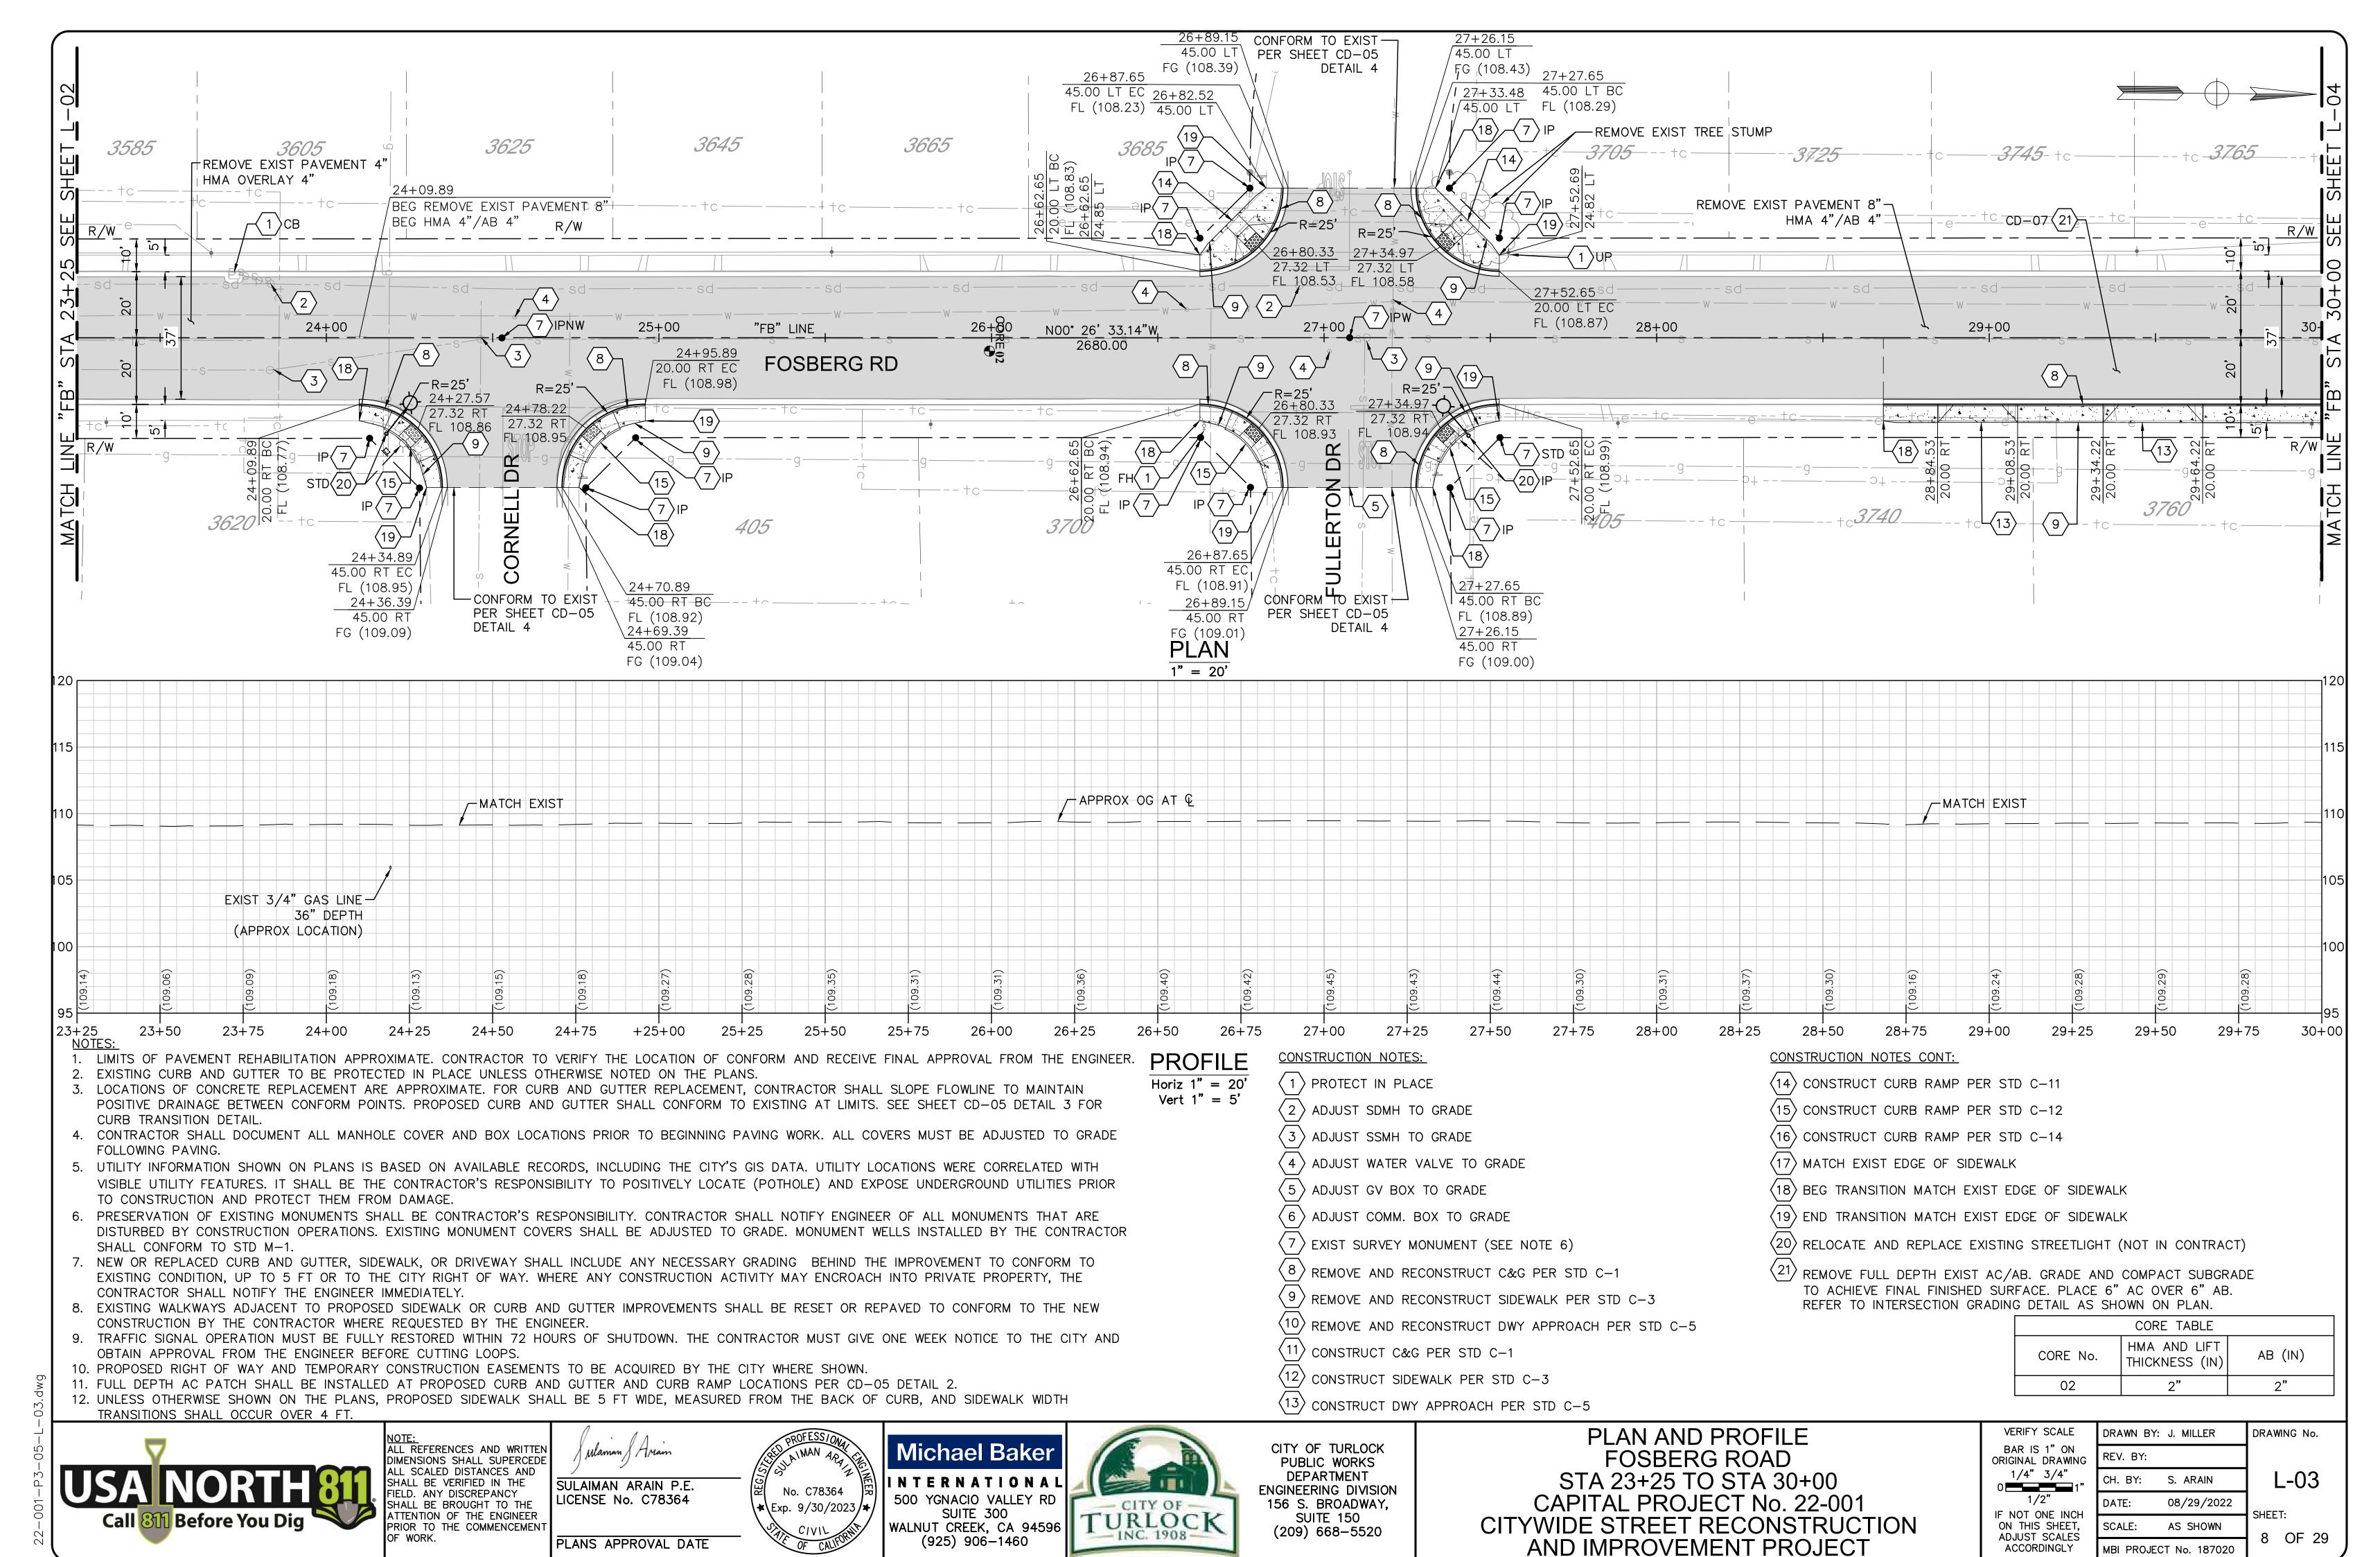

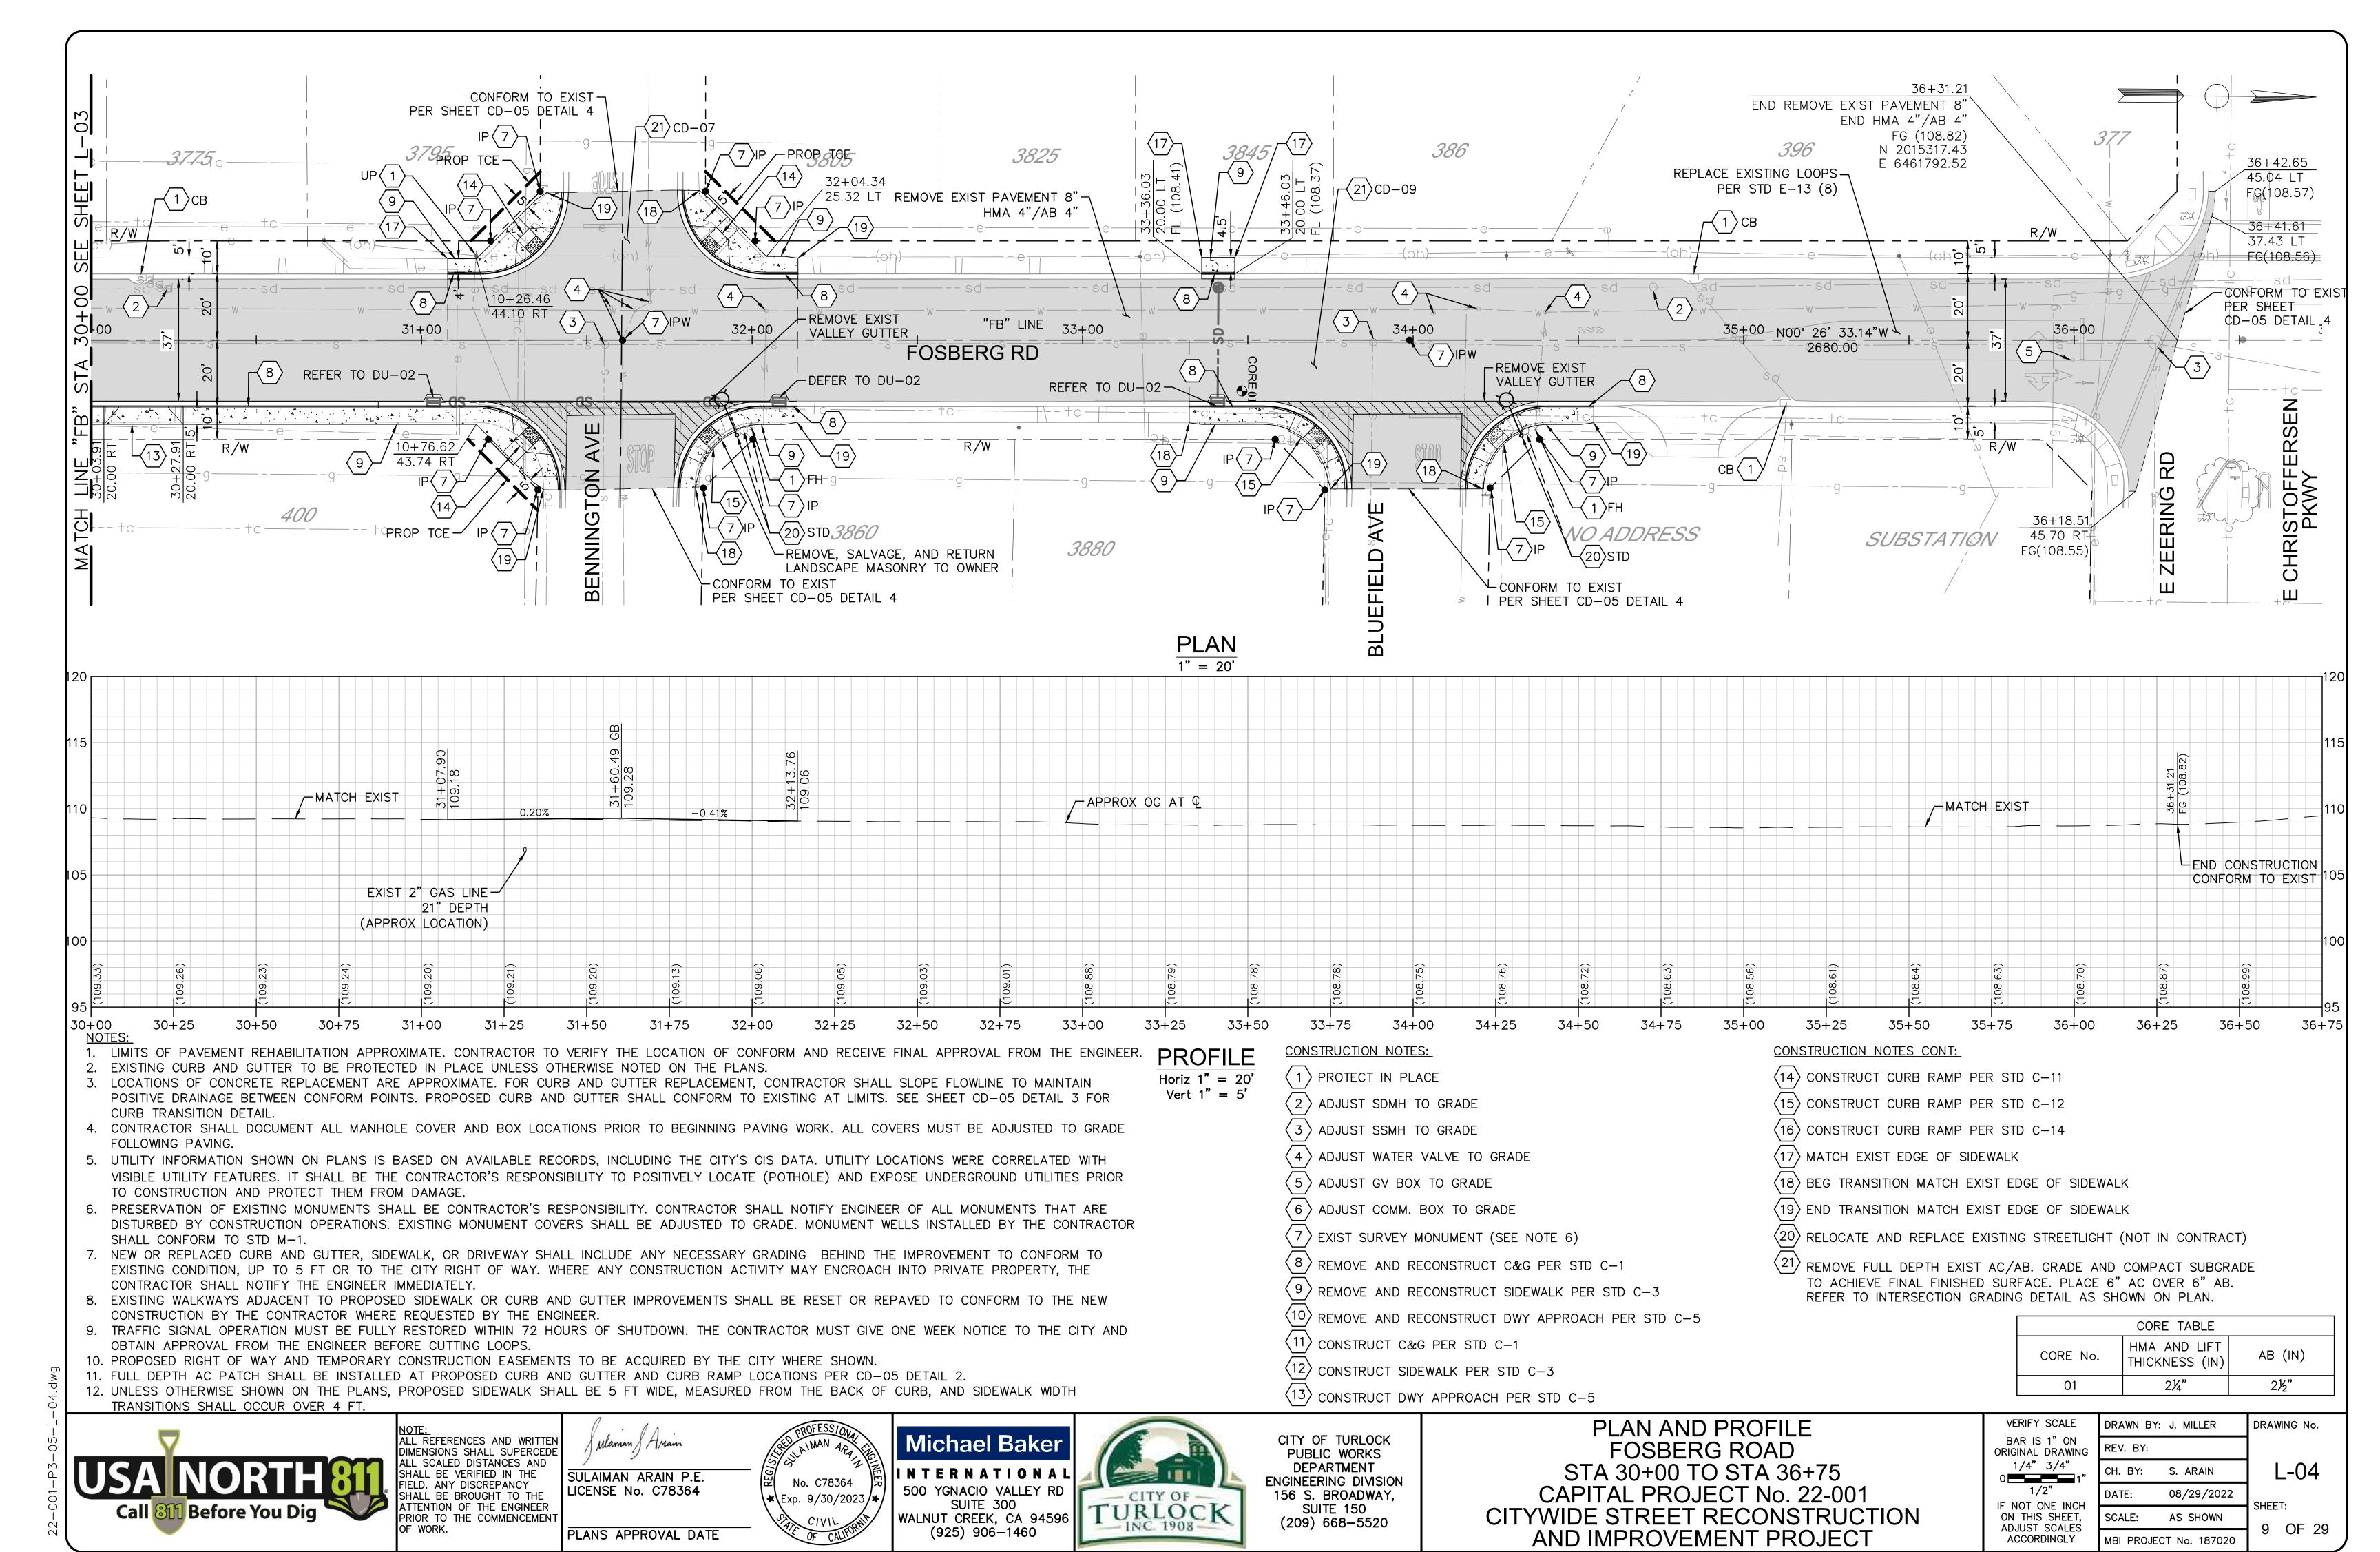

12/13/2022 8: 21: 37 AM

▼ TEST HOLE LOCATION

LEGEND:

STATED. 2. UTILITY OWNERSHIP:

NOTES:


- CITY OF TURLOCK ELECTRICAL
- CITY OF TURLOCK STORM AND SEWER
- CITY OF TURLOCK WATER
- TURLOCK IRRIGATION DISTRICT (ELECTRICAL)
- TURLOCK IRRIGATION DISTRICT (IRRIGATION)
- CHARTER COMMUNICATIONS
- PACIFIC GAS & ELECTRIC (GAS) AT&T
- SHALL BE VERIFIED BY THE CONTRACTOR PRIOR TO CONSTRUCTION.


1. DEPTHS SHOWN REFER TO THE TOP OF THE PIPE OR CONDUIT, UNLESS OTHERWISE

• LOCATIONS OF UTILITY FACILITIES SHOWN ON THESE PLANS ARE APPROXIMATE AND

POSITIVE LOCATION INFORMATION

NO.	UTILITY OWNER	DESCRIPTION	LOCATION	NORTHING	EASTING	FS ELEVATION	DEPTH	METHOD
1	PG&E	EXISTING 2" GAS	16.55' RT "FB" LINE 31+31.12	2014817.478	6461812.928	109.010	21"	POTHOLING
2	PG&E	EXISTING 2" GAS	41.26' RT "FB" LINE 31+46.59	2014833.108	6461837.551	109.063	40"	POTHOLING
3	PG&E	EXISTING 2" GAS	4.26' LT "FB" LINE 16+37.99	2013324.238	6461803.652	108.661	31"	POTHOLING
4	PG&E	EXISTING 2" GAS	2.55' LT "FB" LINE 20+49.31	2013735.556	6461802.184	108.175	42"	POTHOLING
5	PG&E	EXISTING 3/4" GAS	3.66 LT "FB" LINE 24+18.86	2014105.090	6461798.224	109.193	36"	POTHOLING

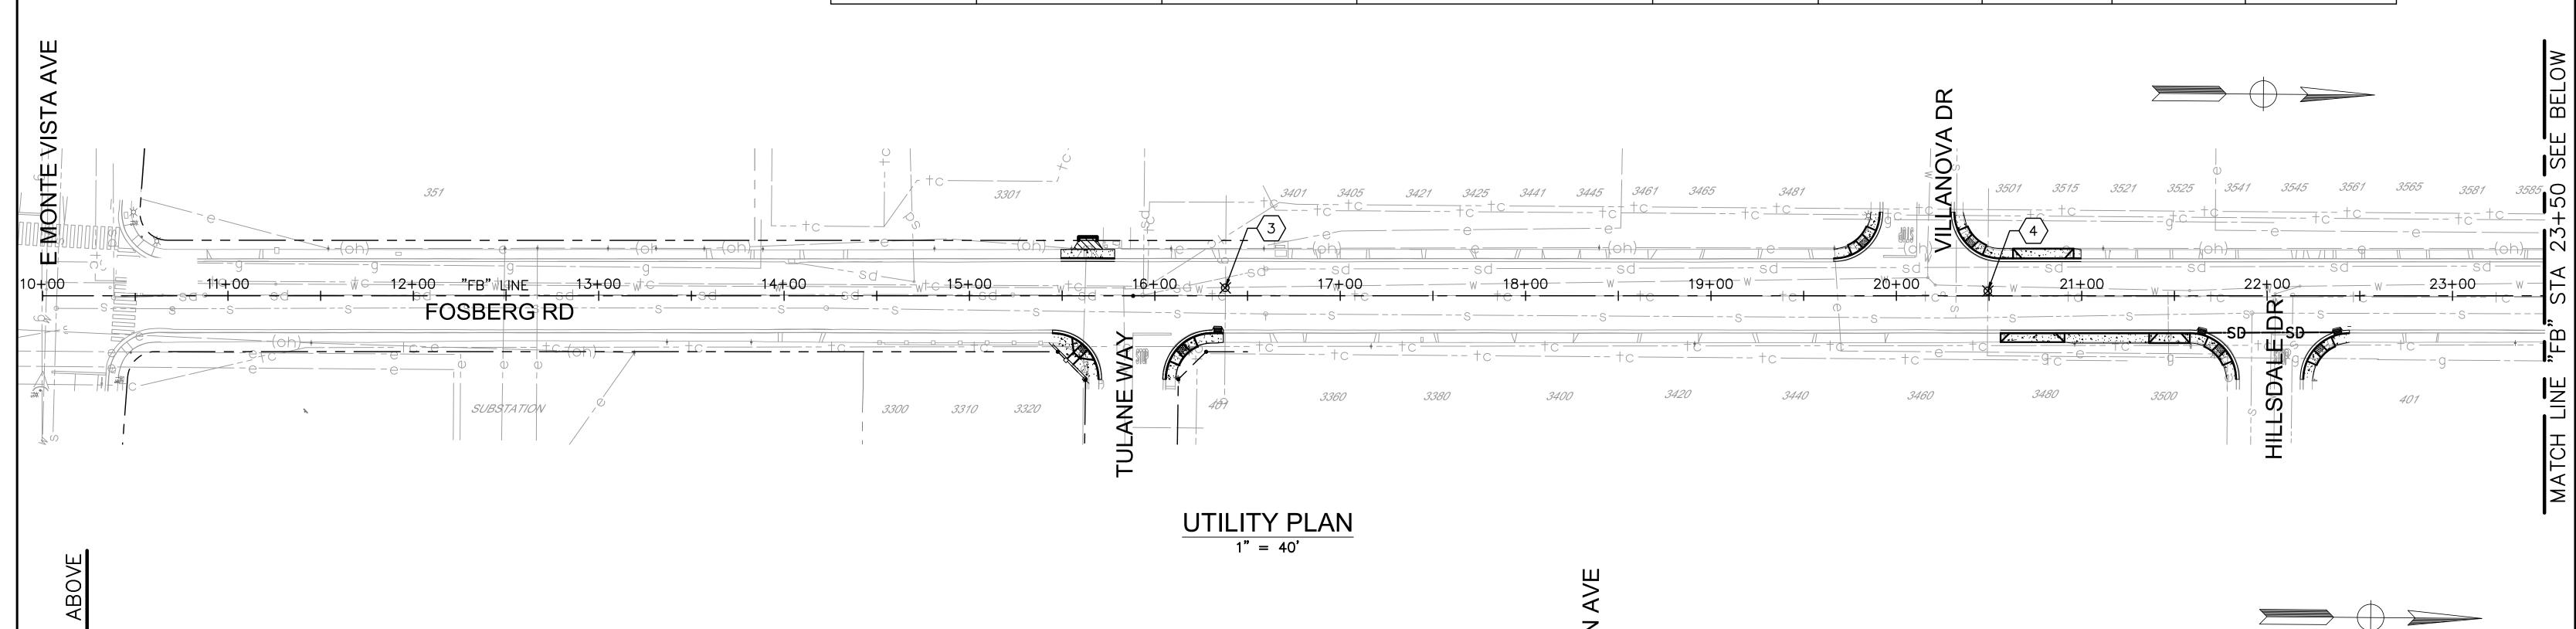

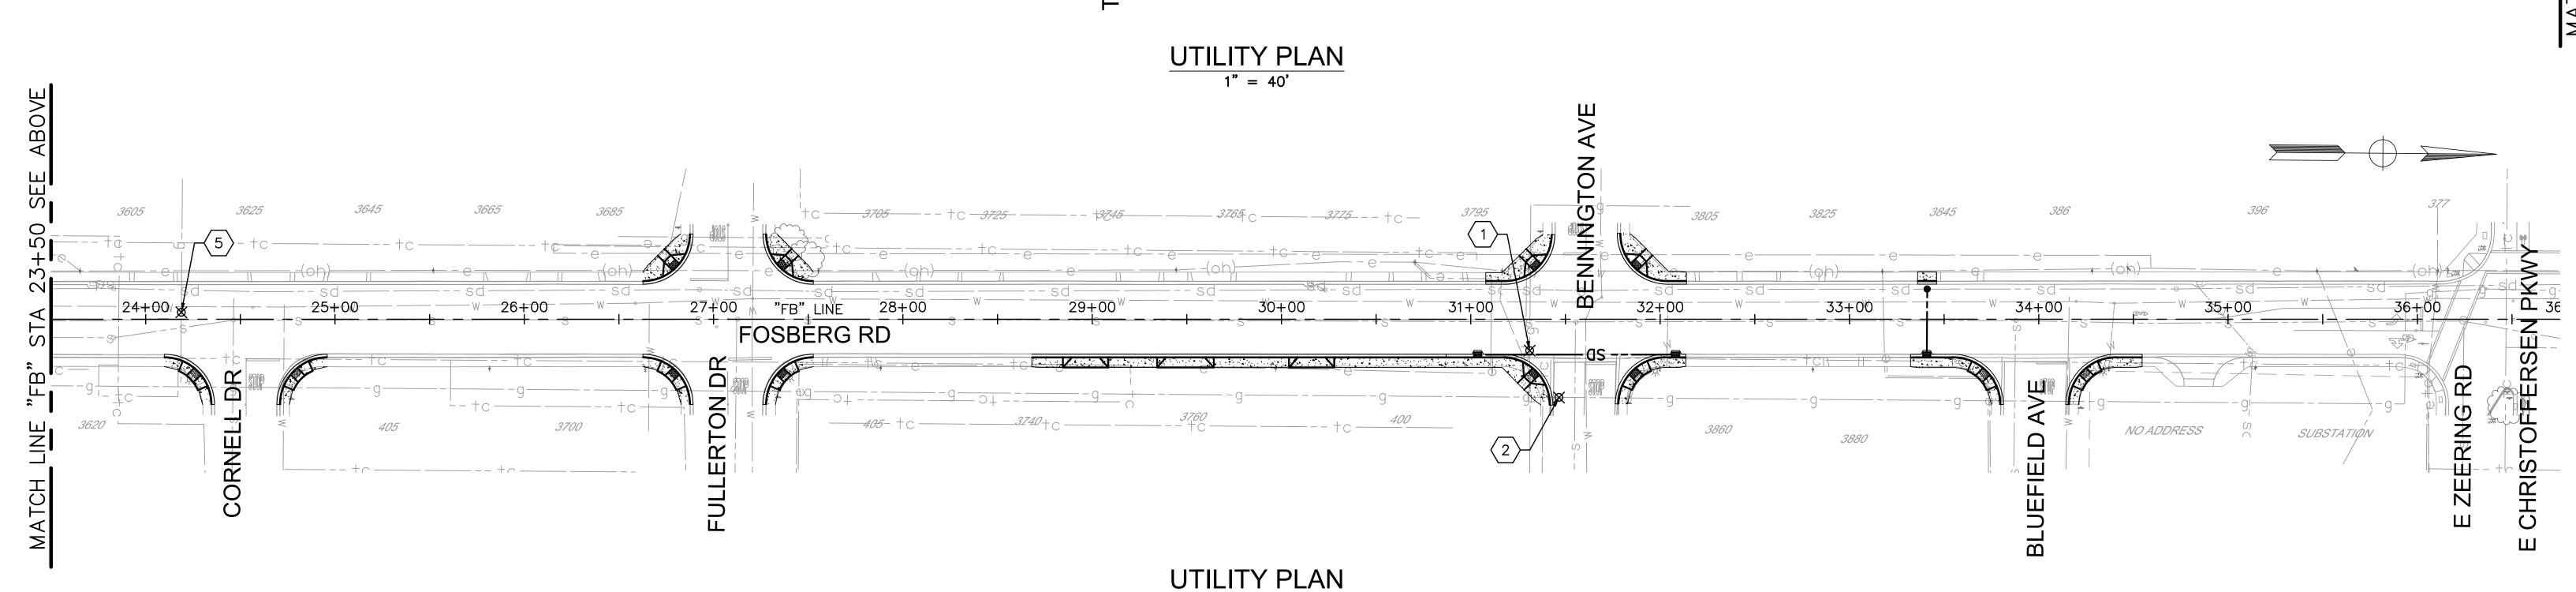


Before You Dig OF WORK.

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SULAIMAN ARAIN P.E. LICENSE No. C78364

PLANS APPROVAL DATE

Michael Baker 500 YGNACIO VALLEY RD SUITE 300 WALNUT CREEK, CA 94596 (925) 906–1460

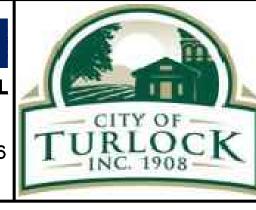

1" = 40'


CITY OF TURLOCK
PUBLIC WORKS
DEPARTMENT
ENGINEERING DIVISION
156 S. BROADWAY,
SUITE 150
(209) 668-5520


UTILITY PLAN FOSBERG ROAD

CAPITAL PROJECT No. 22-001 CITYWIDE STREET RECONSTRUCTION AND IMPROVEMENT PROJECT


VERIFY SCALE BAR IS 1" ON ORIGINAL DRAWING 1/4" 3/4" 0 1 IF NOT ONE INCH ON THIS SHEET, ADJUST SCALES ACCORDINGLY

DRAWN BY: J. MILLER DRAWING No. REV. BY: U-01 CH. BY: S. ARAIN 08/29/2022 AS SHOWN 10 OF 29

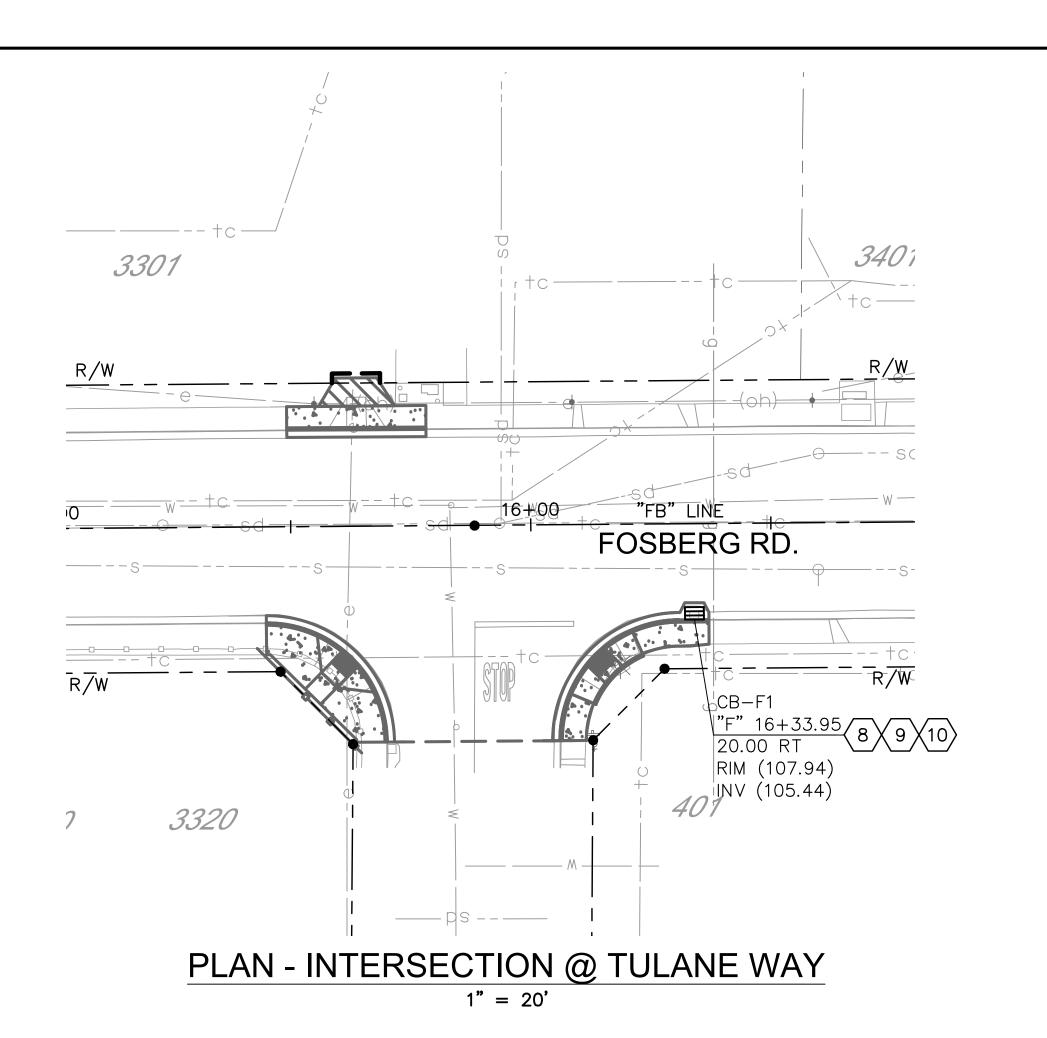

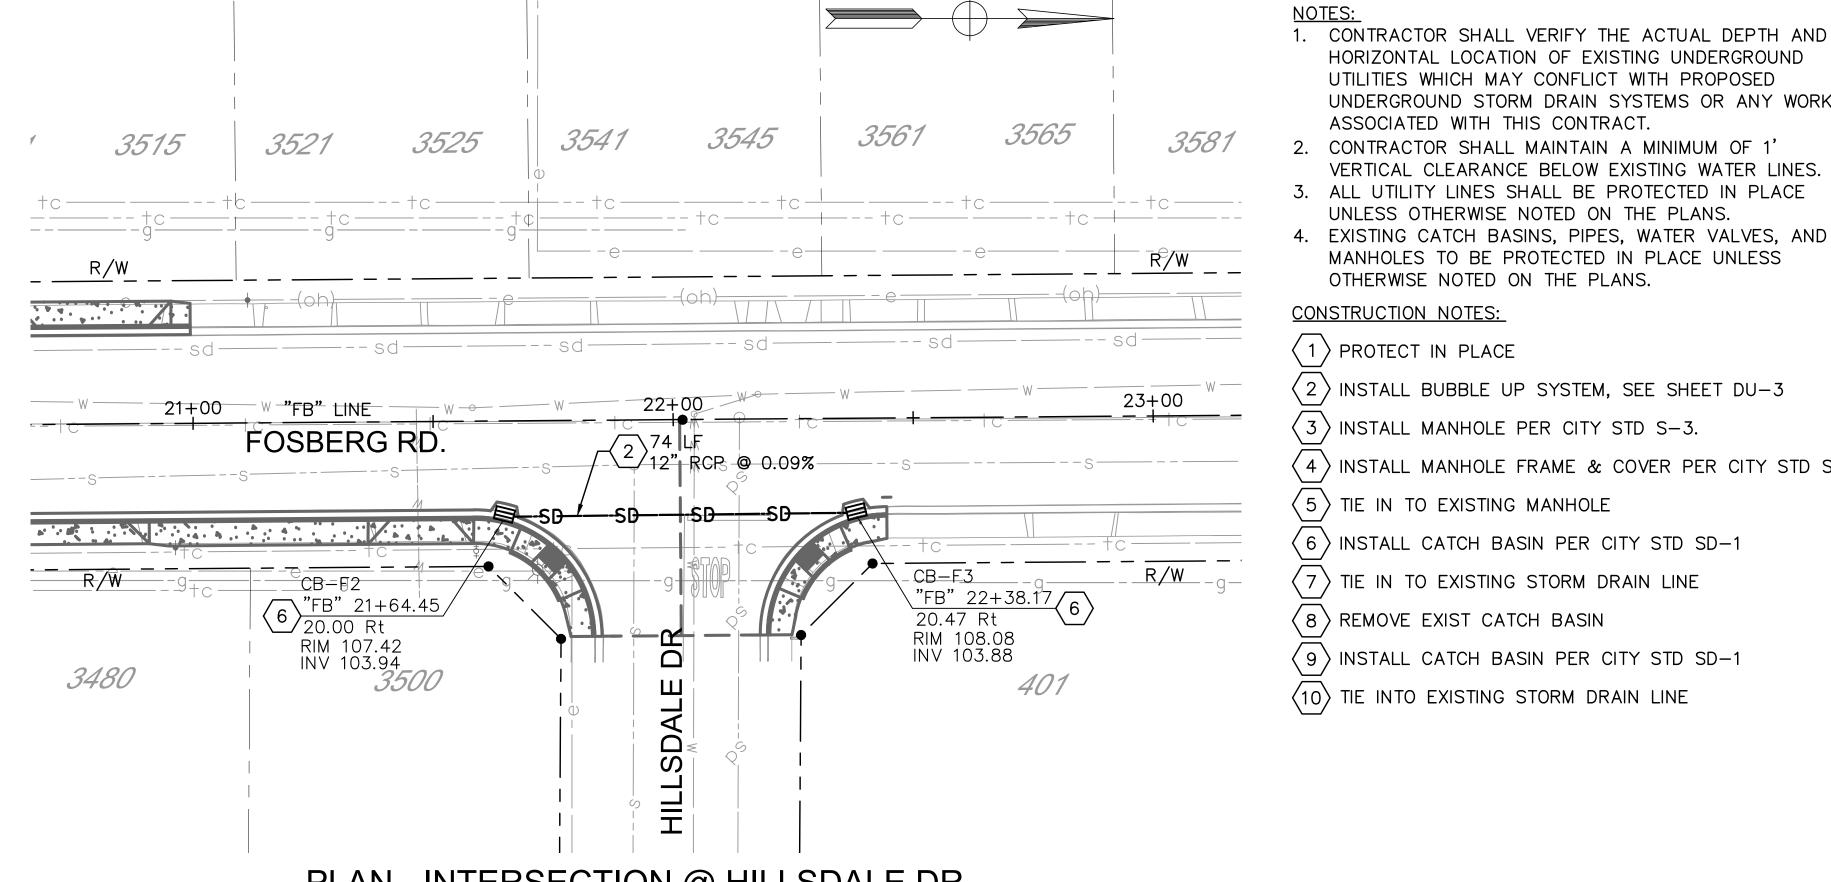

PLAN - INTERSECTION @ HILLSDALE DR

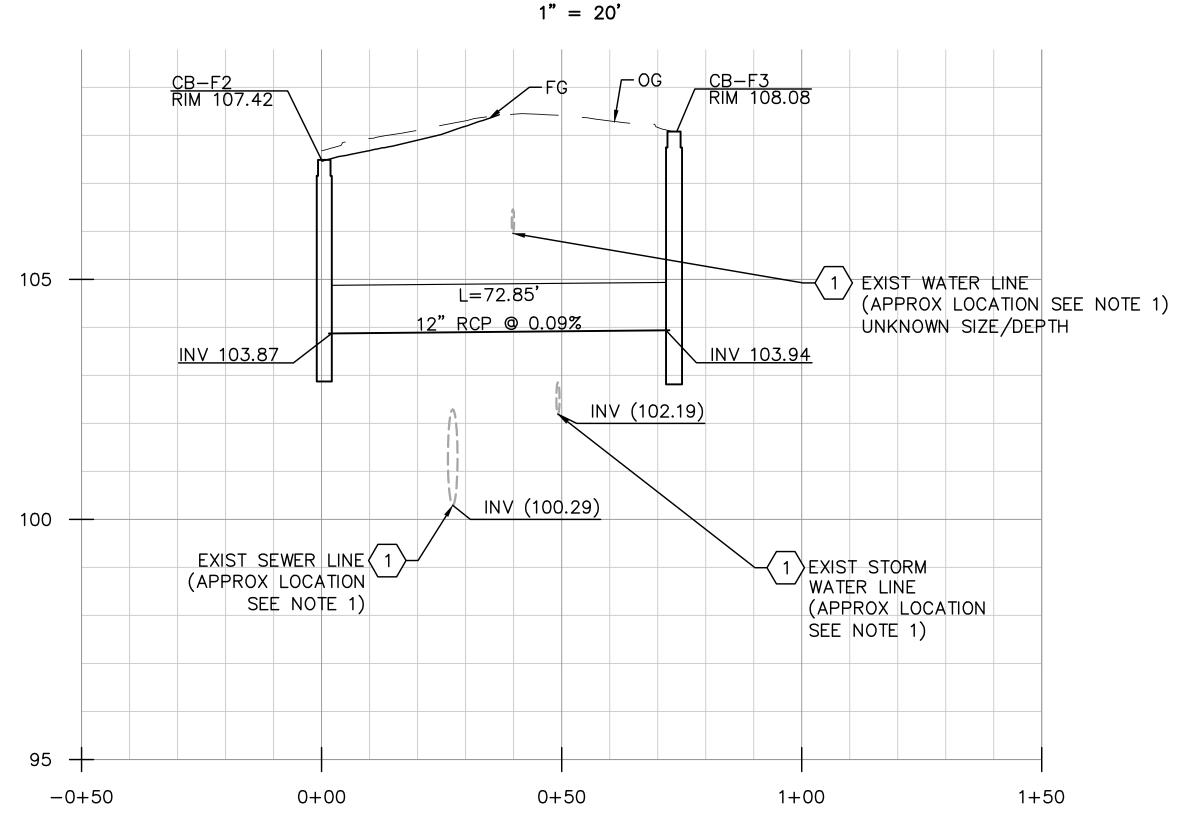

PROFILE - INTERSECTION @ HILLSDALE DRIVE BUBBLE UP - CB-F1, CB-F2


Horiz. 1"=20' Vert. 1" = 2'

Before You Dig OF WORK.


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Maman & Arrain SULAIMAN ARAIN P.E. LICENSE No. C78364

PLANS APPROVAL DATE

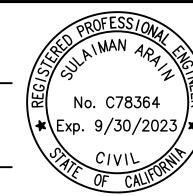

Michael Baker 500 YGNACIO VALLEY RD SUITE 300 WALNUT CREEK, CA 94596 (925) 906-1460

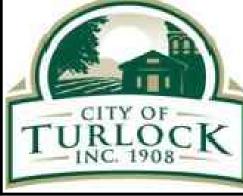

CITY OF TURLOCK PUBLIC WORKS DEPARTMENT **ENGINEERING DIVISION** 156 S. BROADWAY, SUITE 150 (209) 668-5520

DRAINAGE PLAN **FOSBERG ROAD**

CAPITAL PROJECT No. 22-001 CITYWIDE STREET RECONSTRUCTION AND IMPROVEMENT PROJECT

VERIFY	SCALE
BAR IS ORIGINAL 1/4"	DRAWING
0	1"
1/ IF NOT ('2" ONE INCH

ON THIS SHEET,
ADJUST SCALES ACCORDINGLY

HORIZONTAL LOCATION OF EXISTING UNDERGROUND UTILITIES WHICH MAY CONFLICT WITH PROPOSED

ASSOCIATED WITH THIS CONTRACT.

OTHERWISE NOTED ON THE PLANS.

 $\langle 3 \rangle$ INSTALL MANHOLE PER CITY STD S-3.

 $\langle 6 \rangle$ INSTALL CATCH BASIN PER CITY STD SD-1

 $\langle 9 \rangle$ INSTALL CATCH BASIN PER CITY STD SD-1

 $\langle 5 \rangle$ TIE IN TO EXISTING MANHOLE

 $\langle 1 \rangle$ PROTECT IN PLACE

UNDERGROUND STORM DRAIN SYSTEMS OR ANY WORK

VERTICAL CLEARANCE BELOW EXISTING WATER LINES.


UNLESS OTHERWISE NOTED ON THE PLANS.

MANHOLES TO BE PROTECTED IN PLACE UNLESS

 $\langle 2 \rangle$ INSTALL BUBBLE UP SYSTEM, SEE SHEET DU-3

 $\langle 4 \rangle$ INSTALL MANHOLE FRAME & COVER PER CITY STD S-5

DRAWN BY: D. VAGHEFI DRAWING No. REV. BY: DU-01 CH. BY: S. ARAIN 08/29/2022 DATE: SHEET: AS SHOWN SCALE: 11 OF 29

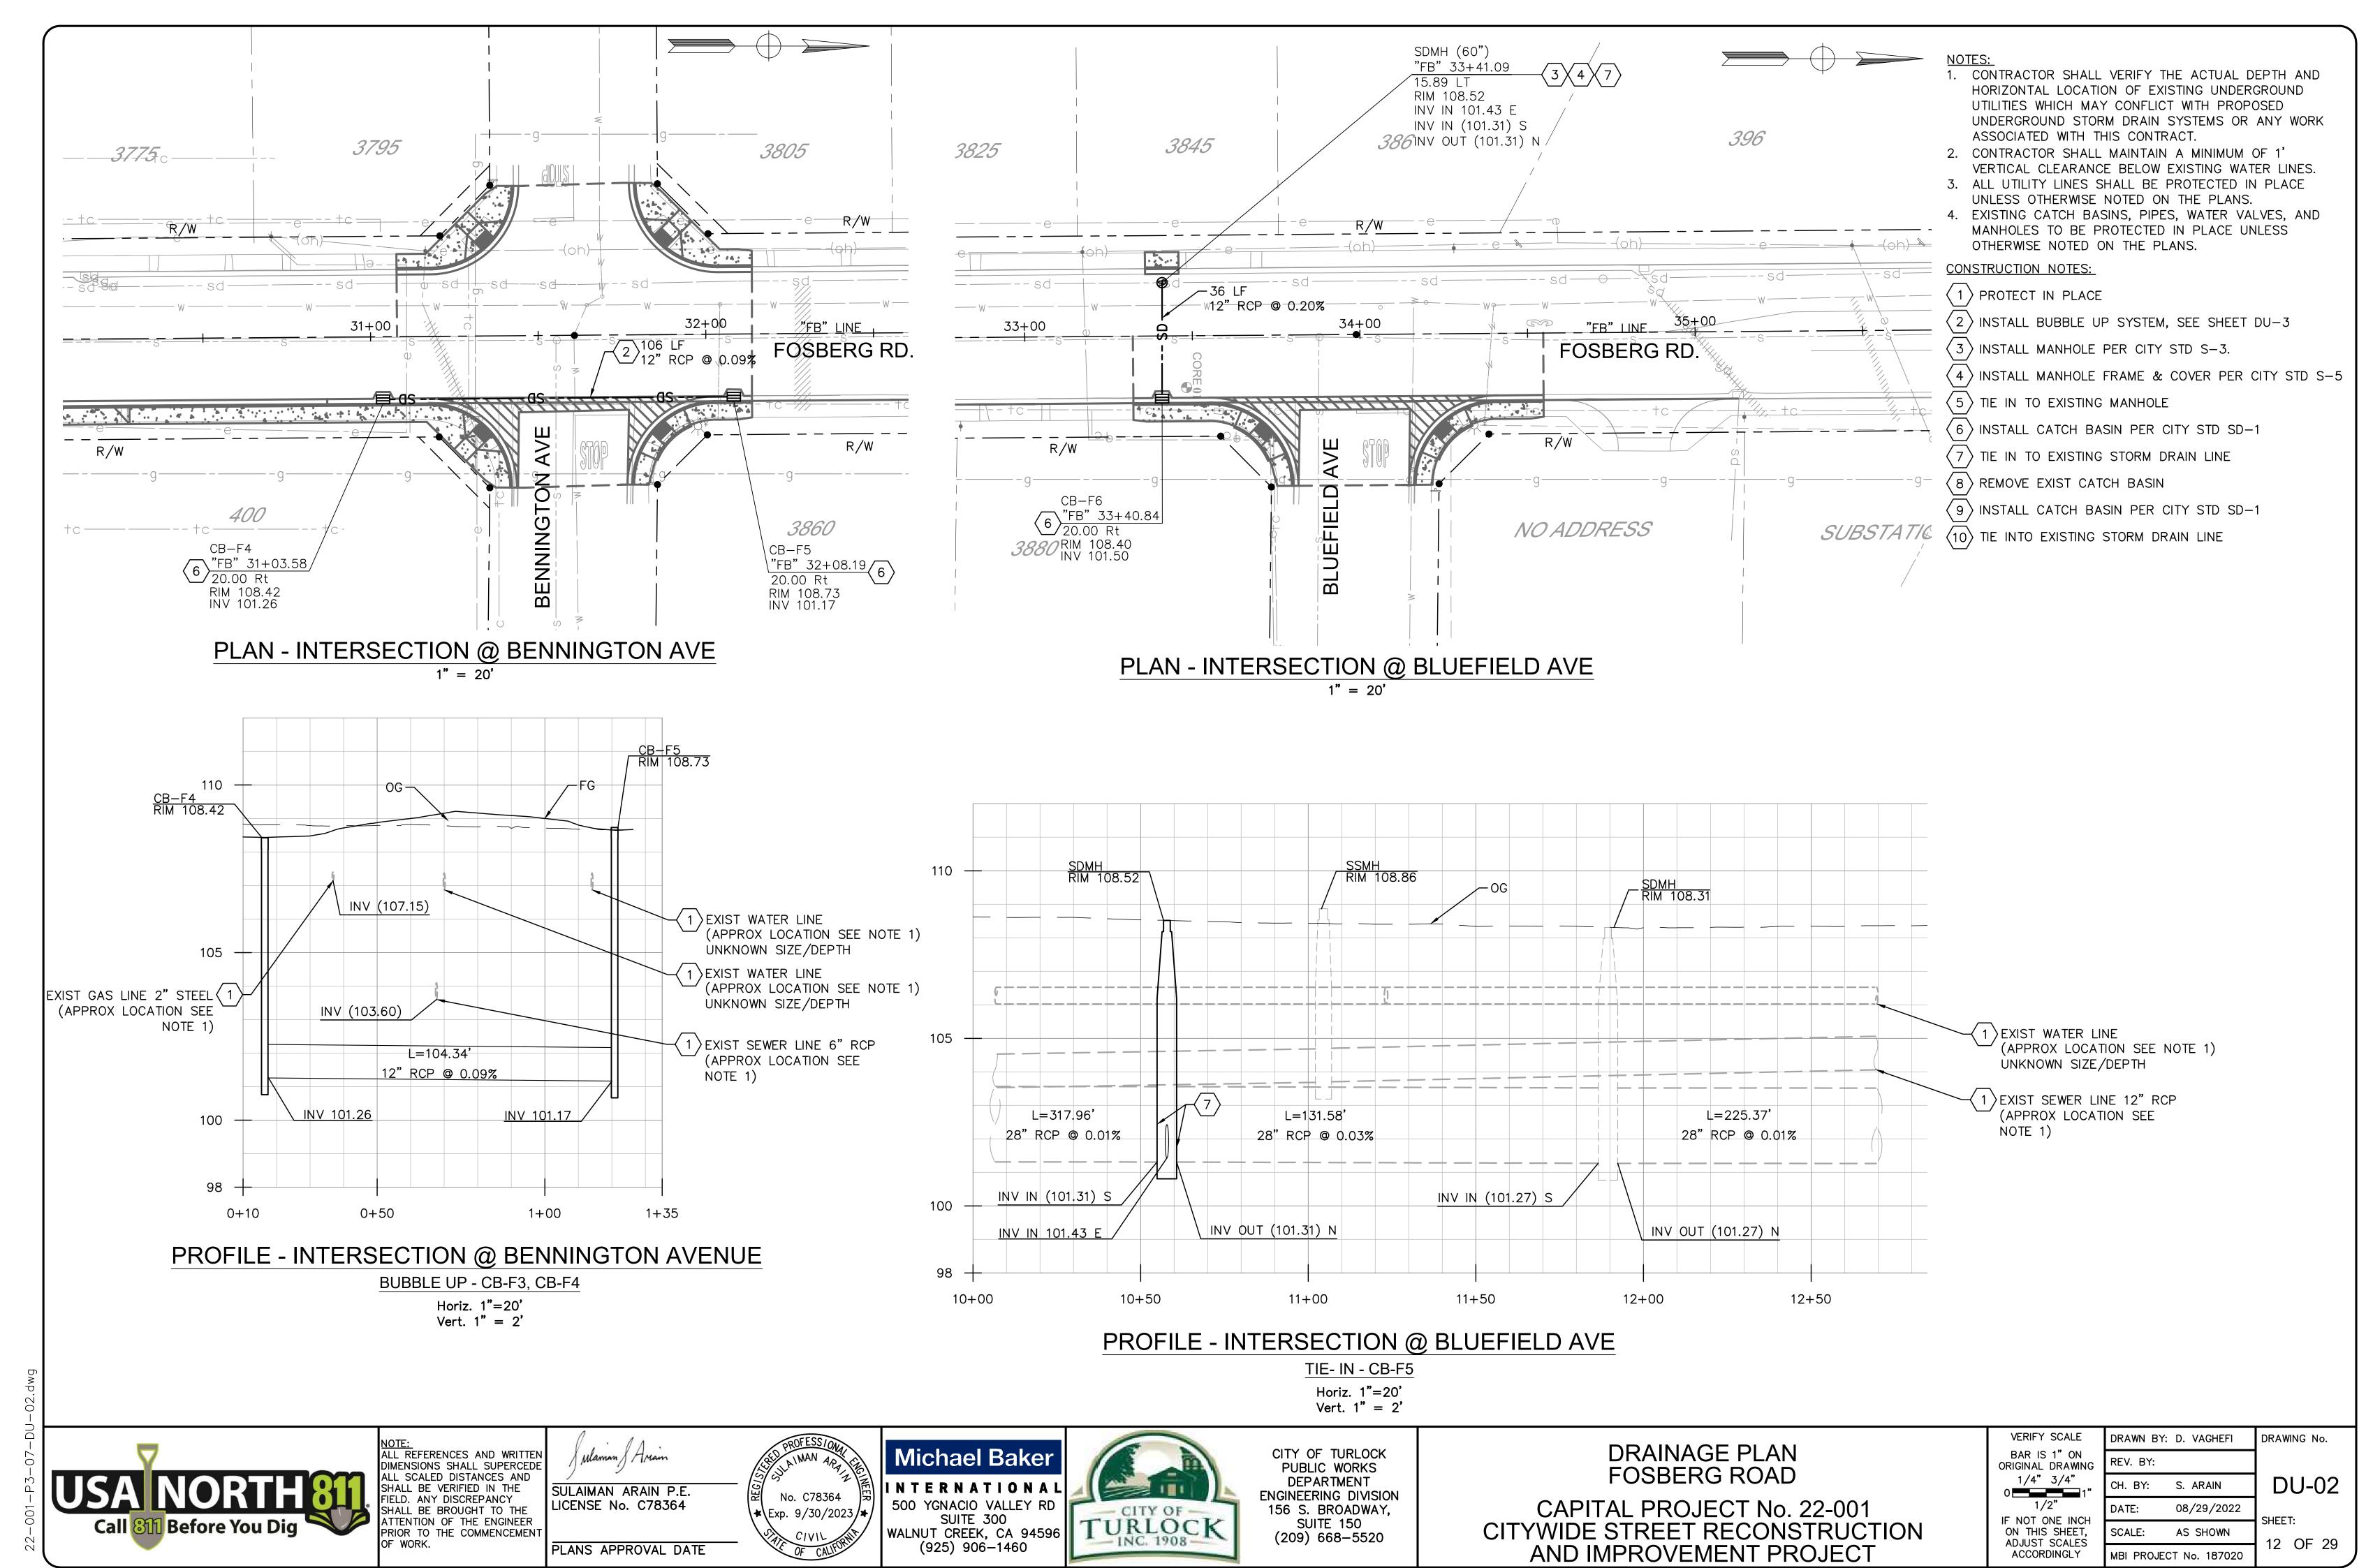

1. CONTRACTOR SHALL VERIFY THE ACTUAL DEPTH AND HORIZONTAL LOCATION OF EXISTING UNDERGROUND UTILITIES WHICH MAY CONFLICT WITH PROPOSED UNDERGROUND STORM DRAIN SYSTEMS OR ANY WORK ASSOCIATED WITH THIS CONTRACT.

- 2. PROPOSED STORMDRAIN PIPE MUST MAINTAIN A MINIMUM OF 12" OUTSIDE DIAMETER CLEARANCE FROM ALL EXISTING UTILITIES.
- 3. IF CONFLICT ARISES WITH EXISTING UTILITIES, CONTRACTOR SHALL PROVIDE REVISED INVERTS FOR STORMDRAIN PIPE TO CITY FOR APPROVAL.

BUBBLE UP SYSTEM



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OF WORK

Maman & Ariam

SULAIMAN ARAIN P.E. LICENSE No. C78364 PLANS APPROVAL DATE



Michael Baker 500 YGNACIO VALLEY RD SUITE 300 WALNUT CREEK, CA 94596 (925) 906-1460



CITY OF TURLOCK PUBLIC WORKS DEPARTMENT ENGINEERING DIVISION 156 S. BROADWAY, SUITE 150 (209) 668-5520

DRAINAGE DETAILS

CAPITAL PROJECT No. 22-001 CITYWIDE STREET RECONSTRUCTION AND IMPROVEMENT PROJECT

VERIFY SCALE BAR IS 1" ON ORIGINAL DRAWING 1/4" 3/4" 0 _____1

1/2" IF NOT ONE INCH ON THIS SHEET, ADJUST SCALES ACCORDINGLY

DRAWN BY: R. GHARAIBEH DRAWING No. REV. BY: **DU-03** CH. BY: S. ARAIN 08/29/2022 SHEET: SCALE: AS SHOWN 13 OF 29

MBI PROJECT No. 187020

12/13/2022 8: 25: 28 AM



TABLE 6H-3 MEANING OF LETTER CODES ON TYPICAL APPLICATION DIAGRAMS DISTANCE BETWEEN SIGNS ** ROAD TYPE URBAN (LOW SPEED) * 100 FEET 100 FEET 100 FEET URBAN (HIGH SPEED) * 350 FEET 350 FEET 350 FEET RURAL 500 FEET 500 FEET 500 FEET EXPRESSWAY / FREEWAY 1000 FEET 1500 FEET 2640 FEET

- * SPEED CATEGORY TO BE DETERMINED BY HIGHWAY AGENCY.
- ** THE A DIMENSION IS THE DISTANCE FROM THE TRANSITION OR POINT OF RESTRICTION ON THE FIRST SIGN. THE B DISTANCE IS THE DISTANCE BETWEEN THE FIRST AND SECOND SIGNS. THE C DIMENSION IS THE DISTANCE BETWEEN THE SECOND AND THIRD SIGNS. (THE "FIRST SIGN" IS THE SIGN IN A THREE-SIGN SERIES THAT IS CLOSEST TO THE TTC ZONE. THE "THIRD SING" IS THE SIGN THAT IS FURTHEST UPSTREAM FROM THE TTC ZONE.)



- 1. VALIDATION: THE TRAFFIC CONTROL PLAN IS NOT VALID UNTIL WORK DATES ARE APPROVED. THE CONTRACTOR SHALL, PER SECTION 601-2 OF THE CITY SUPPLEMENT TO THE STANDARD SPECIFICATIONS FOR PUBLIC WORKS CONSTRUCTION, CONTACT THE PUBLIC WORKS TRAFFIC CONTROL SECTION AT (209) 668-5590 TO OBTAIN A PERMIT. THE CONTRACTOR MUST SUBMIT A COMPLETED TRAFFIC CONTROL PERMIT FORM A MINIMUM OF TWO (2) WORKING DAYS PRIOR TO STARTING WORK, OR FIVE (5) WORKING DAYS WHEN WORK WILL AFFECT A TRAFFIC SIGNAL.
- 2. STANDARDS: THIS TRAFFIC CONTROL PLAN SHALL CONFORM TO EACH OF THE FOLLOWING MANUALS:

EDITION DESCRIPTION

CITY OF TURLOCK STANDARD SPECIFICATIONS AND DRAWINGS

CALTRANS STANDARD PLANS

- CALIFORNIA MANUAL ON UNIFORM TRAFFIC CONTROL DEVICES (CA MUTCD)
- 3. NOTIFICATIONS: THE CONTRACTOR SHALL NOTIFY RELEVANT AGENCIES A MINIMUM OF FIVE (5) WORKING DAYS PRIOR TO ANY EXCAVATION. CONSTRUCTION, OR TRAFFIC CONTROL.
- 4. THE CONTRACTOR SHALL NOTIFY PROPERTY OWNERS AND TENANTS A MINIMUM OF SEVEN (7) WORKING DAYS PRIOR TO CLOSURE OF DRIVEWAYS. THE CONTRACTOR SHALL POST SIGNS NOTIFYING THE PUBLIC A MINIMUM OF SEVEN (7) WORKING DAYS PRIOR TO CLOSURE OF STREETS. INDIVIDUAL DRIVEWAY CLOSURES ARE LIMITED TO A MAXIMUM OF 4 DAYS.
- 5. POSTING PARKING RESTRICTIONS: THE CONTRACTOR SHALL POST "TOW-AWAY/NO PARKING" SIGNS SEVENTY TWO (72) HOURS IN ADVANCE OF PARKING REMOVAL. SIGNS SHALL INDICATE SPECIFIC DAYS, DATES, AND TIMES OF RESTRICTIONS.
- 6. EXCAVATIONS: EXCEPT AS OTHERWISE SHOWN ON THE PLANS, TRENCHES SHALL BE BACKFILLED OR TRENCH-PLATED AT THE END OF EACH WORK DAY. AN ASPHALT RAMP SHALL BE PLACED AROUND EACH TRENCH PLATE TO PREVENT THE PLATE FROM BEING DISLODGED. CONTRACTOR SHALL MONITOR TRENCH PLATES DURING NON-WORKING HOURS TO ENSURE THAT THEY DO NOT BECOME DISLODGED. UPON COMPLETION OF EXCAVATION BACKFILL, THE CONTRACTOR SHALL PROVIDE A SATISFACTORY SURFACE FOR TRAFFIC. WHEN CONSTRUCTION OPERATIONS ARE NOT ACTIVELY IN PROGRESS. THE CONTRACTOR SHALL MAINTAIN ALL TRAVEL LANES, BIKE LANES, AND PEDESTRIAN WALKWAYS OPEN TO THE APPROPRIATE TRAFFIC EXCEPT AS OTHERWISE SHOWN ON THE PLANS.
- RESTORATION OF TRAFFIC CONTROL DEVICES: THE CONTRACTOR SHALL REPAIR OR REPLACE TRAFFIC CONTROL DEVICES (INCLUDING TRAFFIC SIGNS, STRIPING, PAVEMENT MARKERS, PAVEMENT MARKINGS, LEGENDS, CURB MARKINGS, LOOP DETECTORS, TRAFFIC SIGNAL EQUIPMENT, ETC.) DAMAGED OR REMOVED AS A RESULT OF OPERATIONS AND NOT DESIGNATED FOR REMOVAL. REPAIRS AND REPLACEMENTS SHALL BE AT LEAST EQUAL TO EXISTING IMPROVEMENT.
- 8. TEMPORARY TRAFFIC SIGNAL DETECTION: THE CONTRACTOR SHALL INSTALL CITY APPROVED TEMPORARY VIDEO OR RADAR DETECTION WHEN EXISTING TRAFFIC SIGNAL DETECTION SYSTEMS ARE DAMAGED, DISABLED, OR BECOME INEFFECTIVE DUE TO CONSTRUCTION FOR A PERIOD OF FIVE (5) OR MORE DAYS. THE CONTRACTOR SHALL COMPLETELY REMOVE ALL TEMPORARY TRAFFIC SIGNAL DETECTION EQUIPMENT AND RESTORE/INSTALL A CITY APPROVED PERMANENT VEHICLE DETECTION SYSTEM UPON COMPLETION OF CONSTRUCTION. ALL INSTALLATION AND REMOVALS ARE SUBJECT TO APPROVAL BY THE CITY ENGINEER.
- 9. CHANGE IN WORK: THE CITY ENGINEER WILL OBSERVE THESE TRAFFIC CONTROL PLANS IN OPERATION AND RESERVE THE RIGHT TO MAKE ANY CHANGES AS FIELD CONDITIONS WARRANT. ANY CHANGES SHALL BE DOCUMENTED AND SUPERCEDE THESE PLANS.
- 10. OPEN TRENCH: THE CONTRACTOR SHALL PLACE "OPEN TRENCH" SIGNS (C27(CA)) ON TYPE III BARRICADES WITHIN THE WORK ZONE, AHEAD OF ANY WORK AREA WHICH INCLUDES OPEN TRENCHES IN EXCESS OF THREE (3) INCHES IN DEPTH, PER CA MUTCD SECTION 6F.103 (CA) GUIDELINES.
- 11. FOR WORK NOT COVERED BY THESE TRAFFIC CONTROL PLANS: THE CONTRACTOR SHALL PREPARE TRAFFIC CONTROL WORKING DRAWINGS AND SUBMIT THEM TO THE CITY RESIDENT ENGINEER. THE CONTRACTOR SHALL ALLOW A MINIMUM OF TWENTY (20) WORKING DAYS FOR REVIEW OF THE WORKING DRAWINGS. UPON APPROVAL OF THE TRAFFIC CONTROL PLAN, THE PUBLIC WORKS TRAFFIC CONTROL SECTION WILL ISSUE A TRAFFIC CONTROL PLAN (TCP) PERMIT FOR THIS WORK.
- 12. CONTRACTOR SHALL INSTALL UNEVEN PAVEMENT SIGNS C46 (CA) ALONG THE EDGE OF AREAS WHERE A STEP OF GREATER THAN 2' EXISTS WHETHER PARALLEL OR PERPENDICULAR TO THE DIRECTION OF TRAVEL.
- 13. CONTRACTOR HAS THE OPTION TO WORK AT MULTIPLE LOCATIONS CONCURRENTLY. ADJACENT BLOCKS SHALL NOT BE REDUCED TO ONE-WAY TRAFFIC AT THE SAME TIME.

SEQUENCE OF CONSTRUCTION NOTES:

STAGE 1

1. IMPLEMENT DETOUR PLAN PER TD-01.

- 2. IMPLEMENT TRAFFIC CONTROL PLANS PER DETAIL A, TC-02 FOR THE BLOCK OF FOSBERG ROAD FROM E. MONTE VISTA AVENUE TO VILLANOVA DRIVE.
- 3. CONSTRUCT THE WEST HALF OF FOSBERG ROAD BETWEEN E. MONTE VISTA AVENUE AND VILLANOVA DRIVE.
- 4. AT THE COMPLETION OF EACH BLOCK, SHIFT TRAFFIC CONTROL AND CONSTRUCT THE WEST HALF OF FOSBERG ROAD FOR THE NEXT BLOCK TO THE NORTH OF THE PRIOR BLOCK.
- 5. REPEAT THE PROCESS UNTIL THE WEST HALF OF FOSBERG ROAD BETWEEN E. MONTE VISTA AVENUE AND EAST CHRISTOFFERSEN PARKWAY IS CONSTRUCTED COMPLETELY.
- 6. REMOVE ALL TRAFFIC CONTROL AND DETOUR DEVICES AND CONTINUE TO STAGE 2.

STAGE 2

1. IMPLEMENT DETOUR PLAN PER TD-02.

- 2. IMPLEMENT TRAFFIC CONTROL PLANS PER DETAIL B, TC-02 FOR THE BLOCK OF FOSBERG ROAD FROM E. MONTE VISTA AVENUE TO TULANE WAY.
- 3. CONSTRUCT THE EAST HALF OF FOSBERG ROAD BETWEEN E. MONTE VISTA AVENUE AND TULANE WAY.
- 4. AT THE COMPLETION OF EACH BLOCK, SHIFT TRAFFIC CONTROL AND CONSTRUCT THE EAST HALF OF FOSBERG ROAD FOR THE NEXT BLOCK TO THE NORTH OF THE PRIOR BLOCK.
- 5. REPEAT THE PROCESS UNTIL THE EAST HALF OF FOSBERG ROAD BETWEEN E. MONTE VISTA AVENUE AND EAST CHRISTOFFERSEN PARKWAY IS CONSTRUCTED COMPLETELY.
- 6. REMOVE ALL TRAFFIC CONTROL AND DETOUR DEVICES.

NON-STAGED CONSTRUCTION

- 1. PRIOR TO STAGED CONSTRUCTION WORK AT ANY LOCATION, CONTRACTOR MAY UTILIZE TEMPORARY SHORT-TERM LANE CLOSURES TO CONSTRUCT CONCRETE SIDEWALK, PEDESTRIAN RAMP, DRIVEWAY, AND CURB AND GUTTER IMPROVEMENTS. CONTRACTOR SHALL SUBMIT SHORT TERM LANE CLOSURE PLANS A MINIMUM OF 14 DAYS IN ADVANCE OF NEED FOR CITY APPROVAL
- 2. TEMPORARY SHORT TERM CLOSURES SHALL INCLUDE PEDESTRIAN ACCESS AND DETOUR DETAILS AS APPLICABLE.
- 3. CONTRACTOR SHALL PROVIDE TEMPORARY FLAGGERS FOR THE INSTALLATION OF PAVEMENT MARKINGS THROUGH THE INTERSECTION OF FOSBERG ROAD AND CHRISTOFFERSEN PARKWAY.




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PLANS APPROVAL DATE



Michael Baker 500 YGNACIO VALLEY RD SUITE 300 WALNUT CREEK, CA 94596 (925) 906-1460



CITY OF TURLOCK PUBLIC WORKS DEPARTMENT **ENGINEERING DIVISION** 156 S. BROADWAY. SUITE 150 (209) 668 - 5520

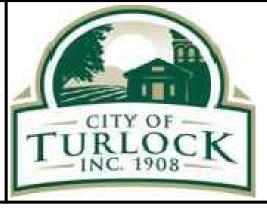TRAFFIC CONTROL **KEY MAP AND NOTES**

CAPITAL PROJECT No. 22-001 CITYWIDE STREET RECONSTRUCTION AND IMPROVEMENT PROJECT


VERIFY	SC	ALE
BAR IS		
ORIGINAL	DR.	AWI۱
1/4"		
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DRAWN BY: R. LIM REV. BY: CH. BY: C. MARTINELL 08/29/2022 ON THIS SHEET,


SCALE: AS SHOWN ADJUST SCALES 14 OF 29 ACCORDINGLY MBI PROJECT No. 187020

DRAWING No.


TC-01

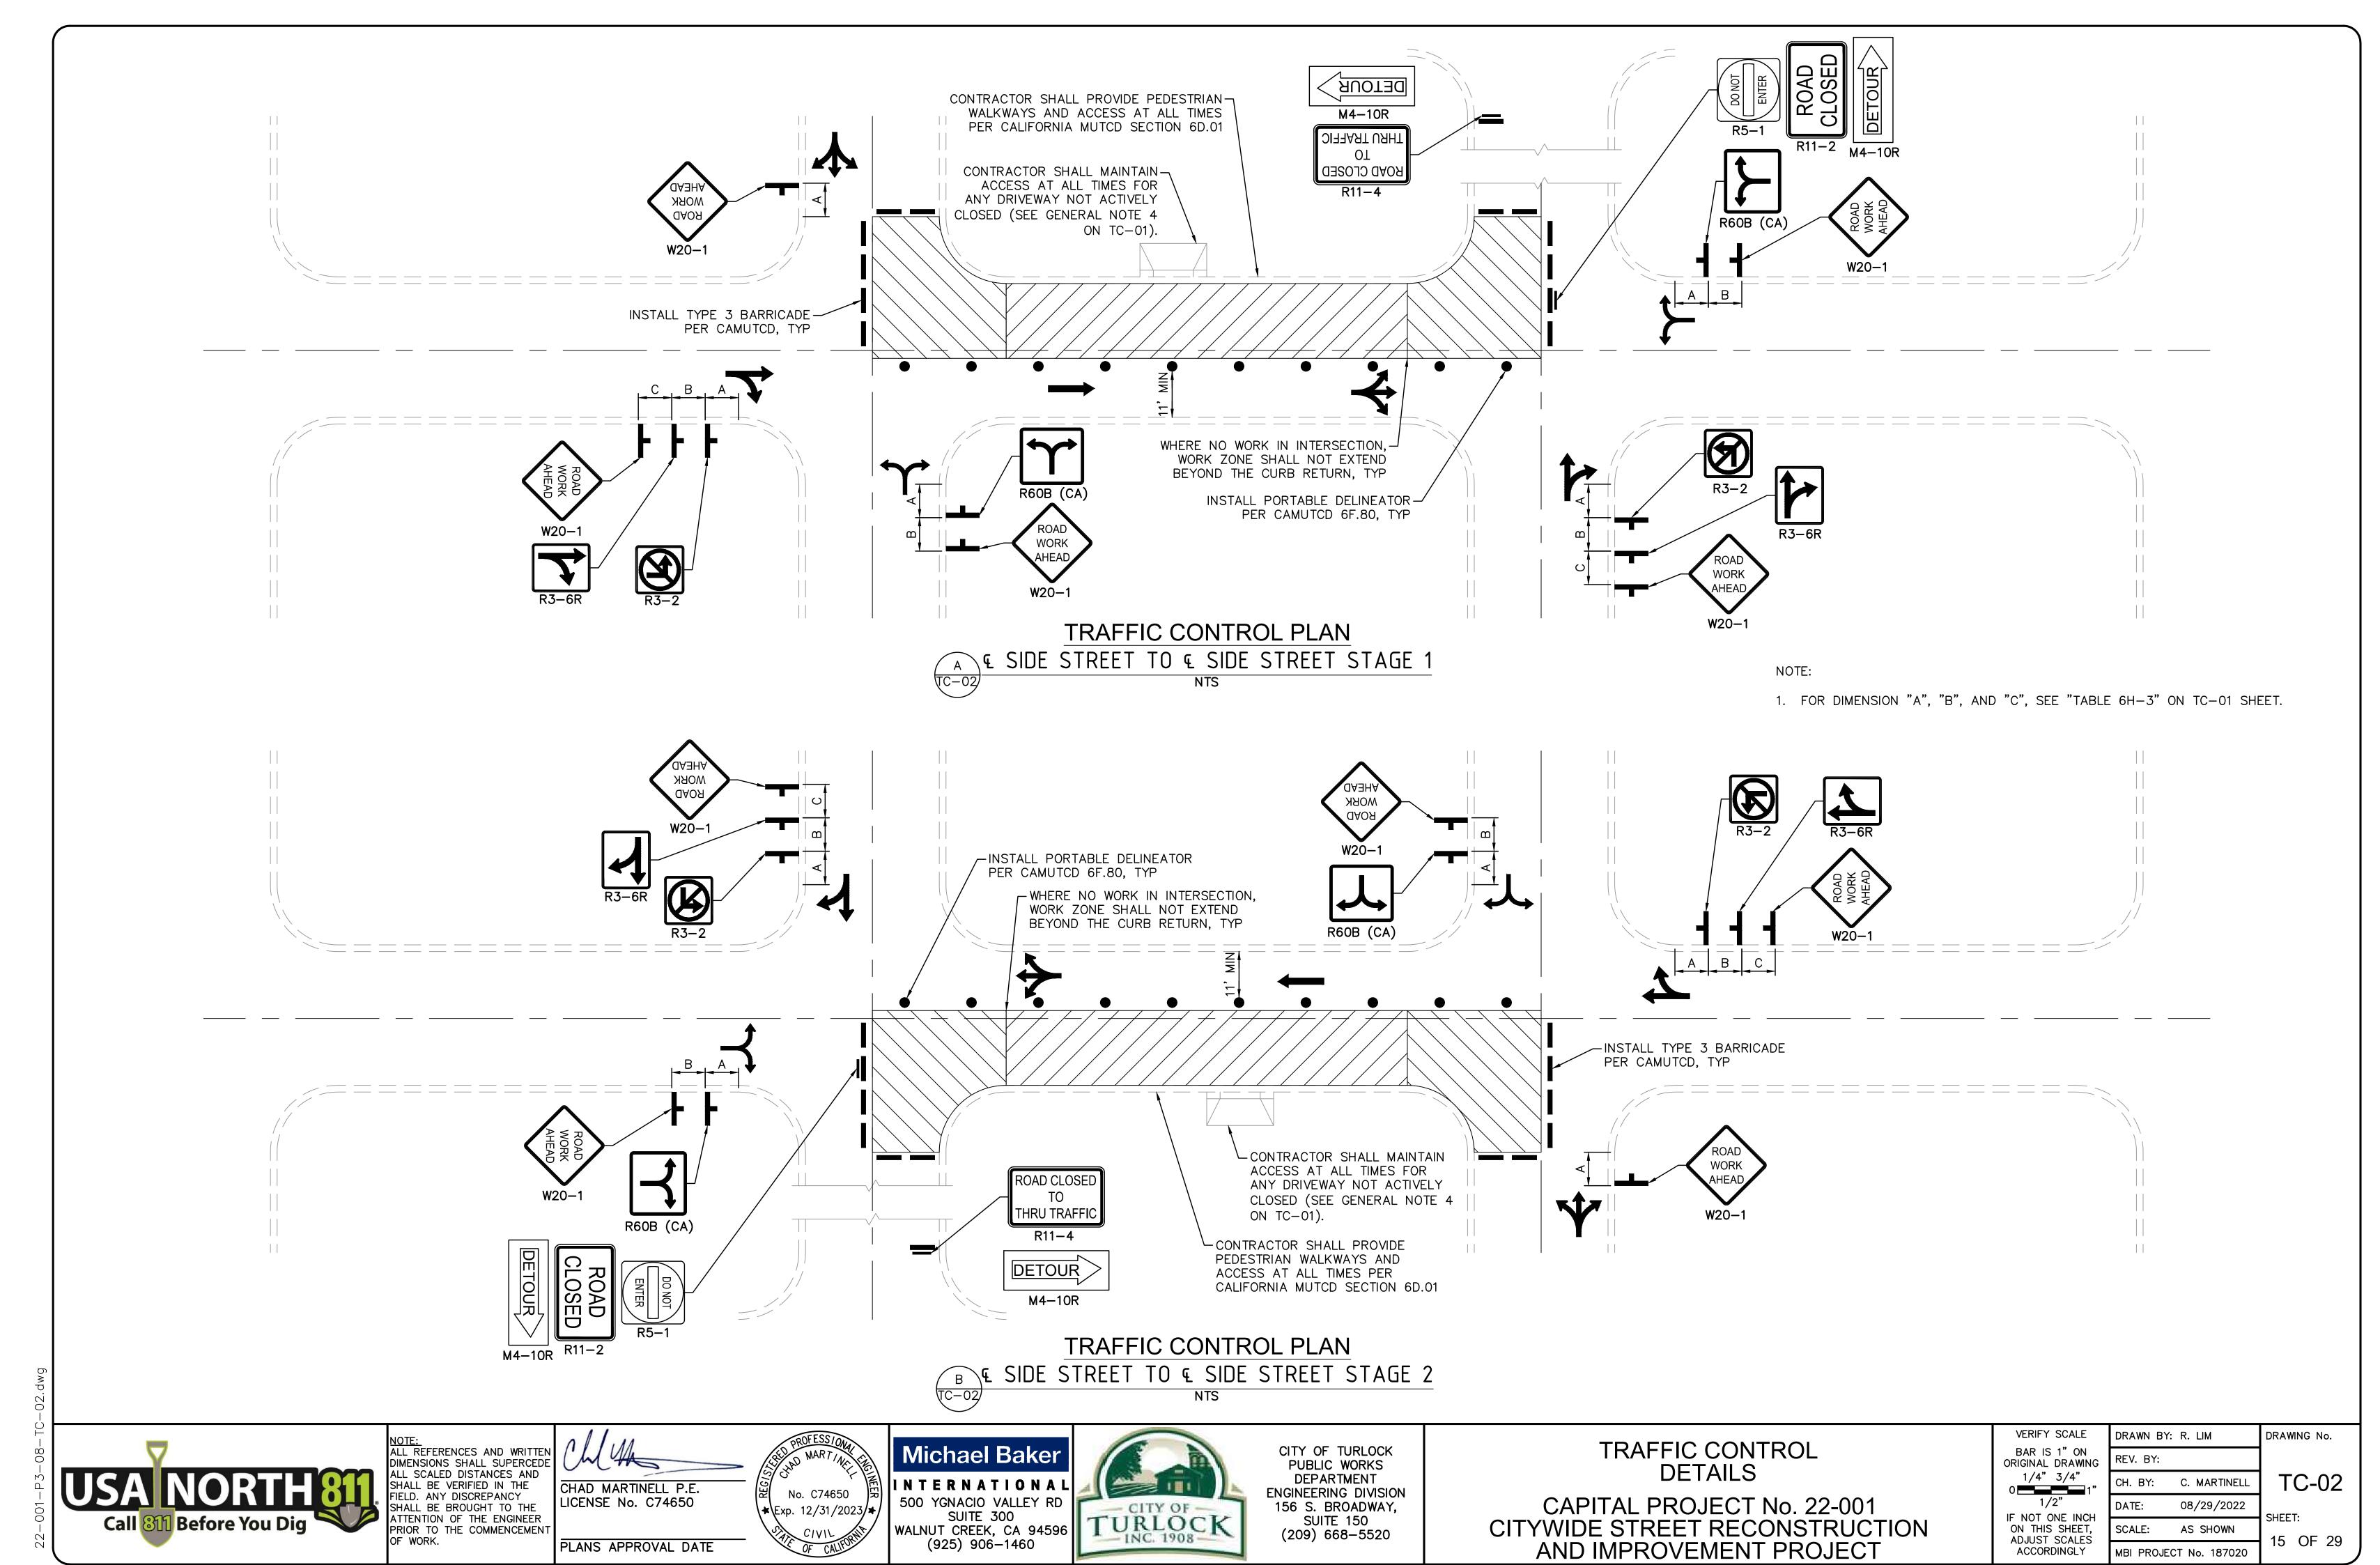

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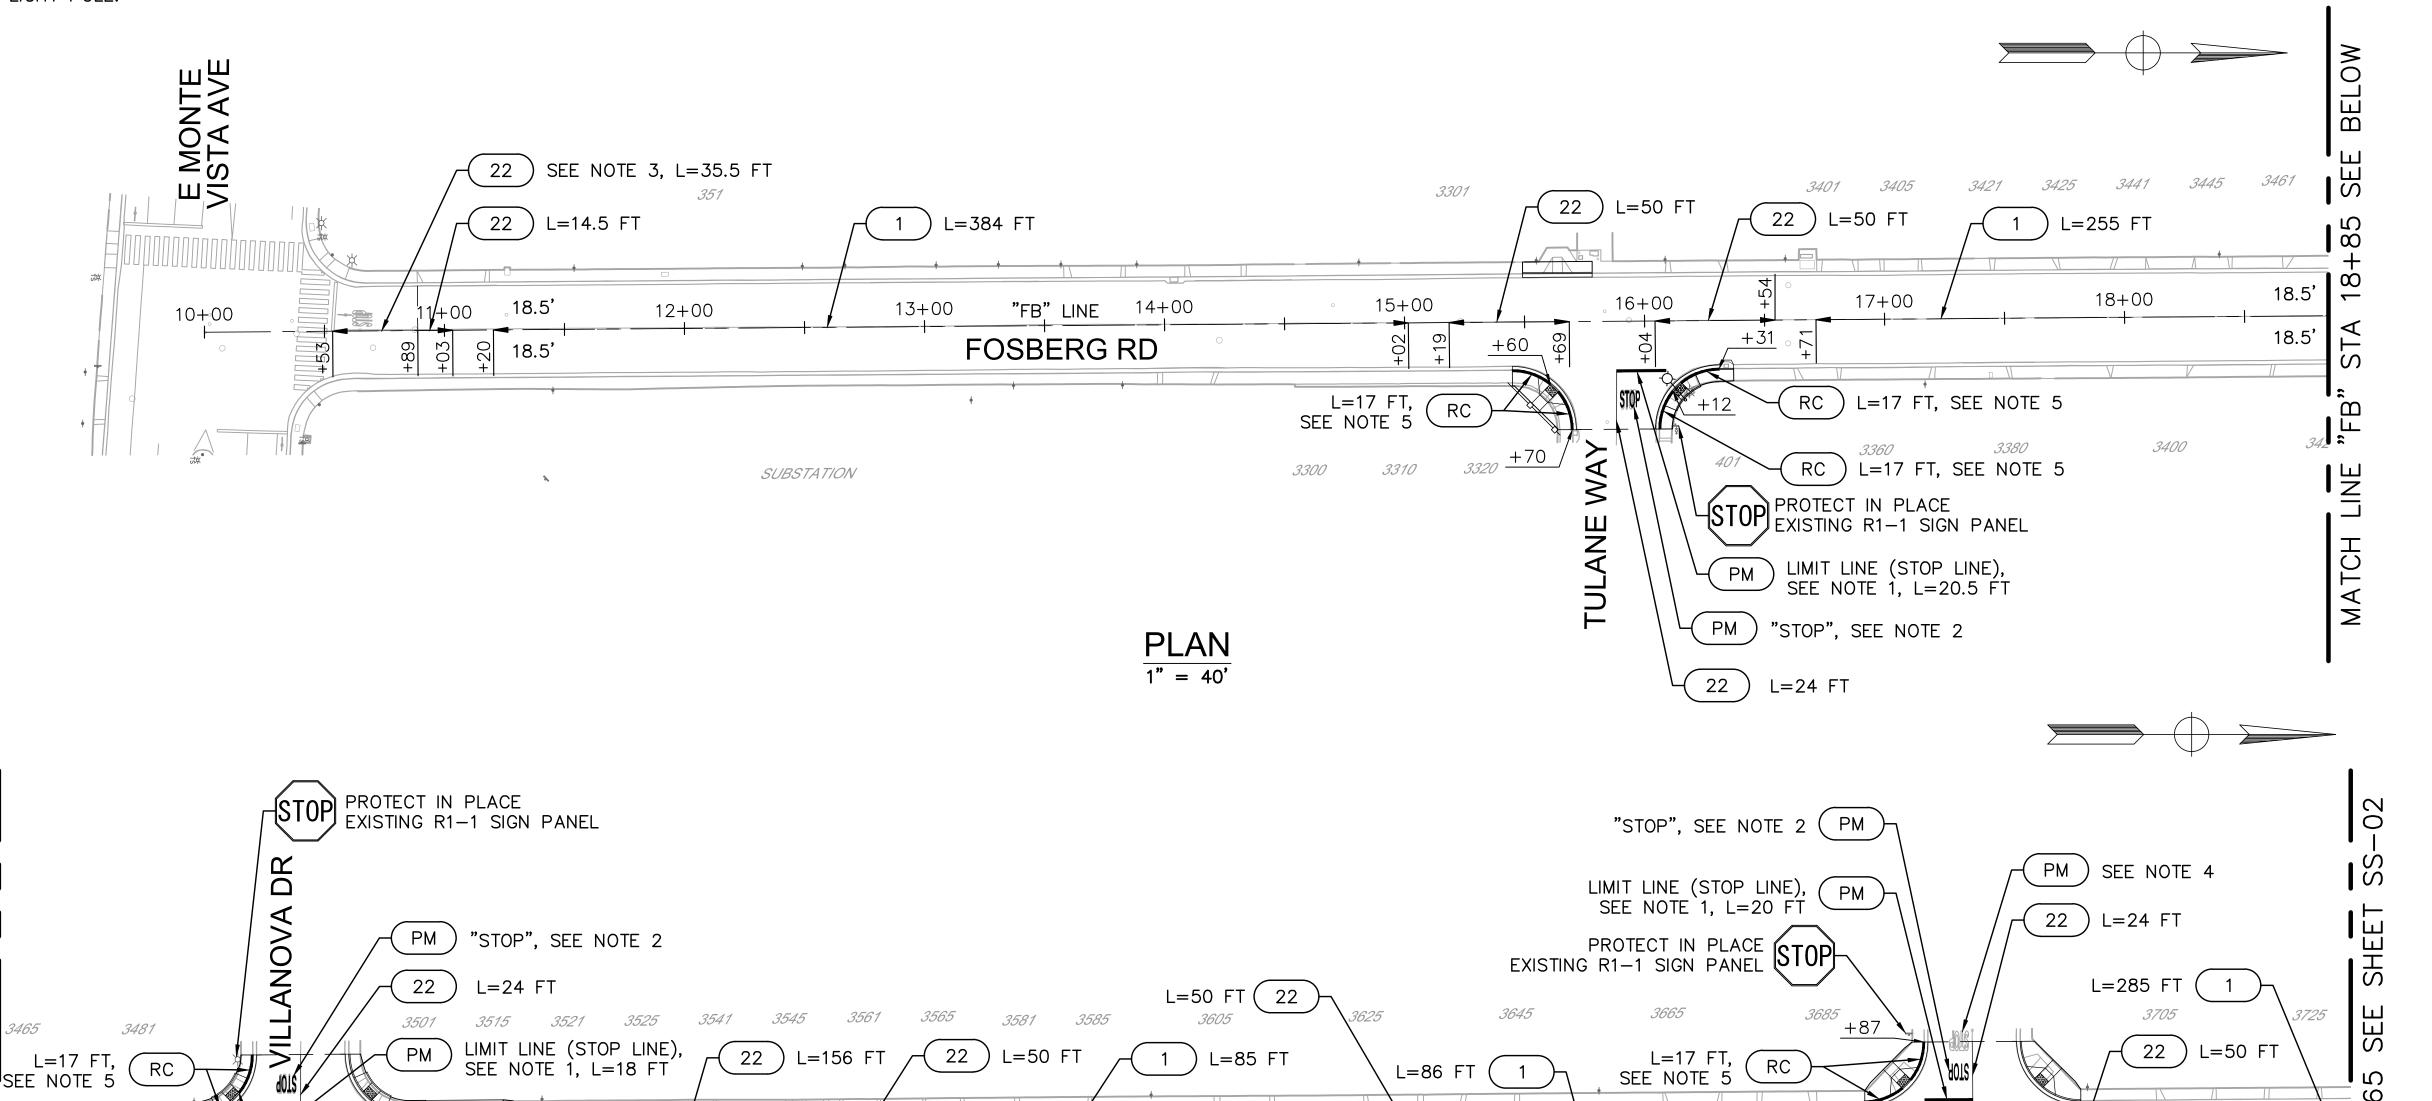

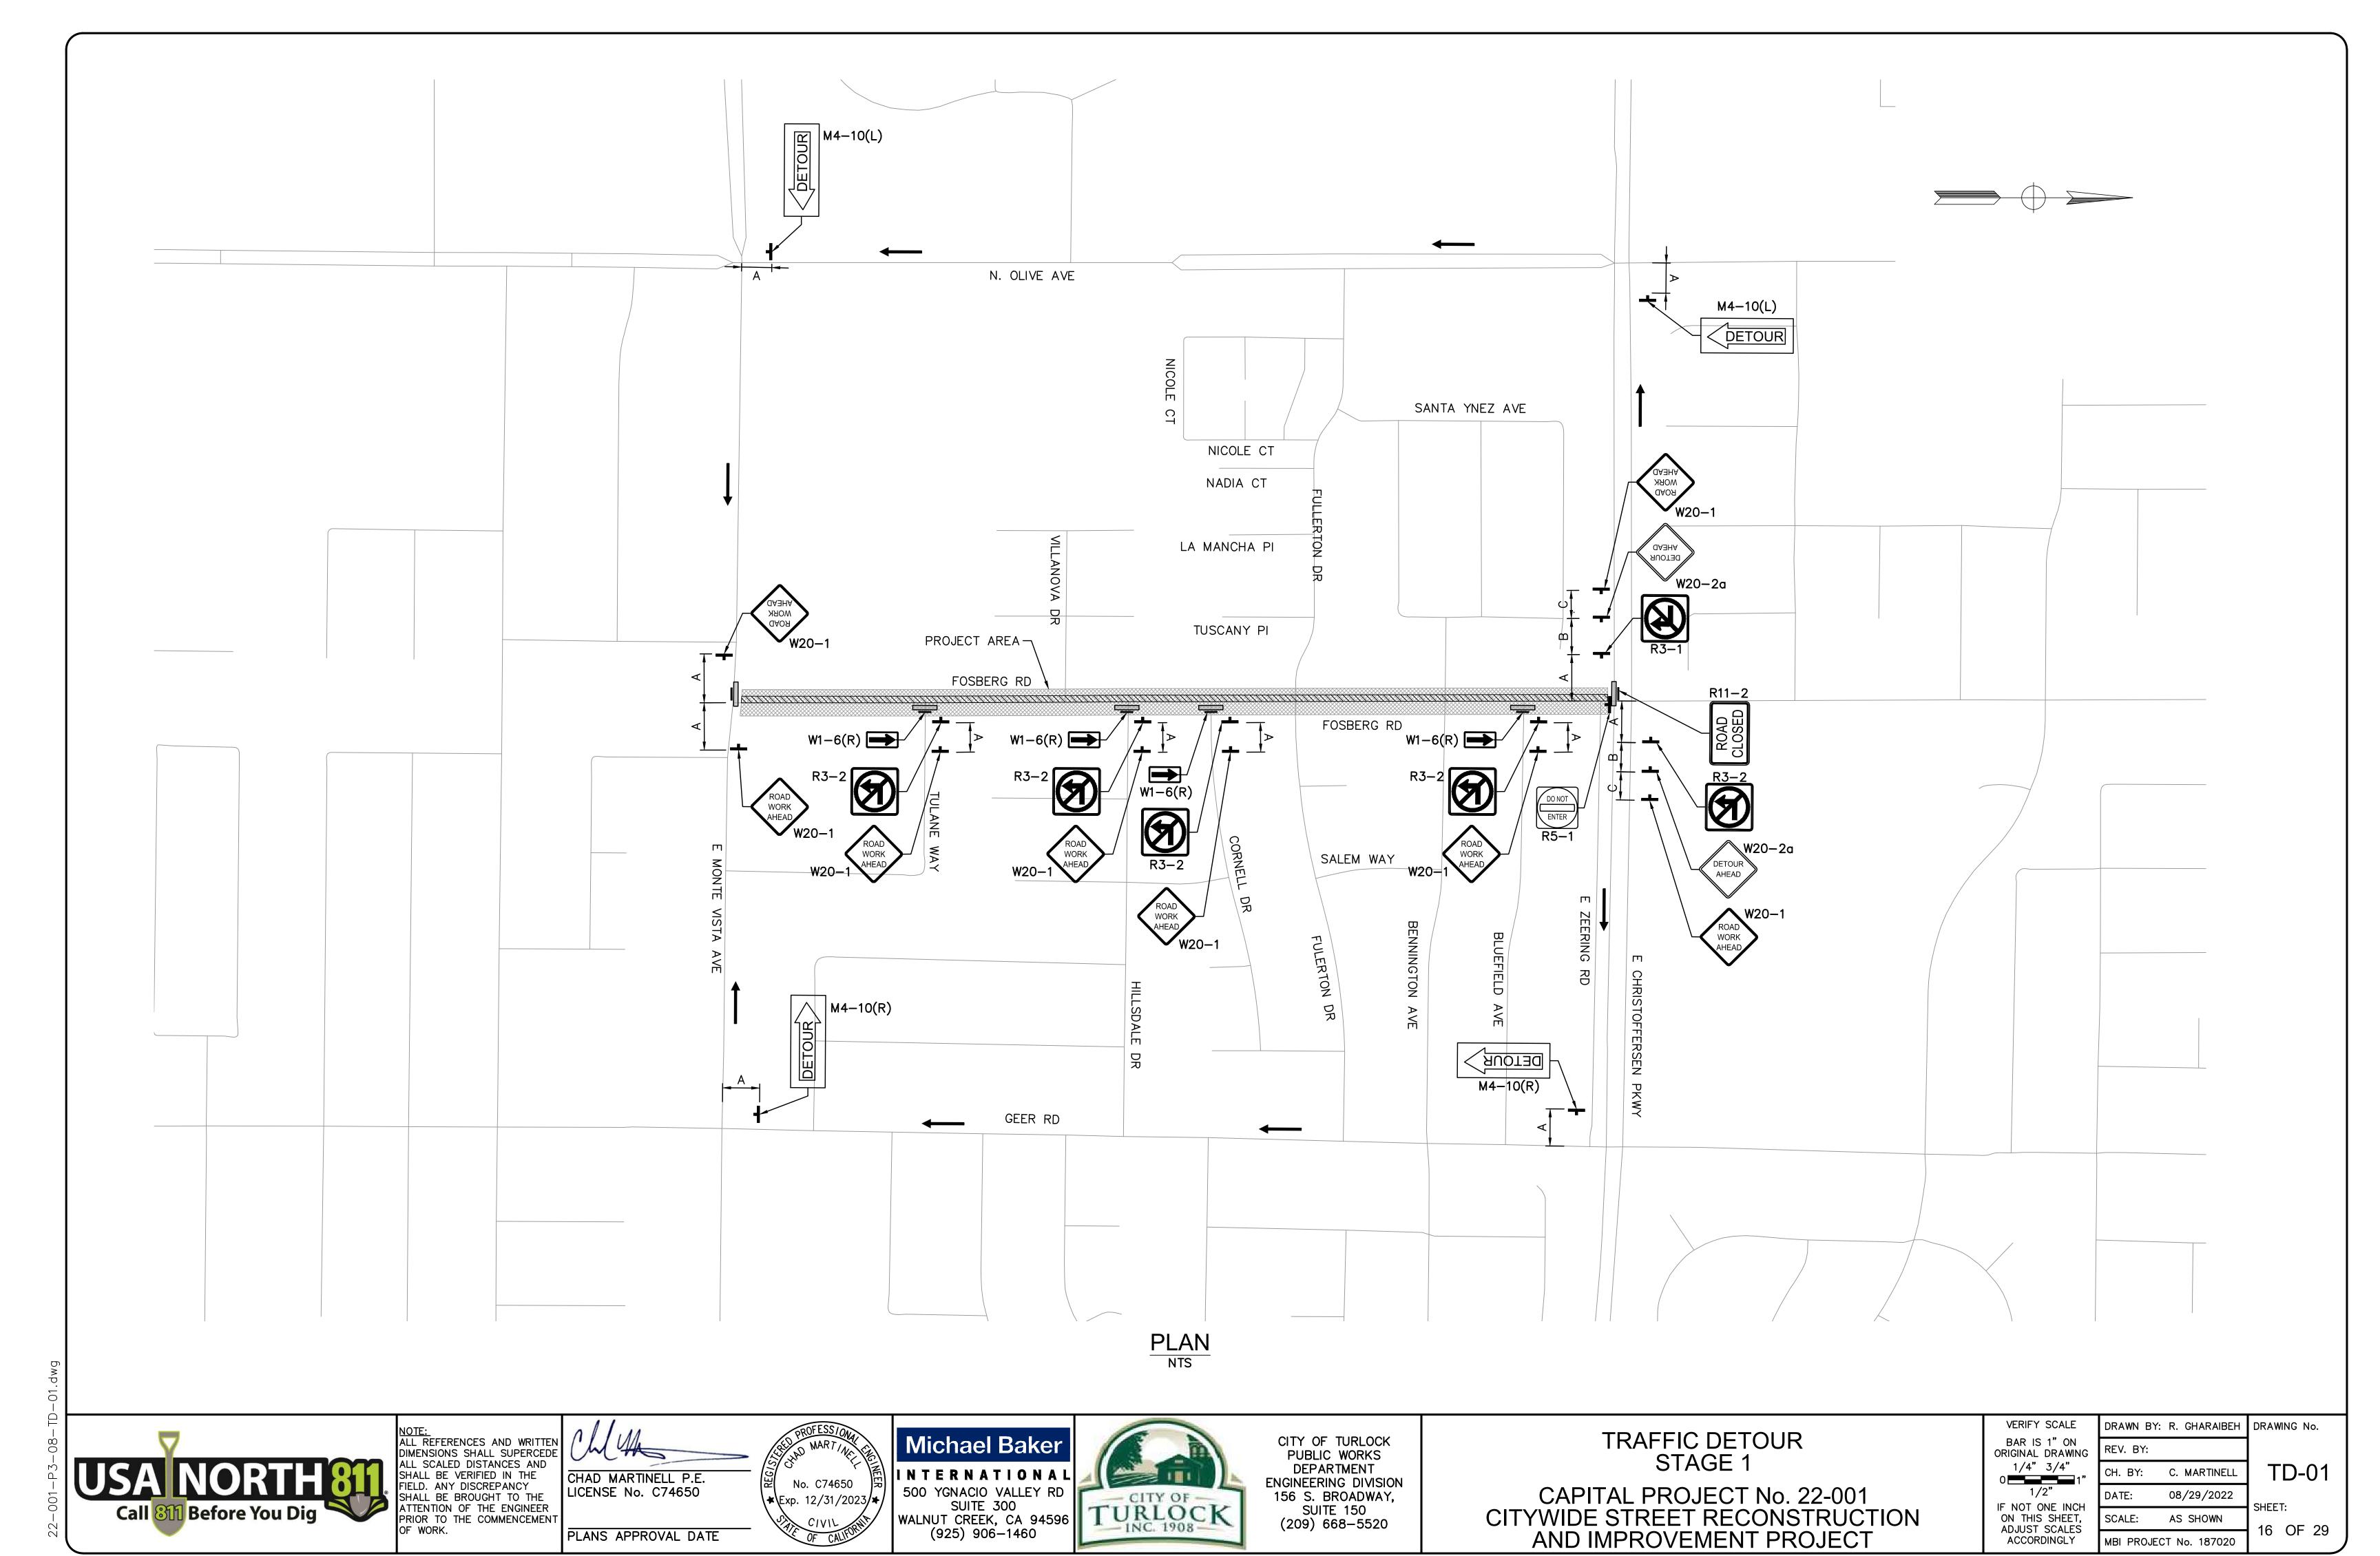
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- 1. INSTALL LIMIT LINE (STOP LINE) PER CALTRANS STANDARD PLAN RSP A24G.
- 2. INSTALL "STOP" MARKING PER CALTRANS STANDARD PLAN A24D.
- 3. REMOVE EXISTING STRIPING BY SANDBLASTING AND REPLACE WITH DETAIL 22 PER CALTRANS STANDARD PLAN A20A.
- 4. REMOVE EXISTING PAVEMENT MARKING BY SANDBLASTING.
- 5. PAINT RED CURB.
- 6. REMOVE EXISTING STREET NAME SIGN PANEL FROM STREET LIGHT POLE. INSTALL STREET NAME SIGN PANELS PER STANDARD ST-12 ON REPLACED/RELOCATED STREET LIGHT POLE.

- STRIPING DETAIL No. PER CALTRANS STANDARD PLANS A20A THROUGH A20D.
- PAVEMENT MARKING DETAIL
- RED CURB

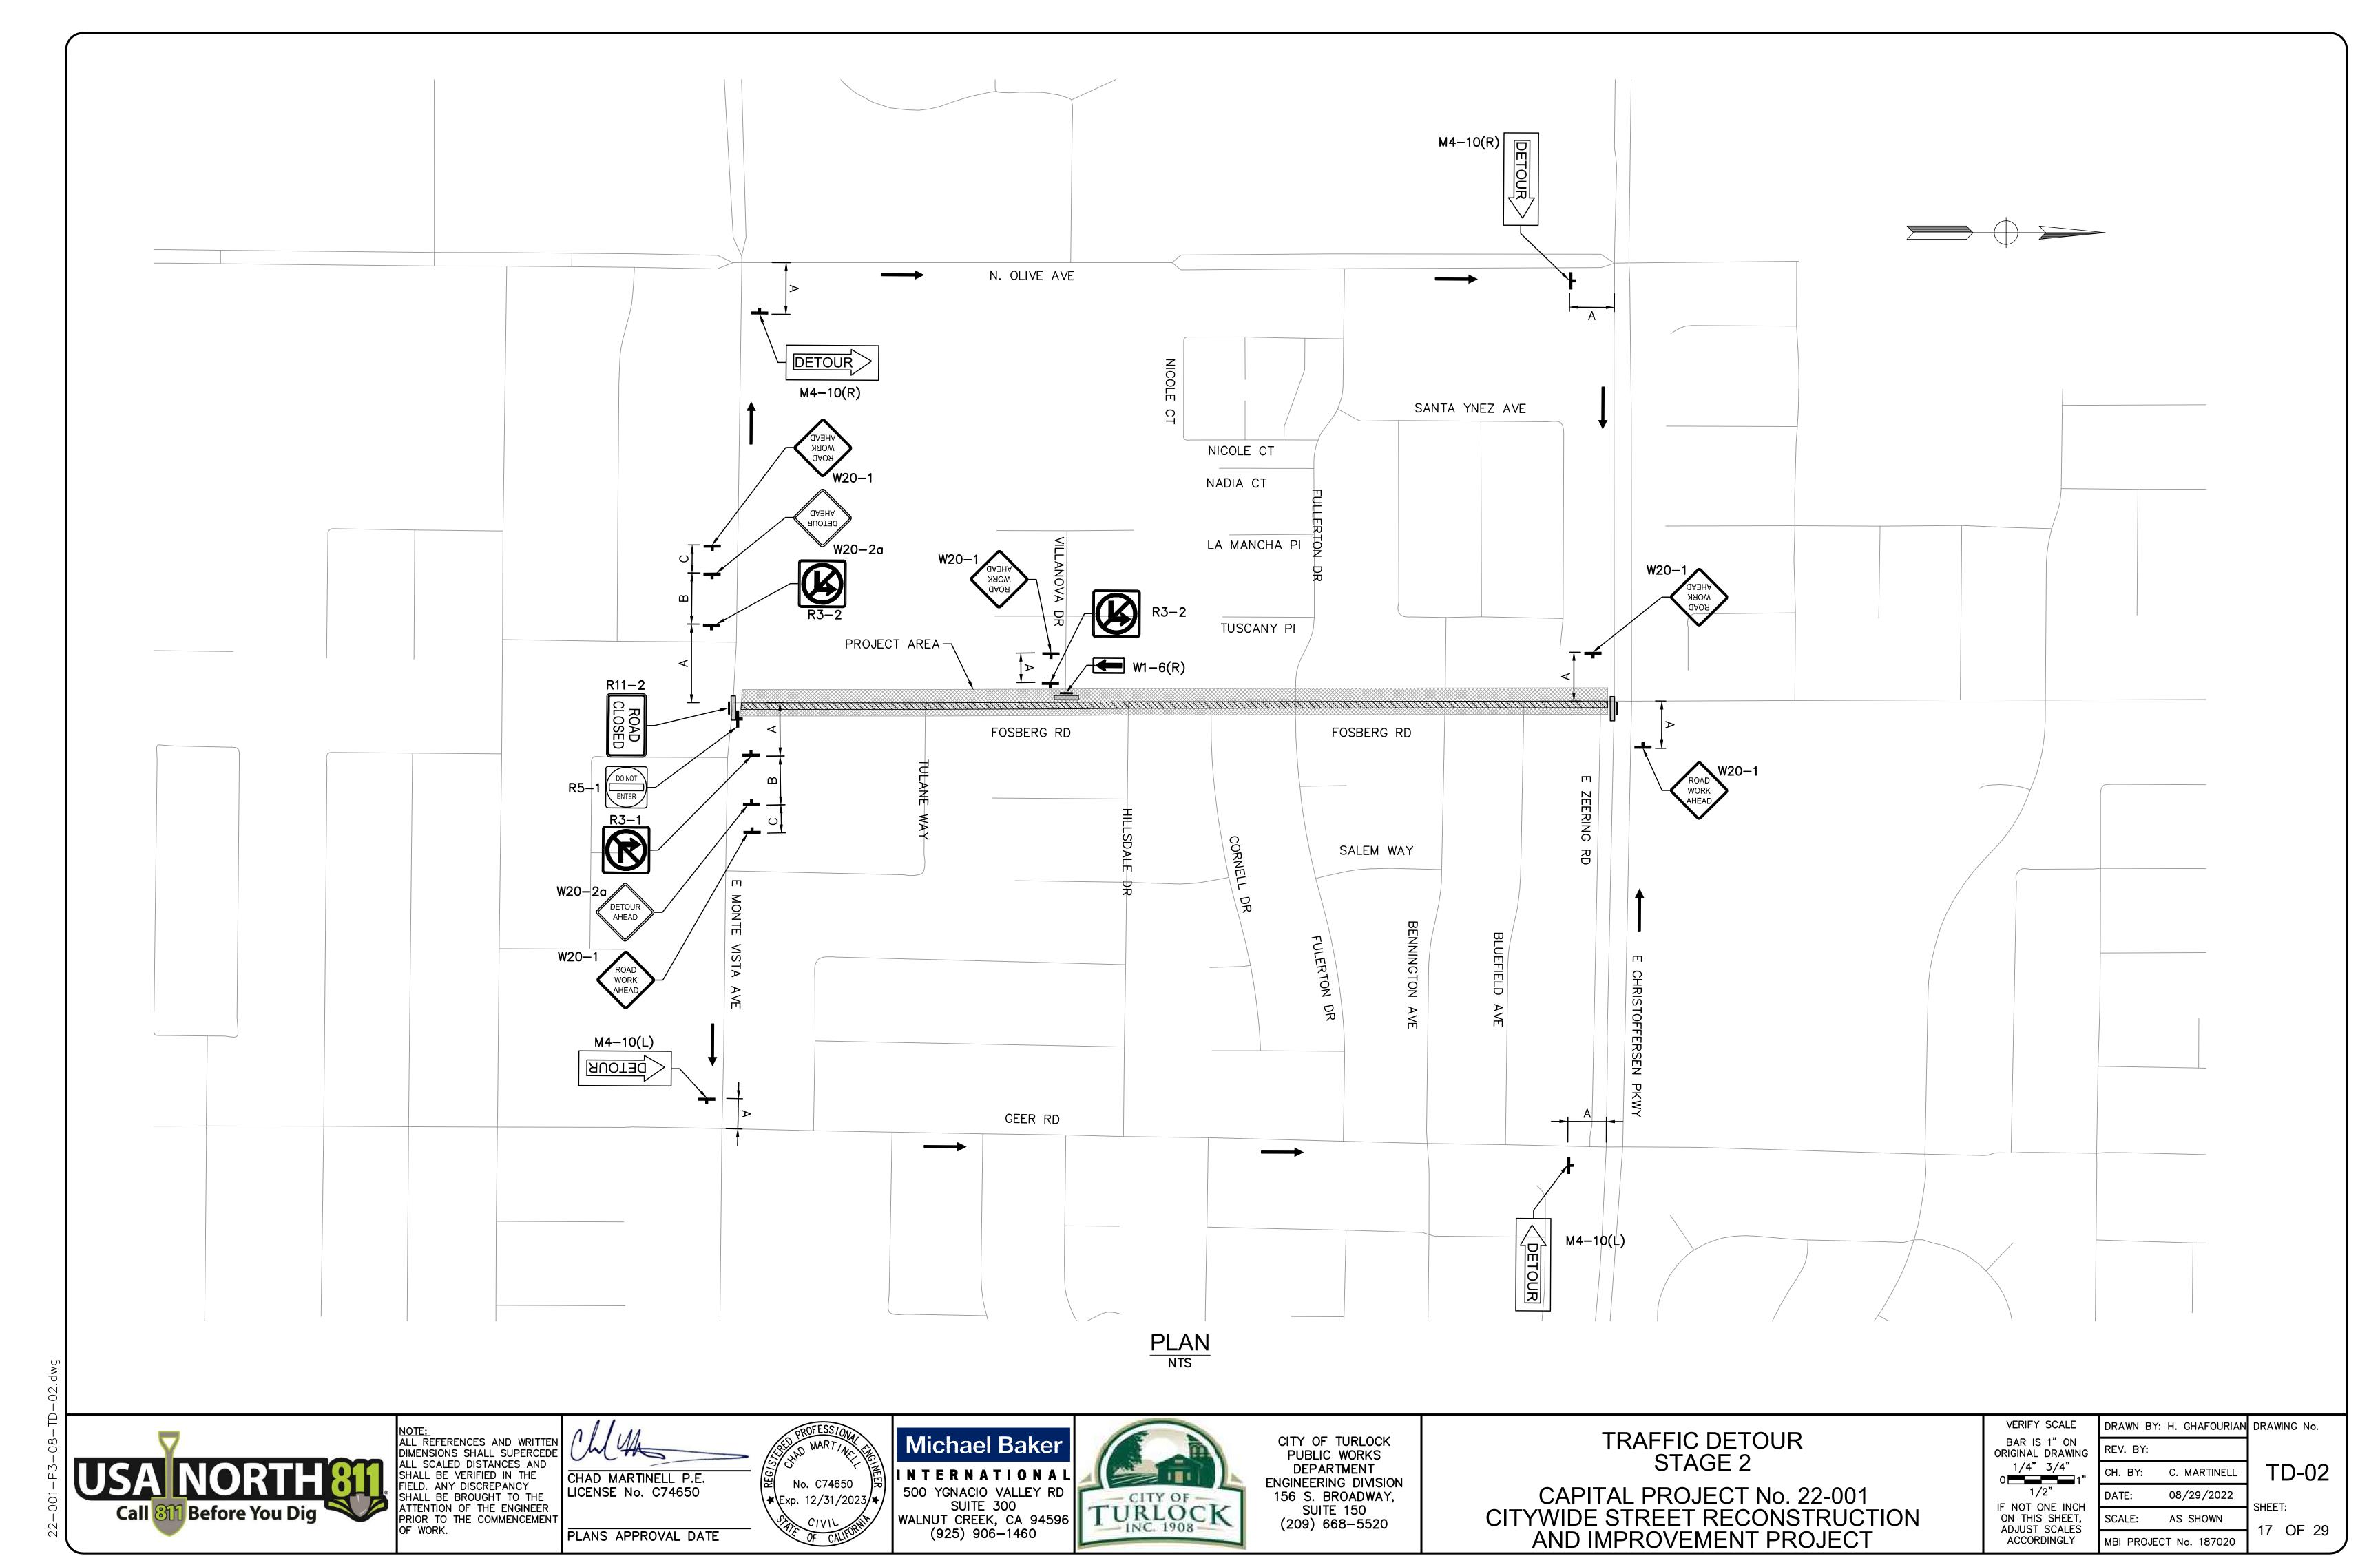LEGEND:



24+00

PLAN 1" = 40'

L=50 FT (22




NOTE:
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ATTENTION OF THE ENGINEER
PRIOR TO THE COMMENCEMENT

22)

) L=50 FT

19+00 18.5' +66

3440

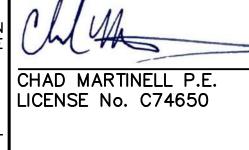

PLANS APPROVAL DATE

"FB" LINE 21+00


₱ FOSBERG RD



FOSBERG RD

HILLSDALE®
SEE NOTE 6

22+00

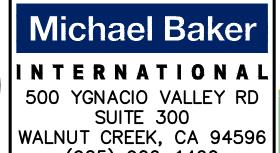

(925) 906-1460

PM

 $\left(\begin{array}{c}22\end{array}\right)$

23+00

SEE NOTE 5

PROTECT IN PLACE
EXISTING R1-1 SIGN PANEL

PM LIMIT LINE (STOP LINE),
SEE NOTE 1, L=18 FT

L=24.5 FT

"STOP", SEE NOTE 2



CITY OF TURLOCK PUBLIC WORKS DEPARTMENT ENGINEERING DIVISION 156 S. BROADWAY, SUITE 150 (209) 668-5520

(22)

25+00

RC

SIGNING AND STRIPING PLAN FOSBERG ROAD

26+₀00

L=50 FT (22)

L=17 FT, RC
SEE NOTE 5

L=24 FT (22)

<u>+87</u>

L=17 FT, SEE NOTE 5

PROTECT IN PLACE
EXISTING R1-1
SIGN PANEL SE

(PM) "STOP", SEE NOTE 2

L=23.5 FT

L=17 FT, SEE NOTE 5

SEE NOTE 1, L=18 FT

CAPITAL PROJECT No. 22-001 CITYWIDE STREET RECONSTRUCTION AND IMPROVEMENT PROJECT

VERIFY SCALE
BAR IS 1" ON ORIGINAL DRAWING
1/4" 3/4"
0 1"
1/2"
• / –
IF NOT ONE INCH
IF NOT ONE INCH ON THIS SHEET,
IF NOT ONE INCH

ACCORDINGLY

₂₈₊₀₀ 18.5'

SEE NOTE 6
PROTECT IN PLACE
EXISTING R1-1 SIGN
PANEL

18.5

) L=17 FT, SEE NOTE 5

L=17 FT, SEE NOTE 5

DIMIT LINE (STOP LINE), SEE NOTE 1, L=23 FT

"STOP", SEE NOTE 2

DRAWN BY: H. GHAFOURIAN DRAWING No. REV. BY: SS-01 CH. BY: C. MARTINELL 08/29/2022 DATE: SHEET: SCALE: AS SHOWN 18 OF 29

- 1. INSTALL LIMIT LINE (STOP LINE) PER CALTRANS STANDARD PLAN RSP A24G.
- 2. INSTALL "STOP" MARKING PER CALTRANS STANDARD PLAN A24D.
- 3. INSTALL CROSSWALK PER STD C-17.
- 4. INSTALL TYPE IV (L) ARROW PER CALTRANS STANDARD PLAN A24A.
- 5. INSTALL TYPE VII (R) ARROW PER CALTRANS STANDARD PLAN A24A.
- 6. INSTALL "30" NUMERAL MARKING PER CALTRANS STANDARD PLAN A24C.
- 7. REMOVE EXISTING CROSSWALK BY SANDBLASTING.
- 8. REMOVE EXISTING PAVEMENT MARKING BY SANDBLASTING.
- 9. PAINT RED CURB.
- 10. REMOVE EXISTING STREET NAME SIGN PANEL FROM STREET LIGHT POLE. INSTALL STREET NAME SIGN PANELS PER STANDARD ST-12 ON REPLACED/RELOCATED STREET LIGHT POLE.


STRIPING DETAIL No. PER CALTRANS STANDARD PLANS A20A THROUGH A20D.


PAVEMENT MARKING DETAIL

RED CURB

LEGEND:

BIKE LOOP DETECTOR

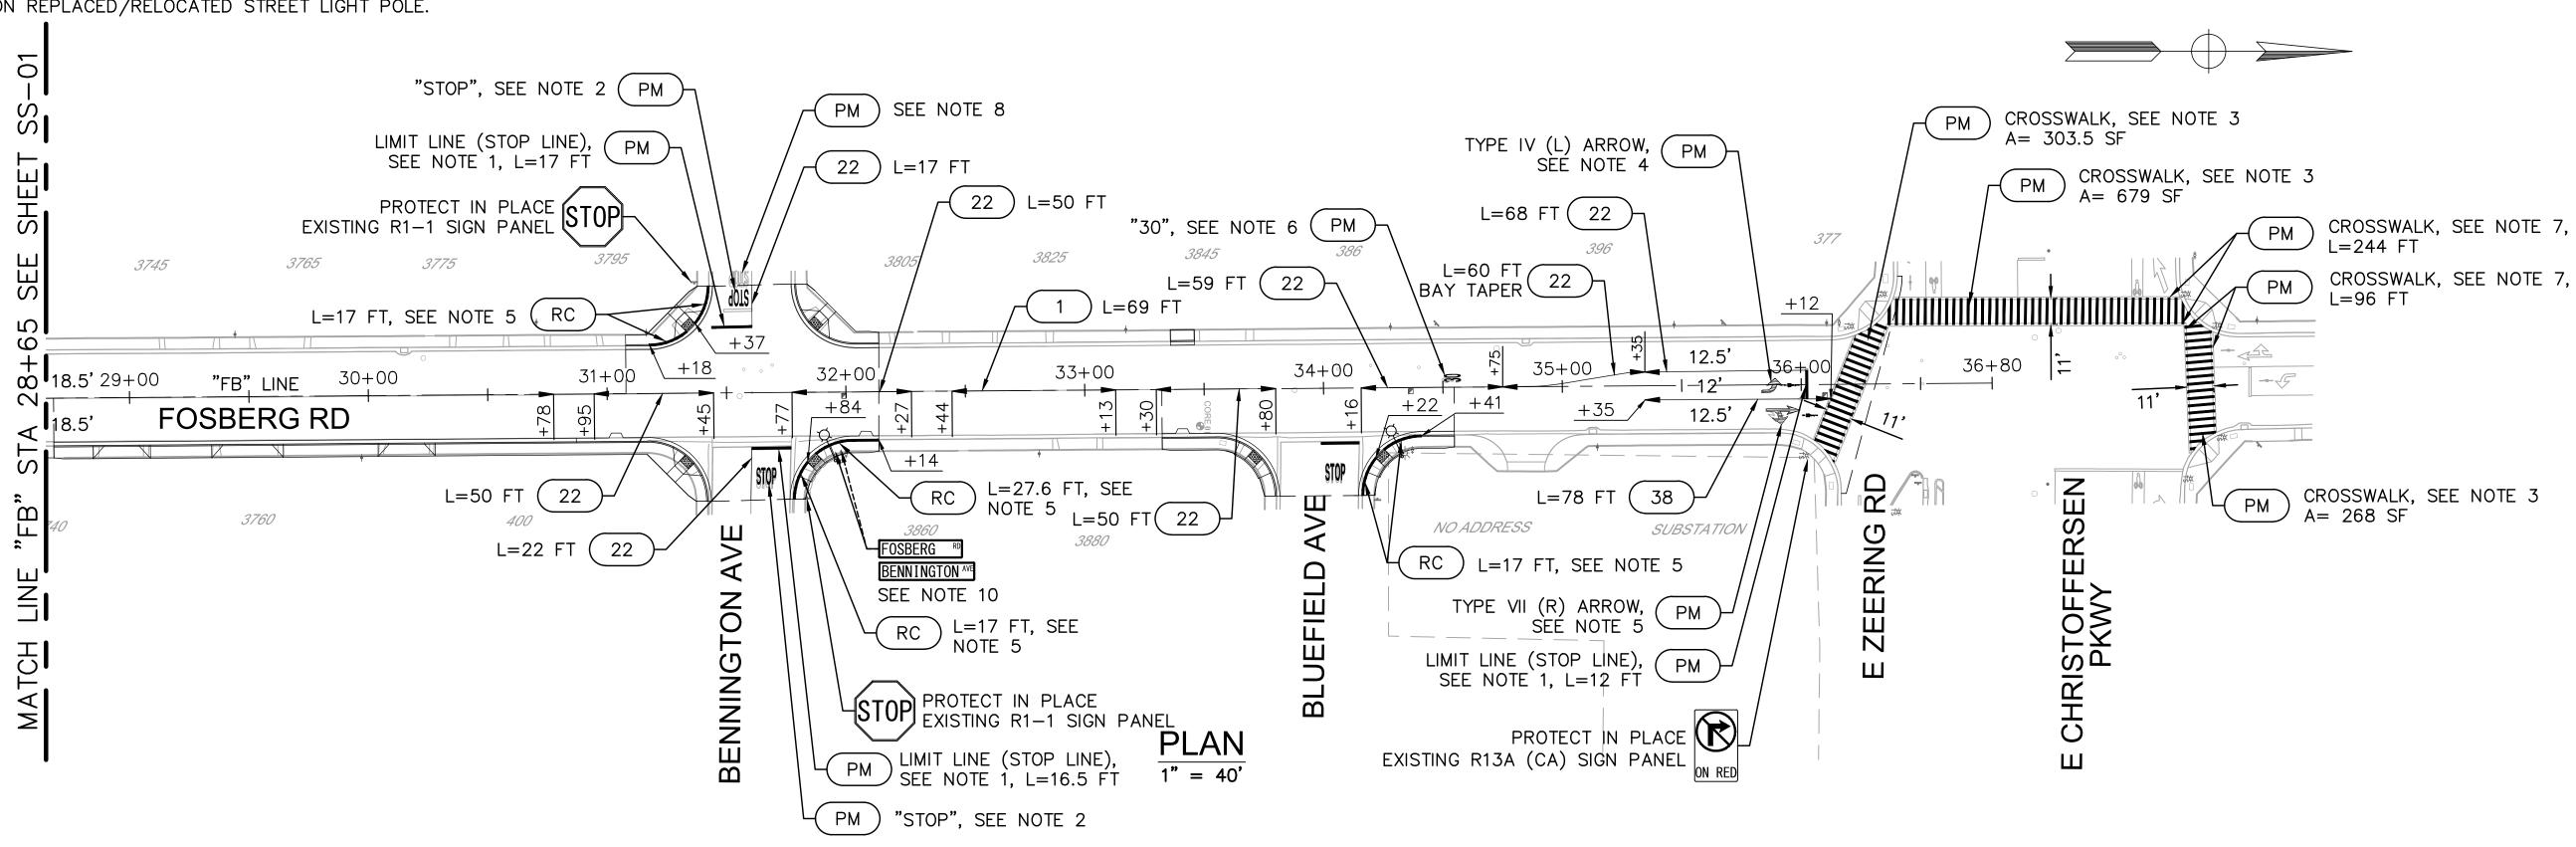

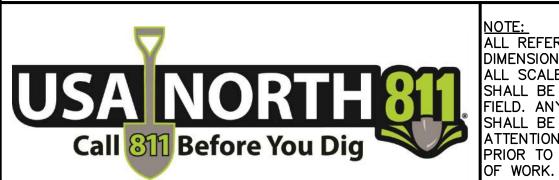


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PRIOR TO THE COMMENCEMENT
OF WORK



PLANS APPROVAL DATE



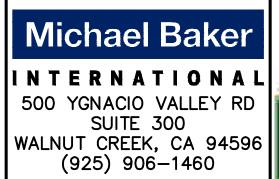



CITY OF TURLOCK PUBLIC WORKS DEPARTMENT ENGINEERING DIVISION 156 S. BROADWAY, SUITE 150 (209) 668-5520


SIGNING AND STRIPING PLAN FOSBERG ROAD


CAPITAL PROJECT No. 22-001 CITYWIDE STREET RECONSTRUCTION AND IMPROVEMENT PROJECT


VERIFY S	CALE
BAR IS 1	
ORIGINAL D	RAWING
1/4" 3	/4"
0	 1"
1/2"	


ACCORDINGLY


DRAWN BY: H. GHAFOURIAN DRAWING No. REV. BY: SS-02 CH. BY: C. MARTINELL 08/29/2022 IF NOT ONE INCH ON THIS SHEET, ADJUST SCALES SHEET: SCALE: AS SHOWN 19 OF 29

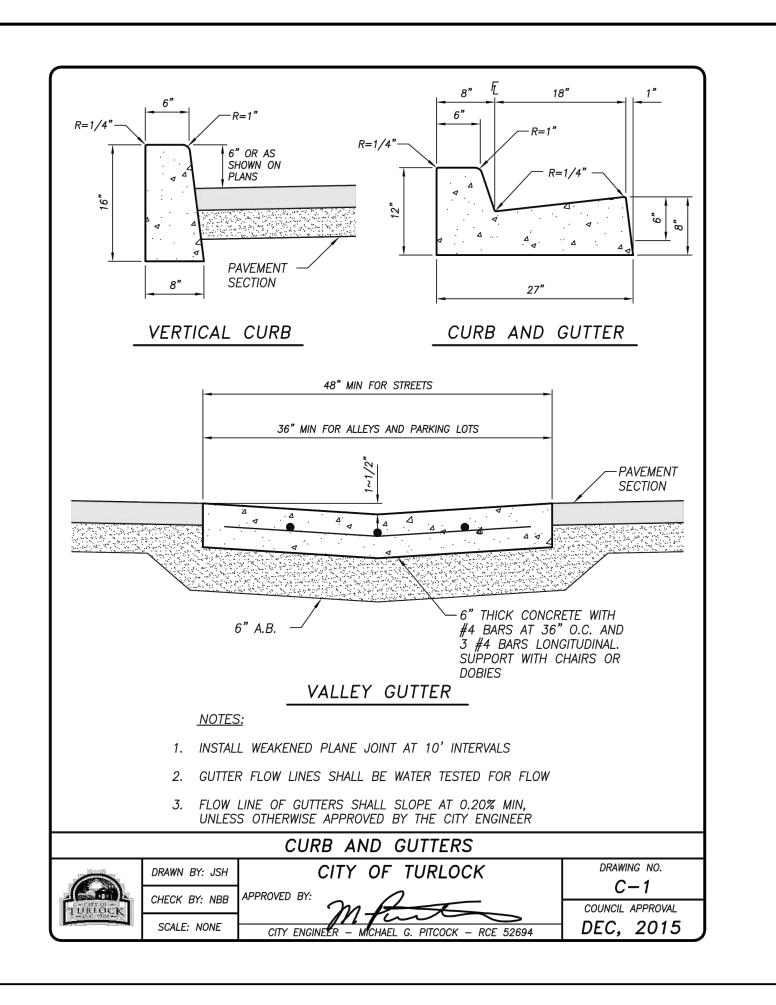


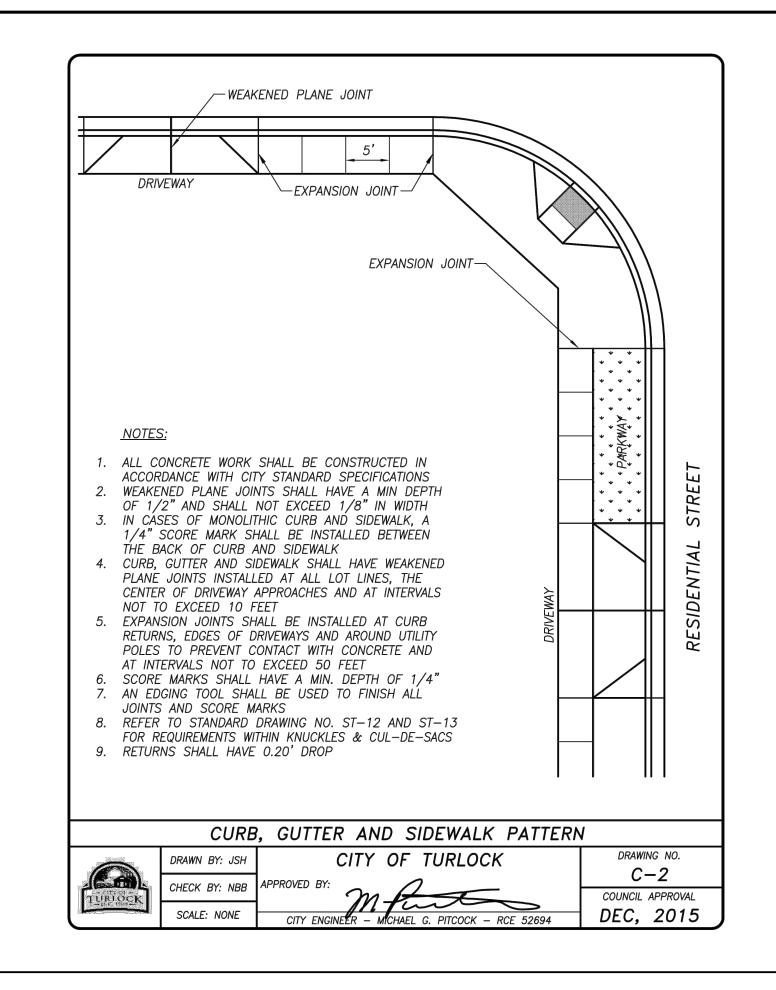


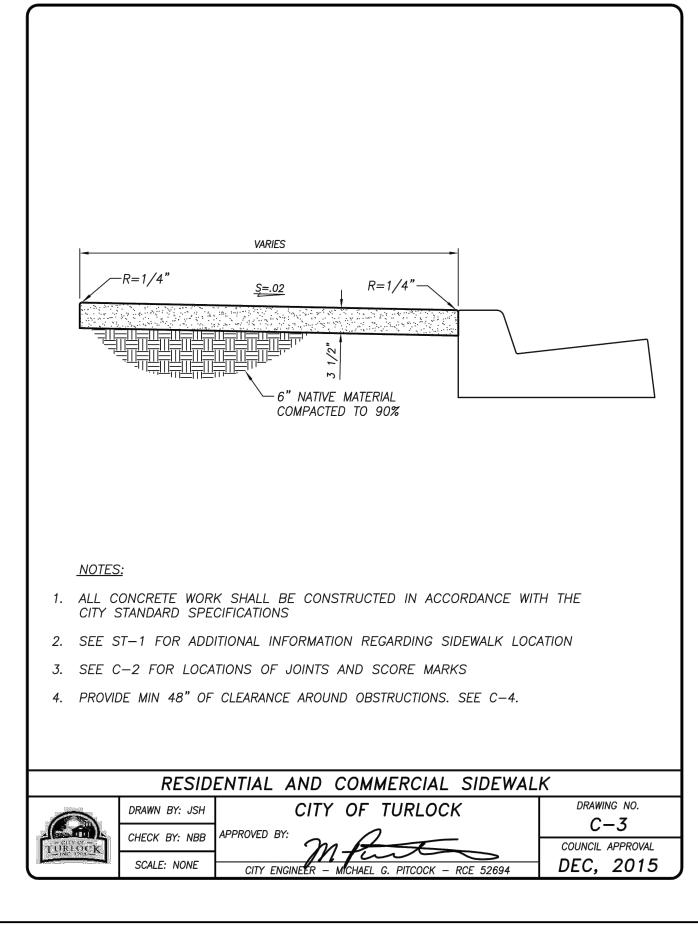


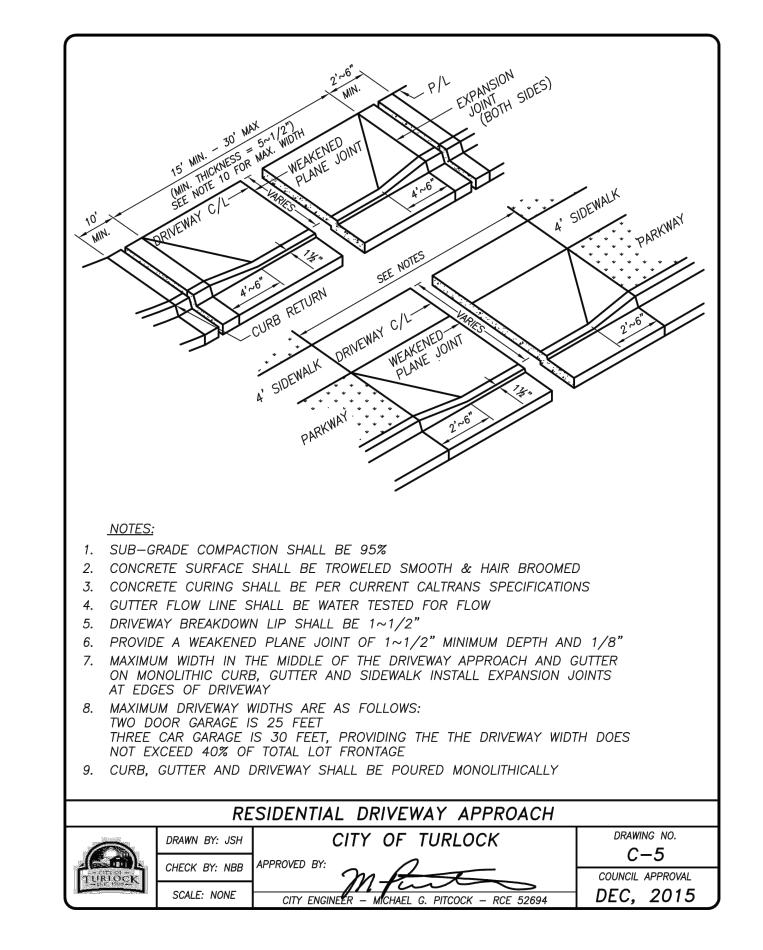

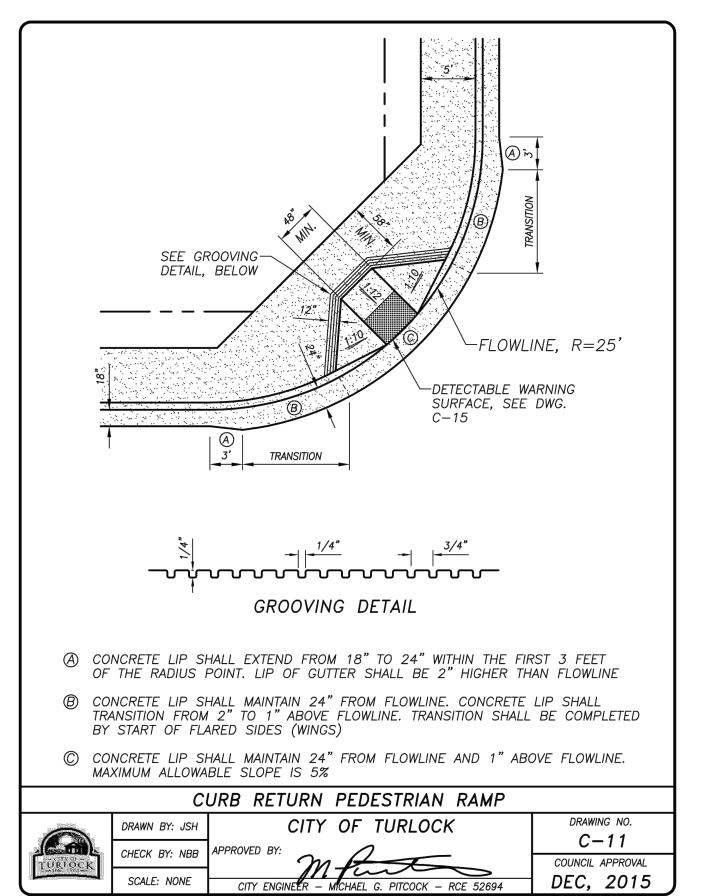

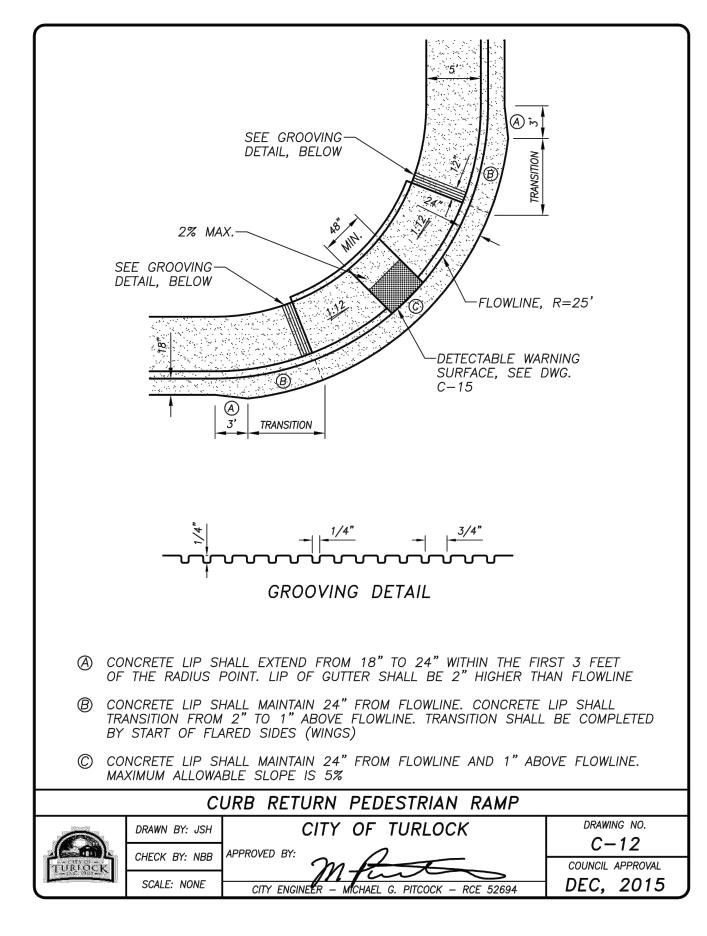

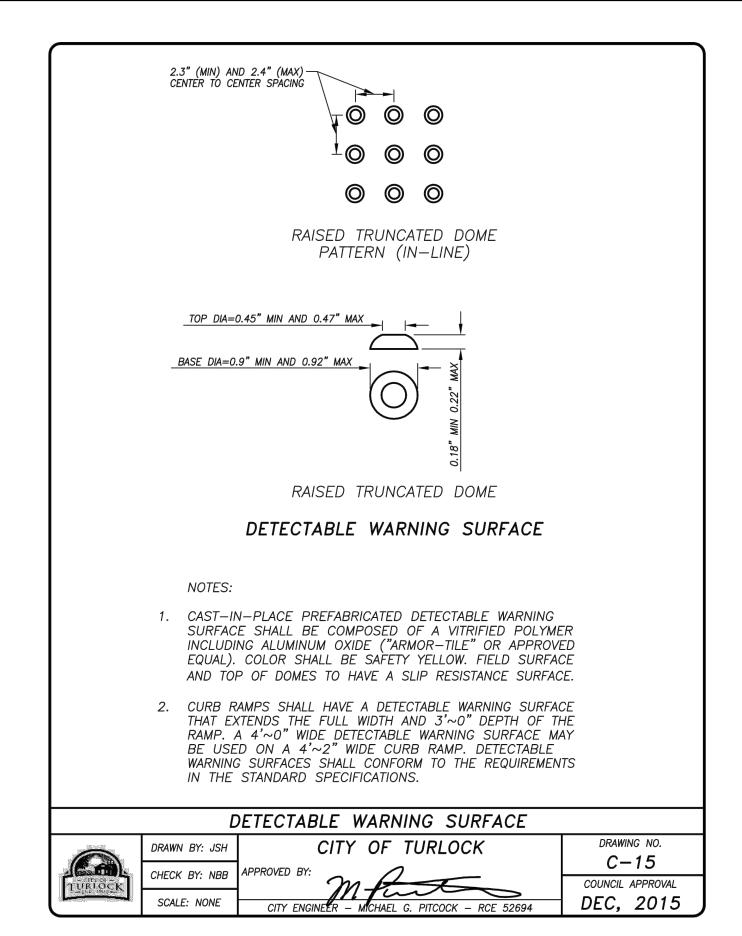


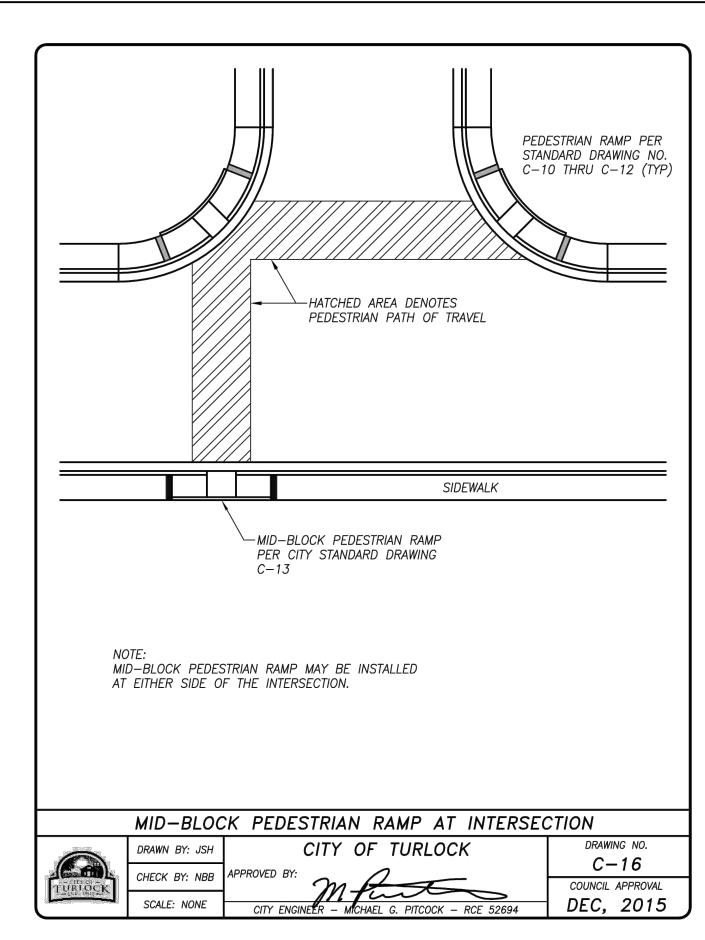

NOT TO SCALE



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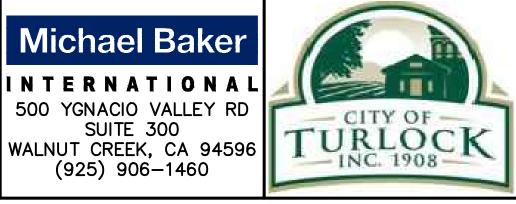


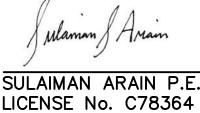PLANS APPROVAL DATE

★\Exp. 9/30/2023



(925) 906-1460




CITY OF TURLOCK PUBLIC WORKS **DEPARTMENT ENGINEERING DIVISION** 156 S. BROADWAY. SUITE 150 (209) 668-5520


CONSTRUCTION DETAILS


CAPITAL PROJECT No. 22-001 CITYWIDE STREET RECONSTRUCTION AND IMPROVEMENT PROJECT


-		
VERIFY SCALE	DRAWN BY:	R. LIM
BAR IS 1" ON ORIGINAL DRAWING	REV. BY:	
1/4" 3/4" 0 1/2" IF NOT ONE INCH ON THIS SHEET, ADJUST SCALES	CH. BY:	S. ARAIN
	DATE:	08/29/2
	SCALE:	AS SHOW
ACCORDINGLY	MBI PROJEC	T No. 187


DRAWING No. CD-01 2022 WN 20 OF 29 MBI PROJECT No. 187020

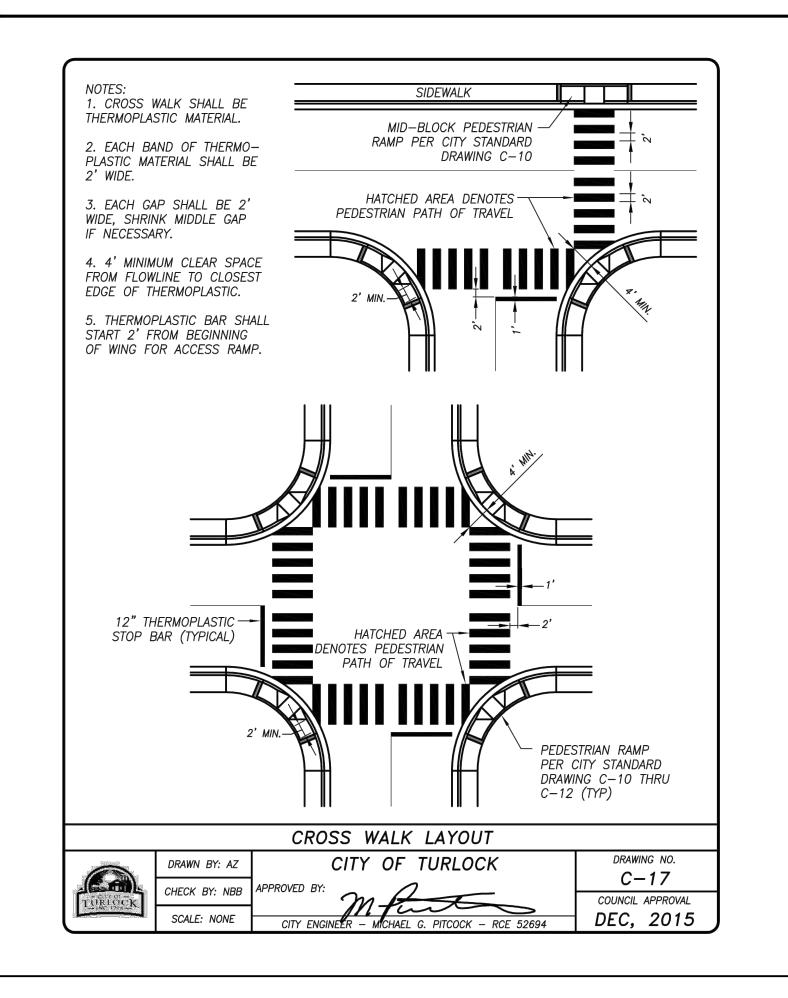


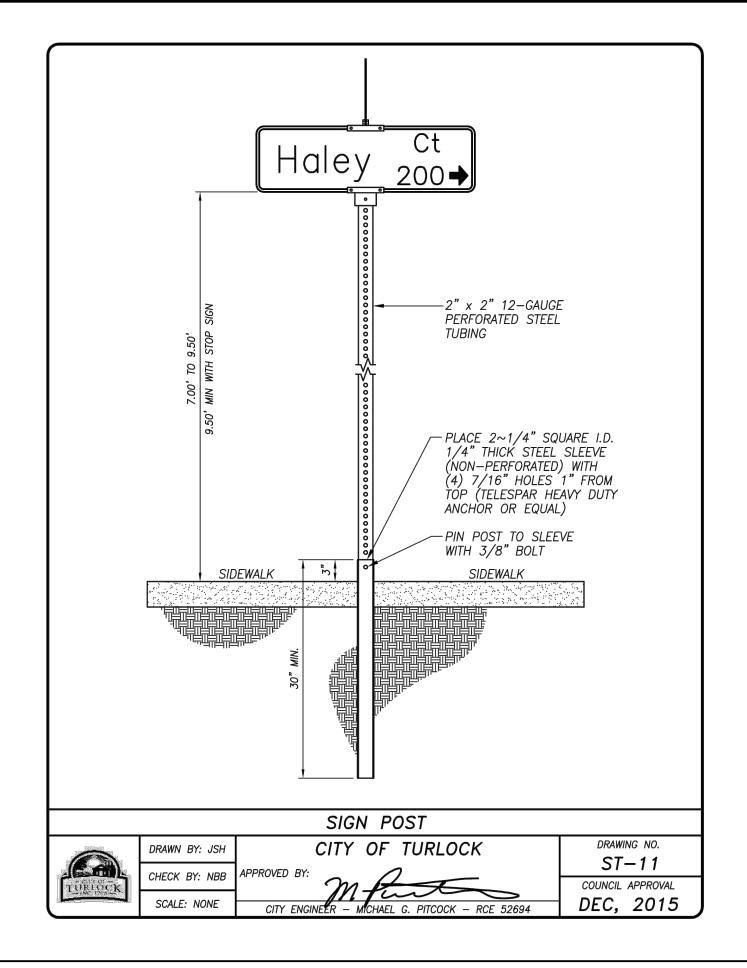


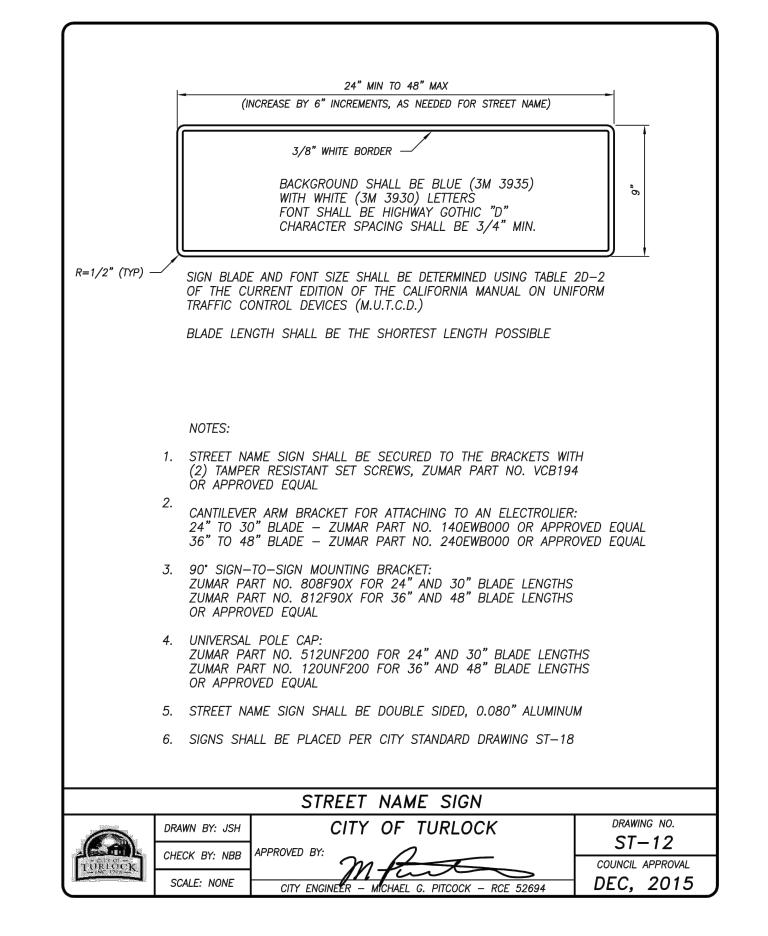


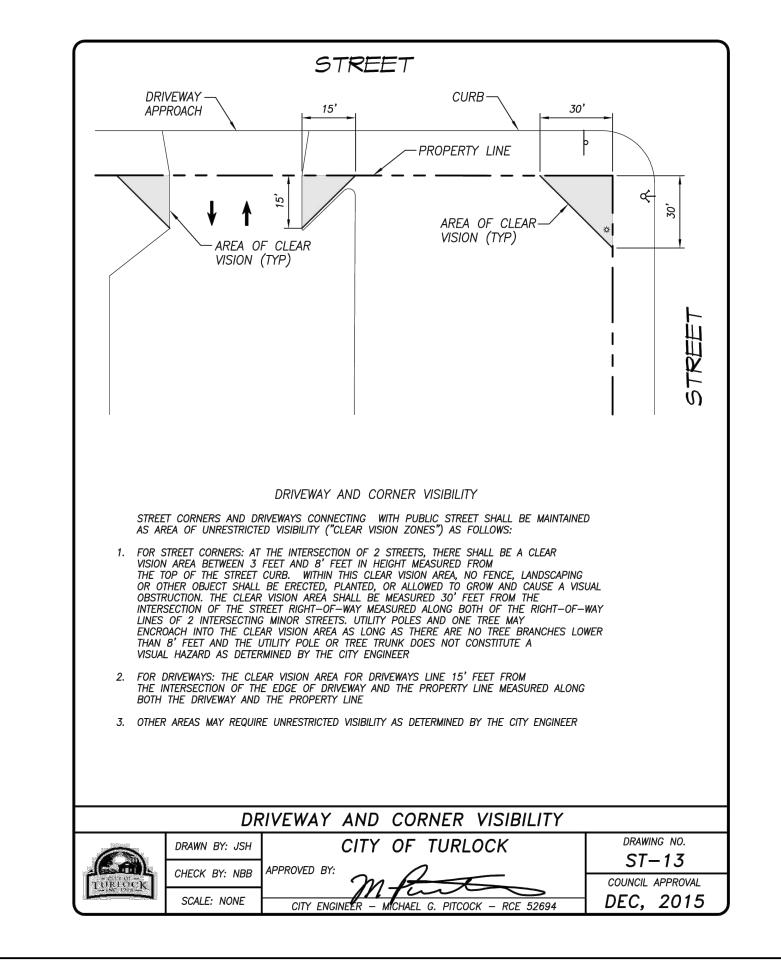


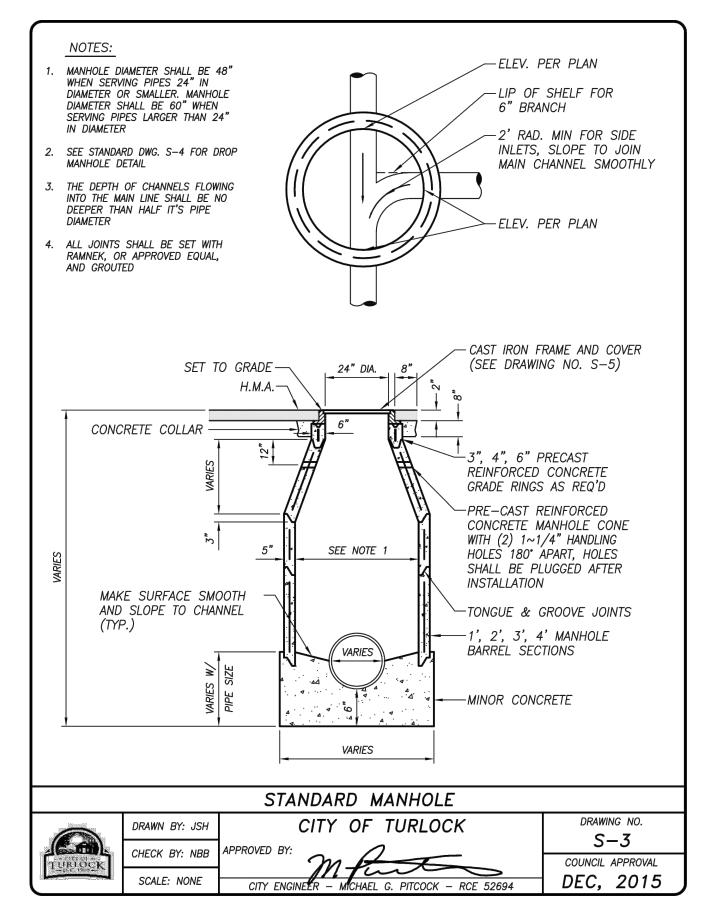

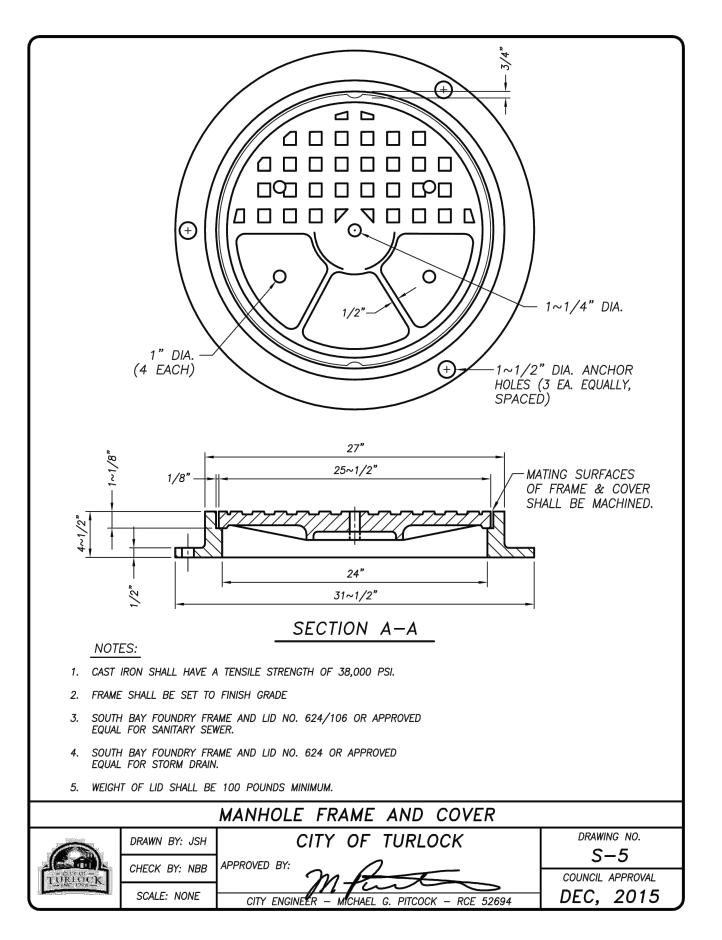

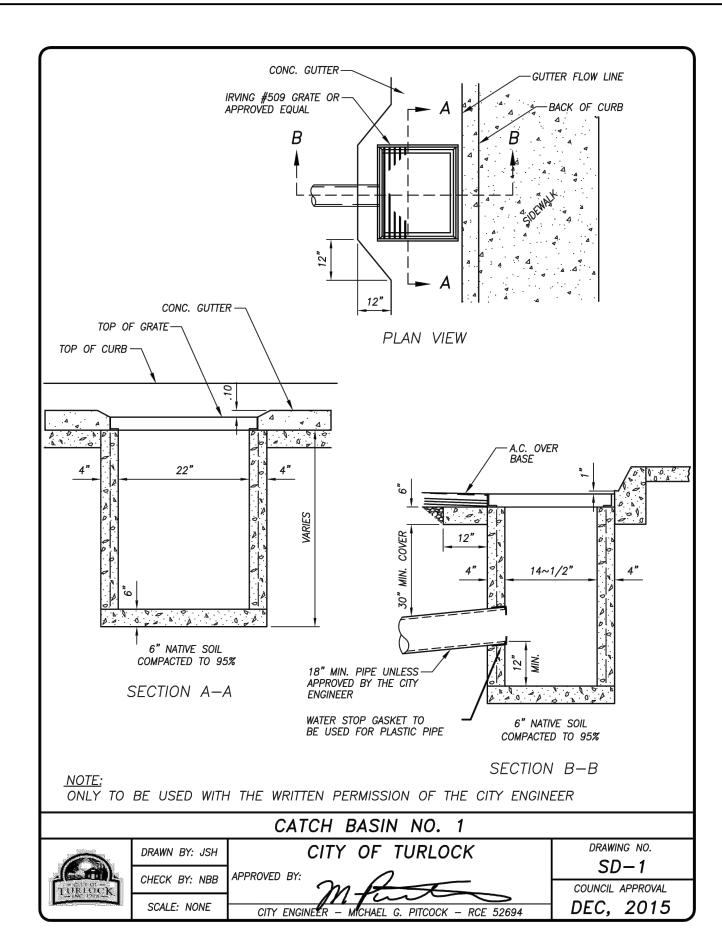

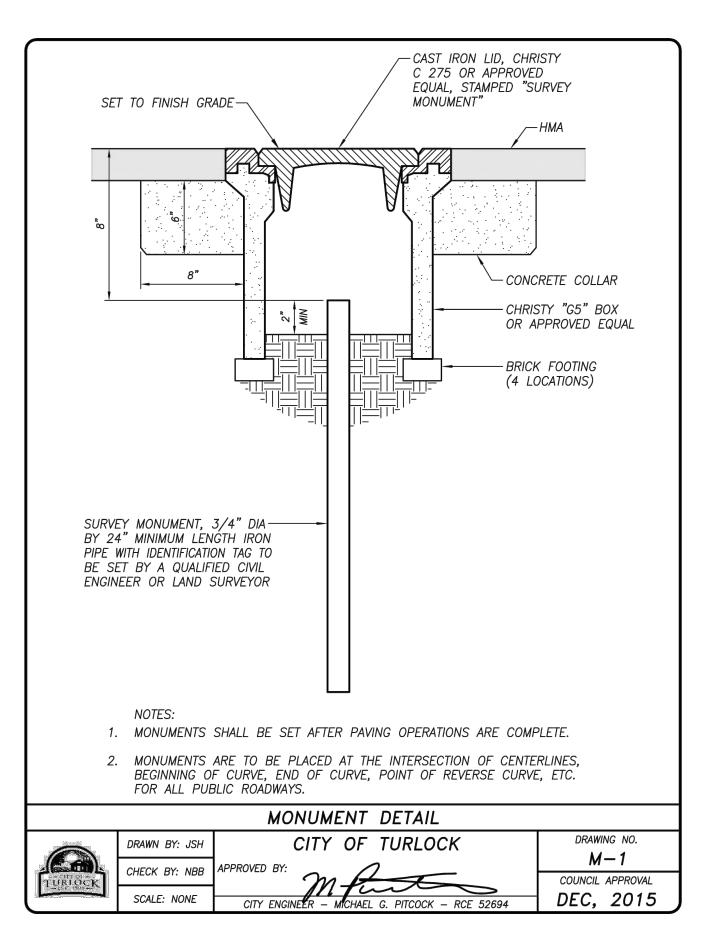

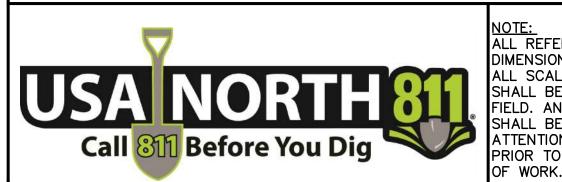


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PLANS APPROVAL DATE

LICENSE No. C78364




Michael Baker 500 YGNACIO VALLEY RD

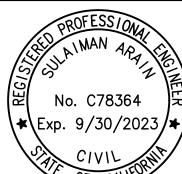SUITE 300

WALNUT CREEK, CA 94596


(925) 906-1460

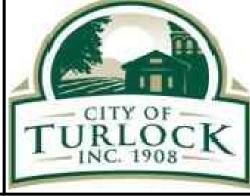

CITY OF TURLOCK PUBLIC WORKS **DEPARTMENT** ENGINEERING DIVISION 156 S. BROADWAY, SUITE 150 (209) 668-5520


CONSTRUCTION DETAILS


CAPITAL PROJECT No. 22-001 CITYWIDE STREET RECONSTRUCTION AND IMPROVEMENT PROJECT

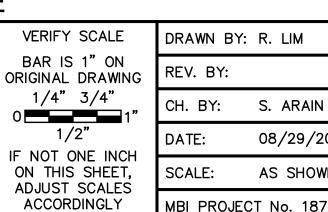



NOT TO SCALE


DRAWING No. CD-02 08/29/2022 SHEET: AS SHOWN 21 OF 29 MBI PROJECT No. 187020

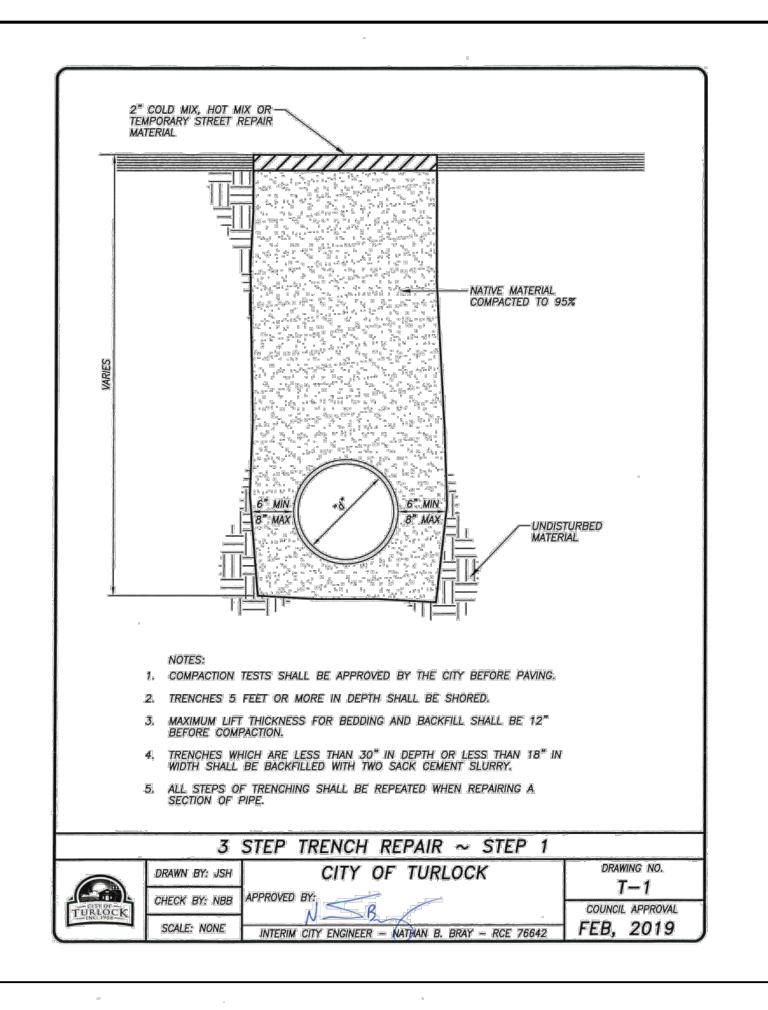


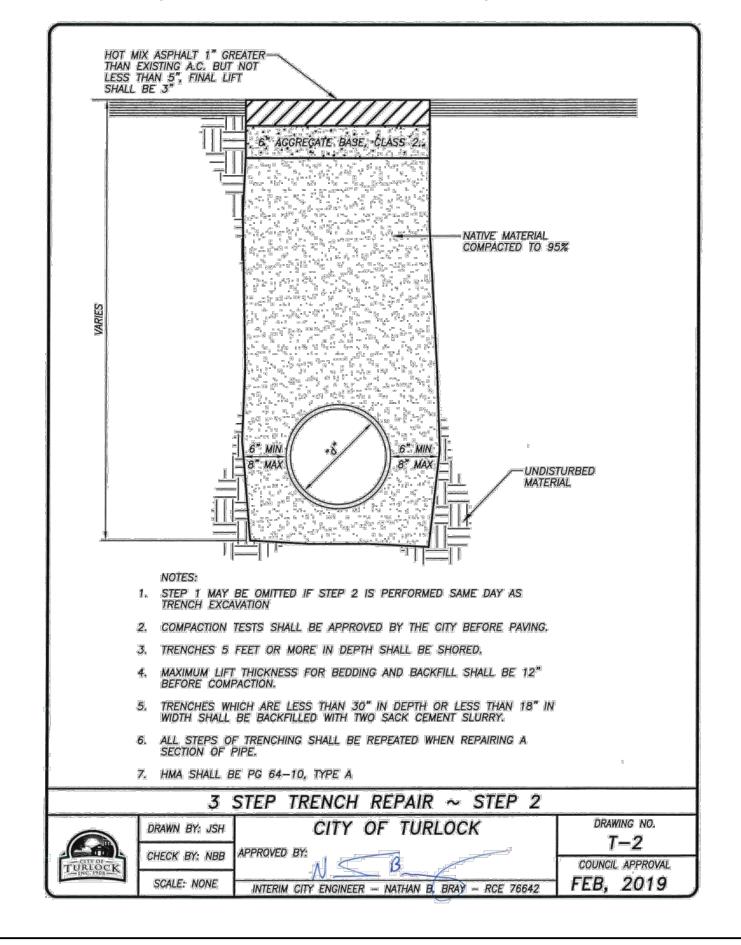


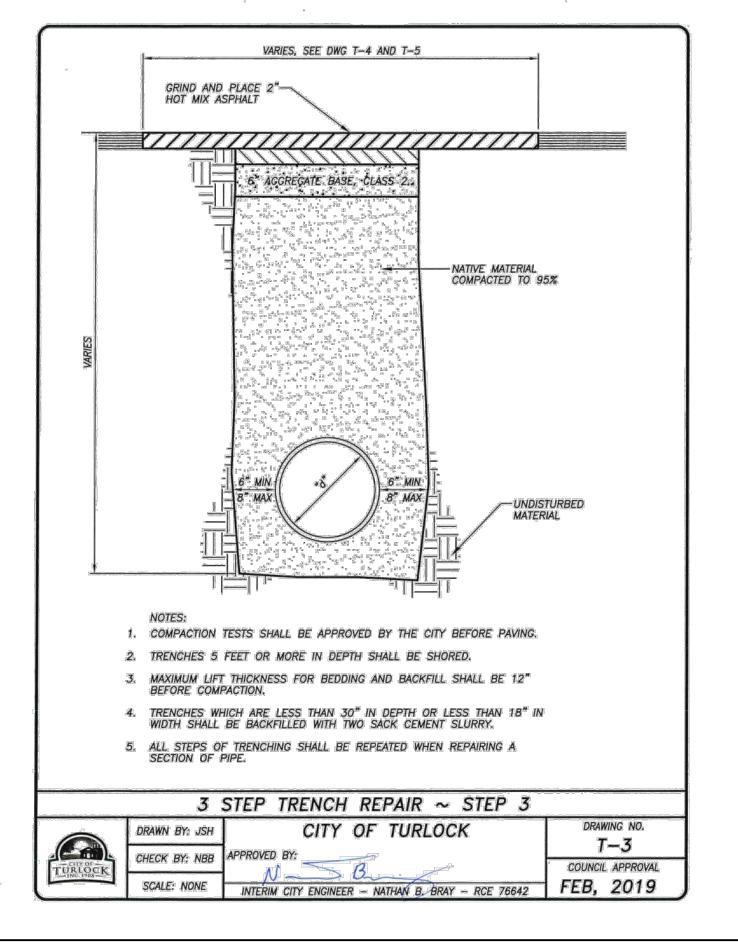


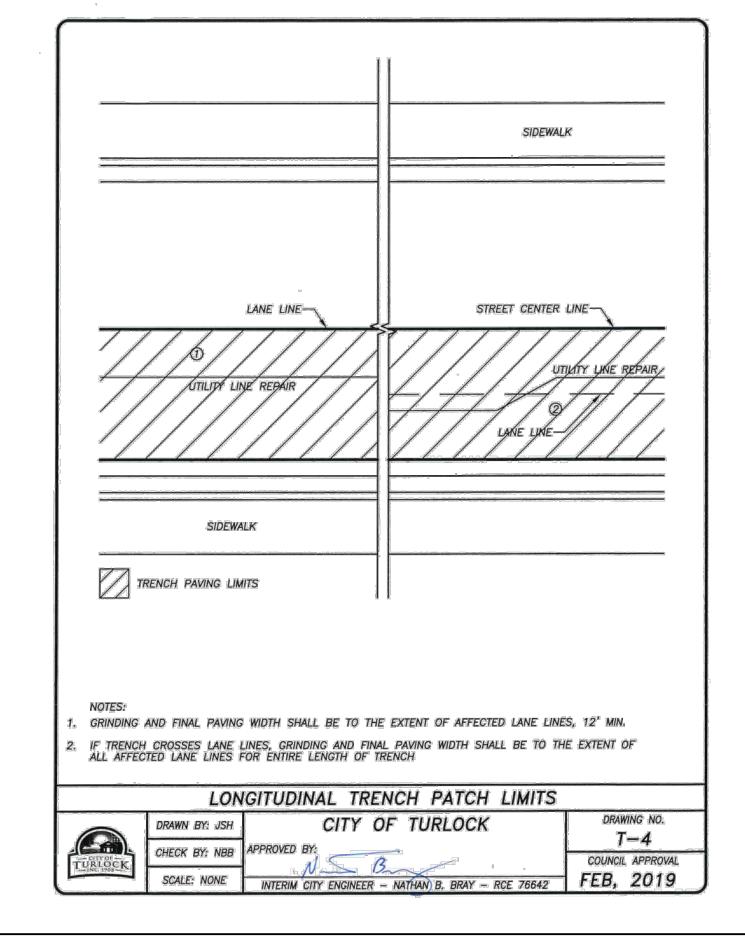

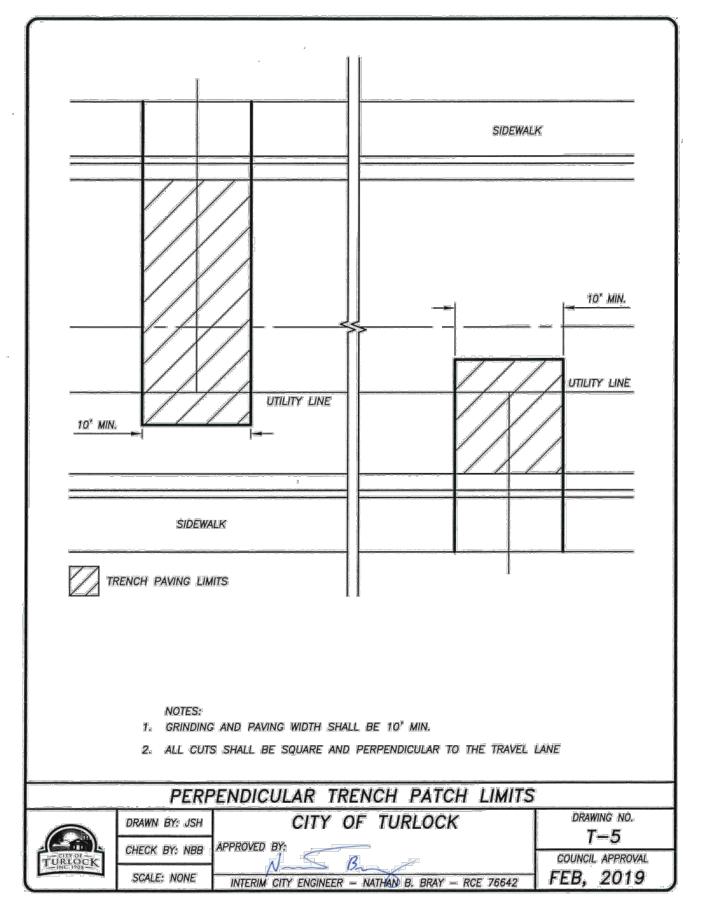

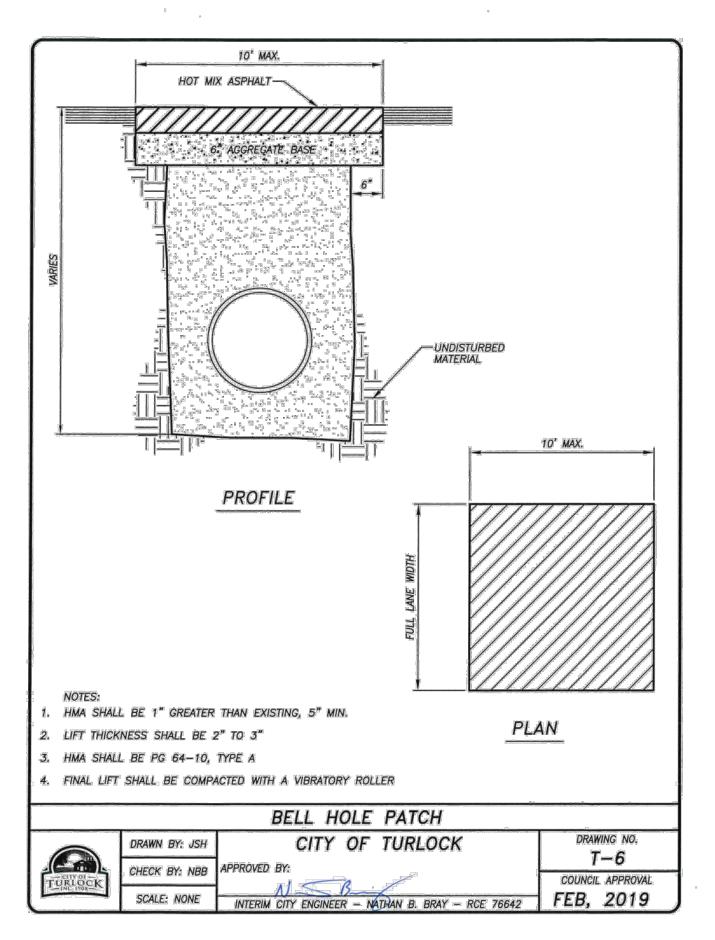

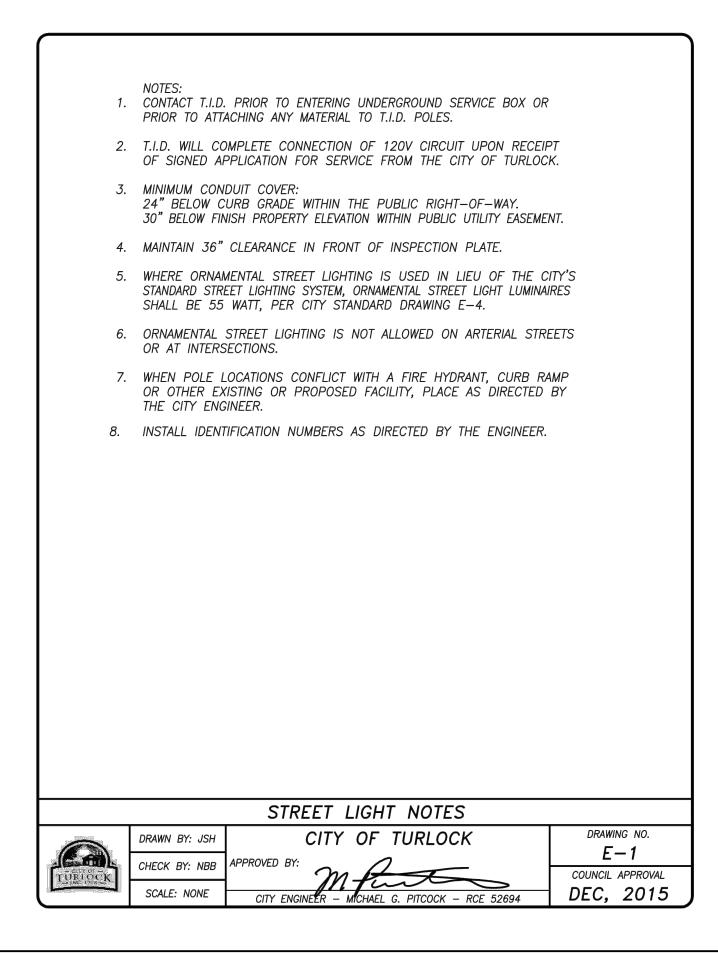

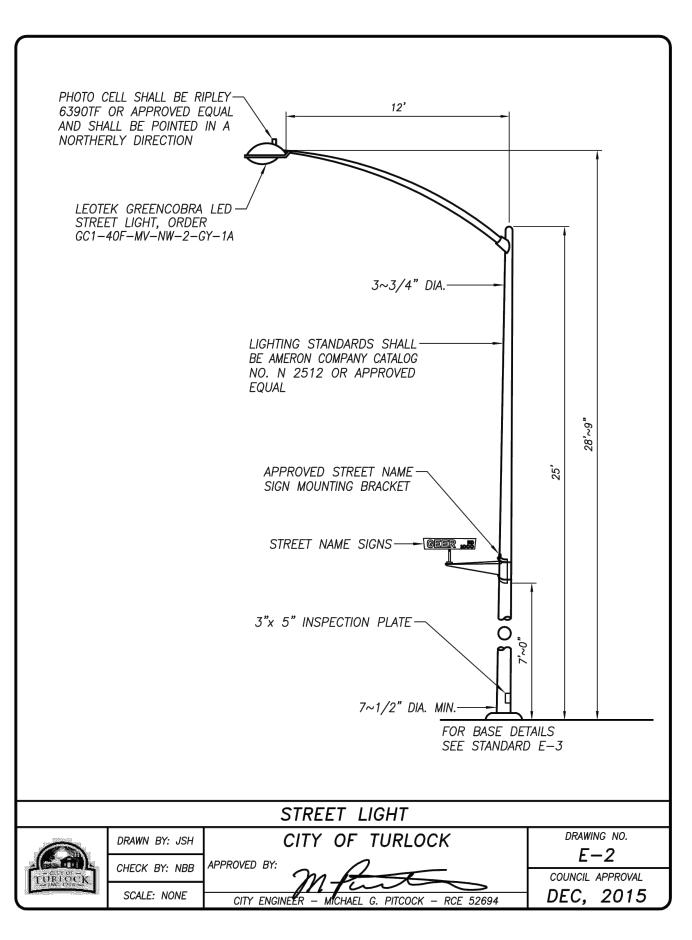




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PRIOR TO THE COMMENCEMENT

SULAIMAN ARAIN P.E. LICENSE No. C78364

PLANS APPROVAL DATE

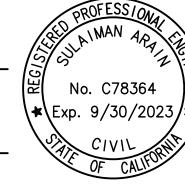

Michael Baker
INTERNATIONAL
500 YGNACIO VALLEY RD

SUITE 300

WALNUT CREEK, CA 94596

(925) 906-1460



CITY OF TURLOCK
PUBLIC WORKS
DEPARTMENT
ENGINEERING DIVISION
156 S. BROADWAY,
SUITE 150
(209) 668-5520

CONSTRUCTION DETAILS

CAPITAL PROJECT No. 22-001 CITYWIDE STREET RECONSTRUCTION AND IMPROVEMENT PROJECT VERIFY SCALE

BAR IS 1" ON
ORIGINAL DRAWING

1/4" 3/4"

CH. BY:

CH. BY:

DATE:

OTHER ON THIS SHEET,
ADJUST SCALES
ACCORDINGLY

DRAWN BY: F

REV. BY:

CH. BY:

SCALE:

MBI PROJECT

NOT TO SCALE

DRAWN BY: R. LIM

REV. BY:

CH. BY: S. ARAIN

DATE: 08/29/2022

SCALE: AS SHOWN


MBI PROJECT No. 187020


DRAWING No.


CD-03


SHEET:


22 OF 29

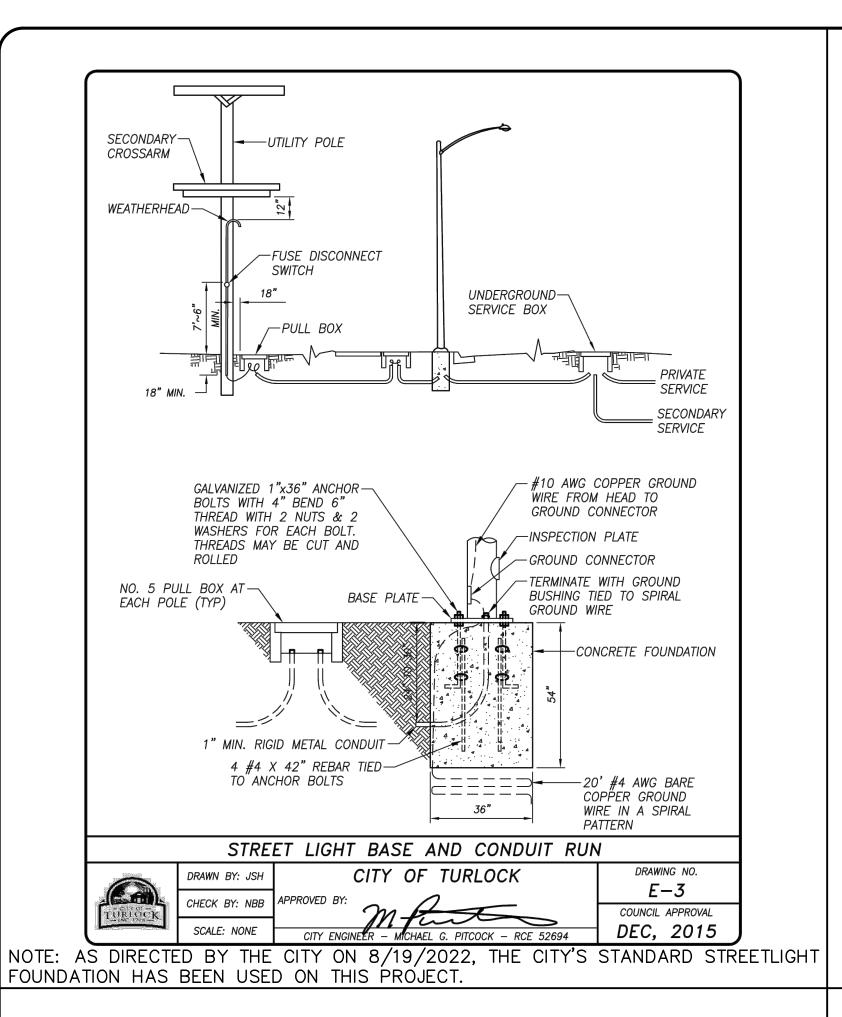


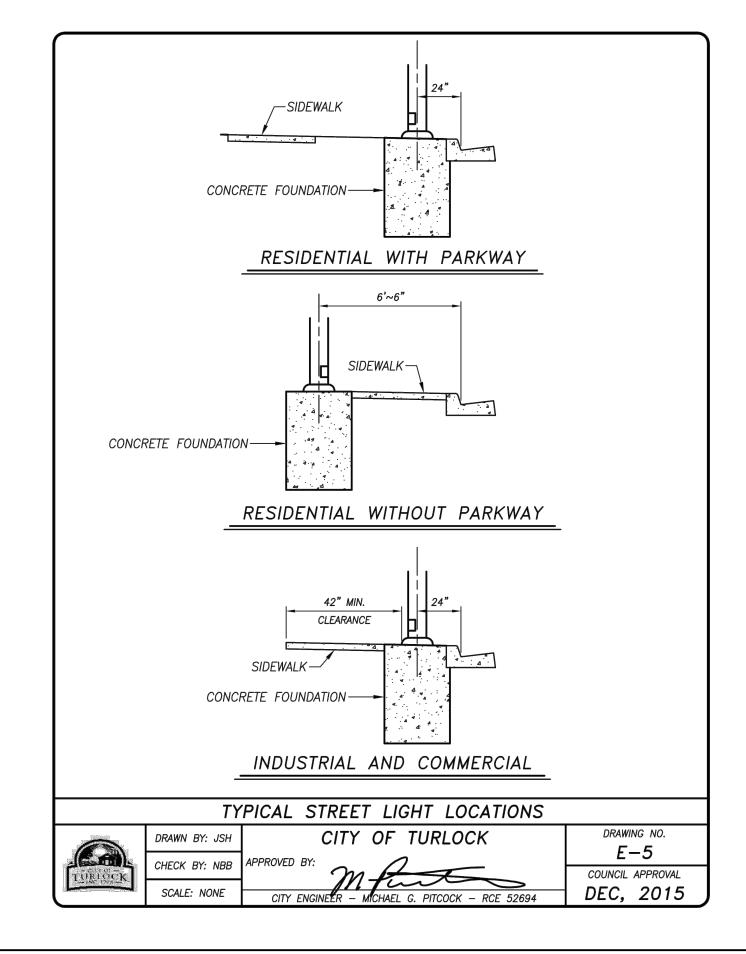


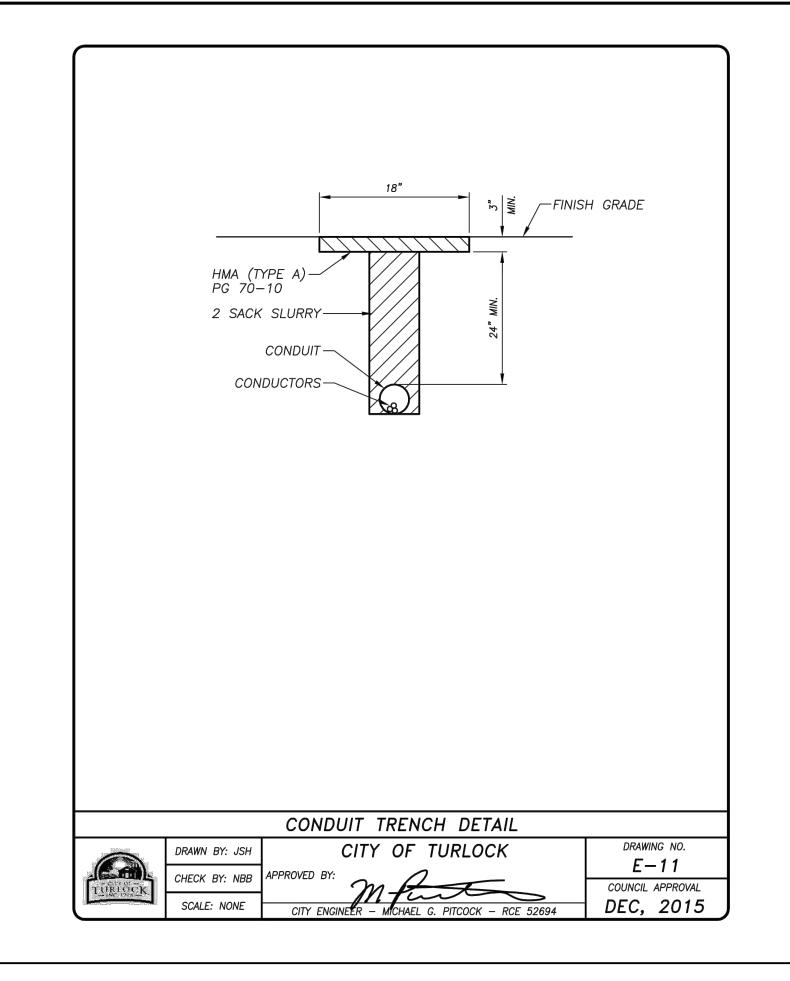

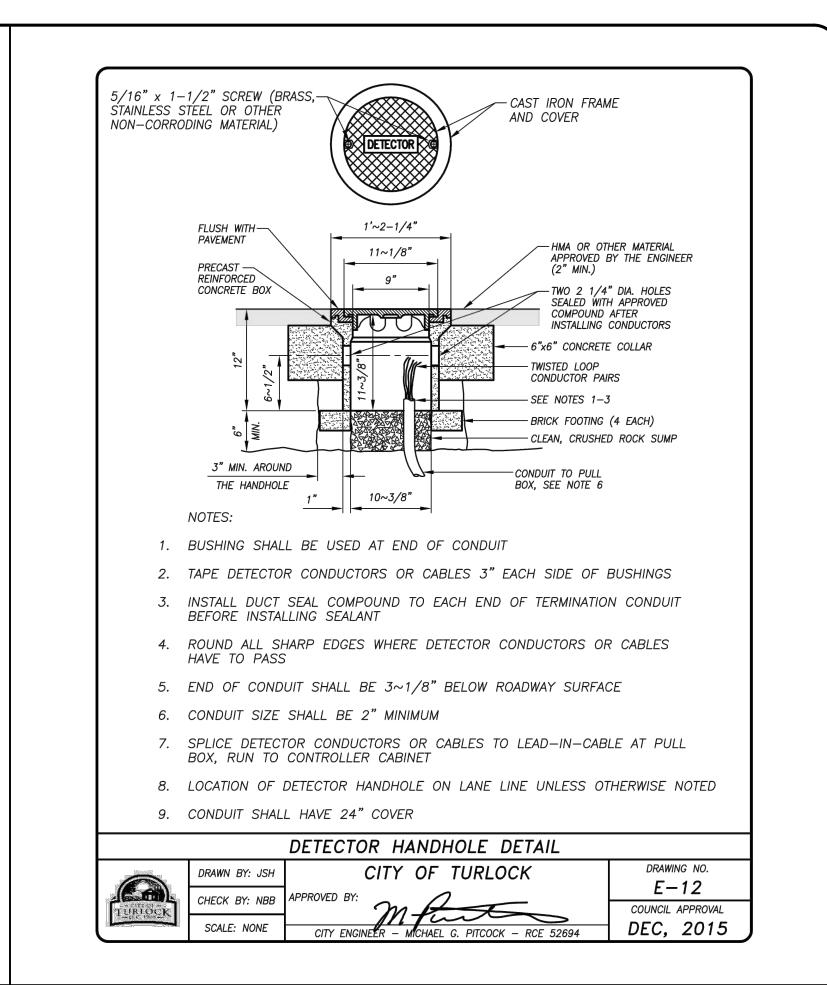

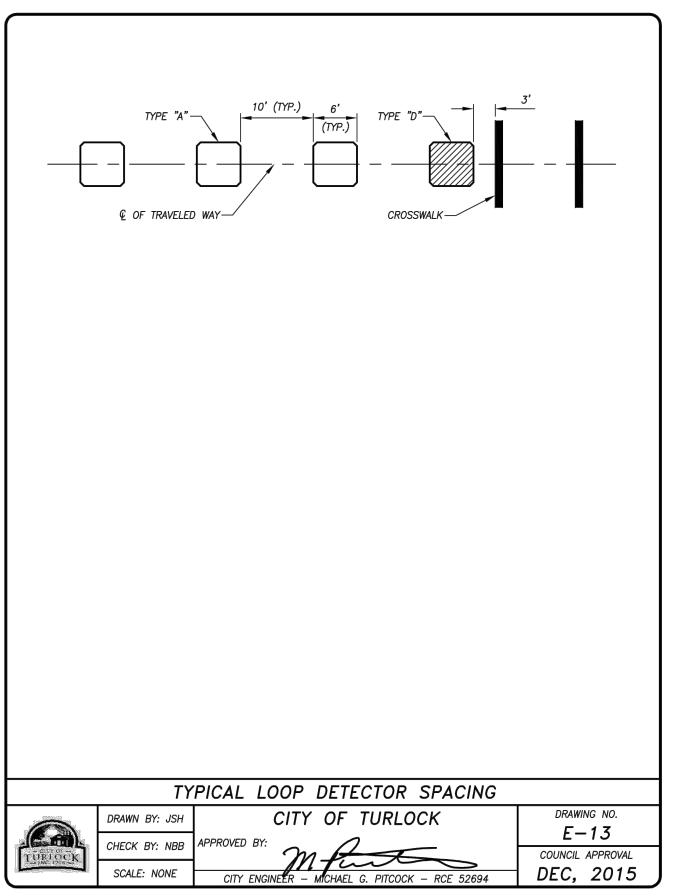

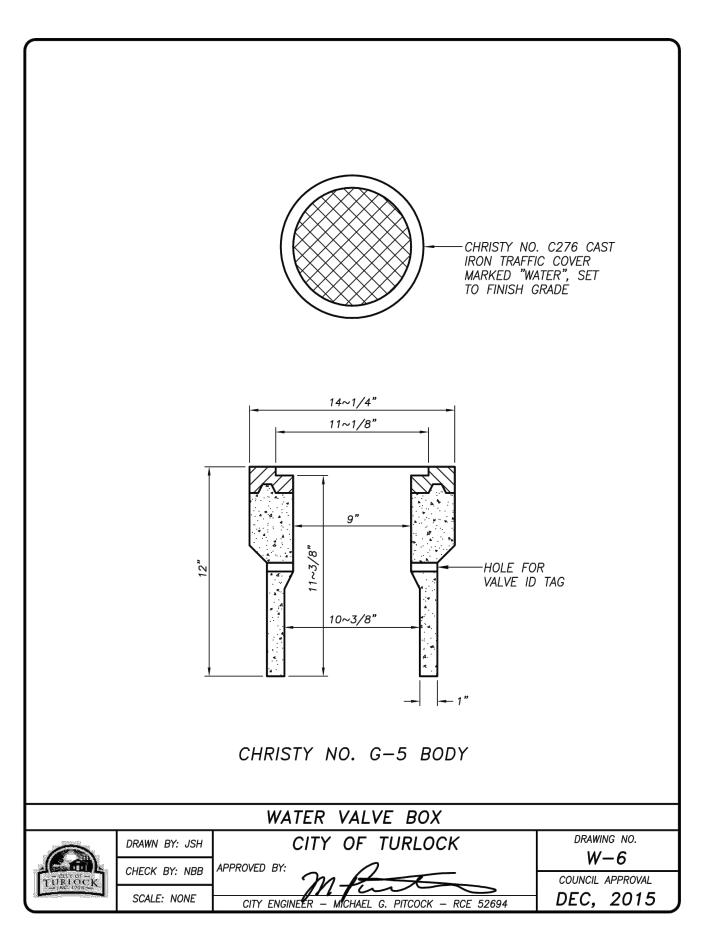

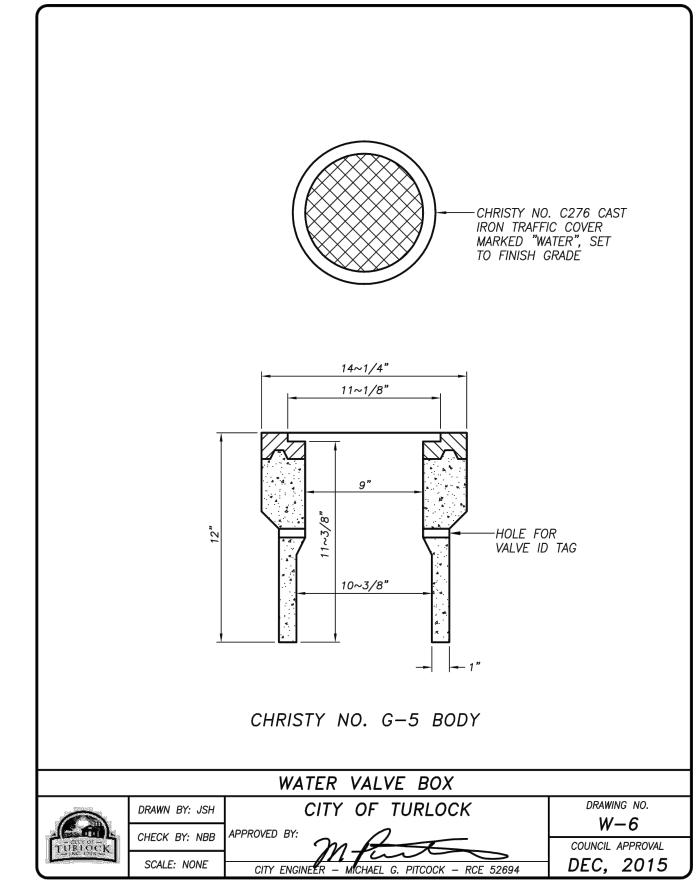


NOT TO SCALE



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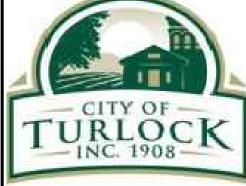
ulaman & Ariam SULAIMAN ARAIN P.E. LICENSE No. C78364

PLANS APPROVAL DATE

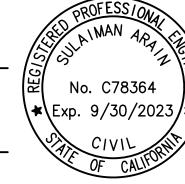

Michael Baker 500 YGNACIO VALLEY RD SUITE 300 WALNUT CREEK, CA 94596

(925) 906-1460



CITY OF TURLOCK PUBLIC WORKS DEPARTMENT **ENGINEERING DIVISION** 156 S. BROADWAY, SUITE 150 (209) 668-5520


CONSTRUCTION DETAILS

CAPITAL PROJECT No. 22-001 CITYWIDE STREET RECONSTRUCTION AND IMPROVEMENT PROJECT


VERIFY SCALE BAR IS 1" ON ORIGINAL DRAWING 1/4" 3/4" 0 _____1 IF NOT ONE INCH ON THIS SHEET, ADJUST SCALES

ACCORDINGLY


DRAWN BY: J. MILLER DRAWING No. REV. BY: CD-04 CH. BY: S. ARAIN 08/29/2022 SCALE: AS SHOWN 23 OF 29 MBI PROJECT No. 187020

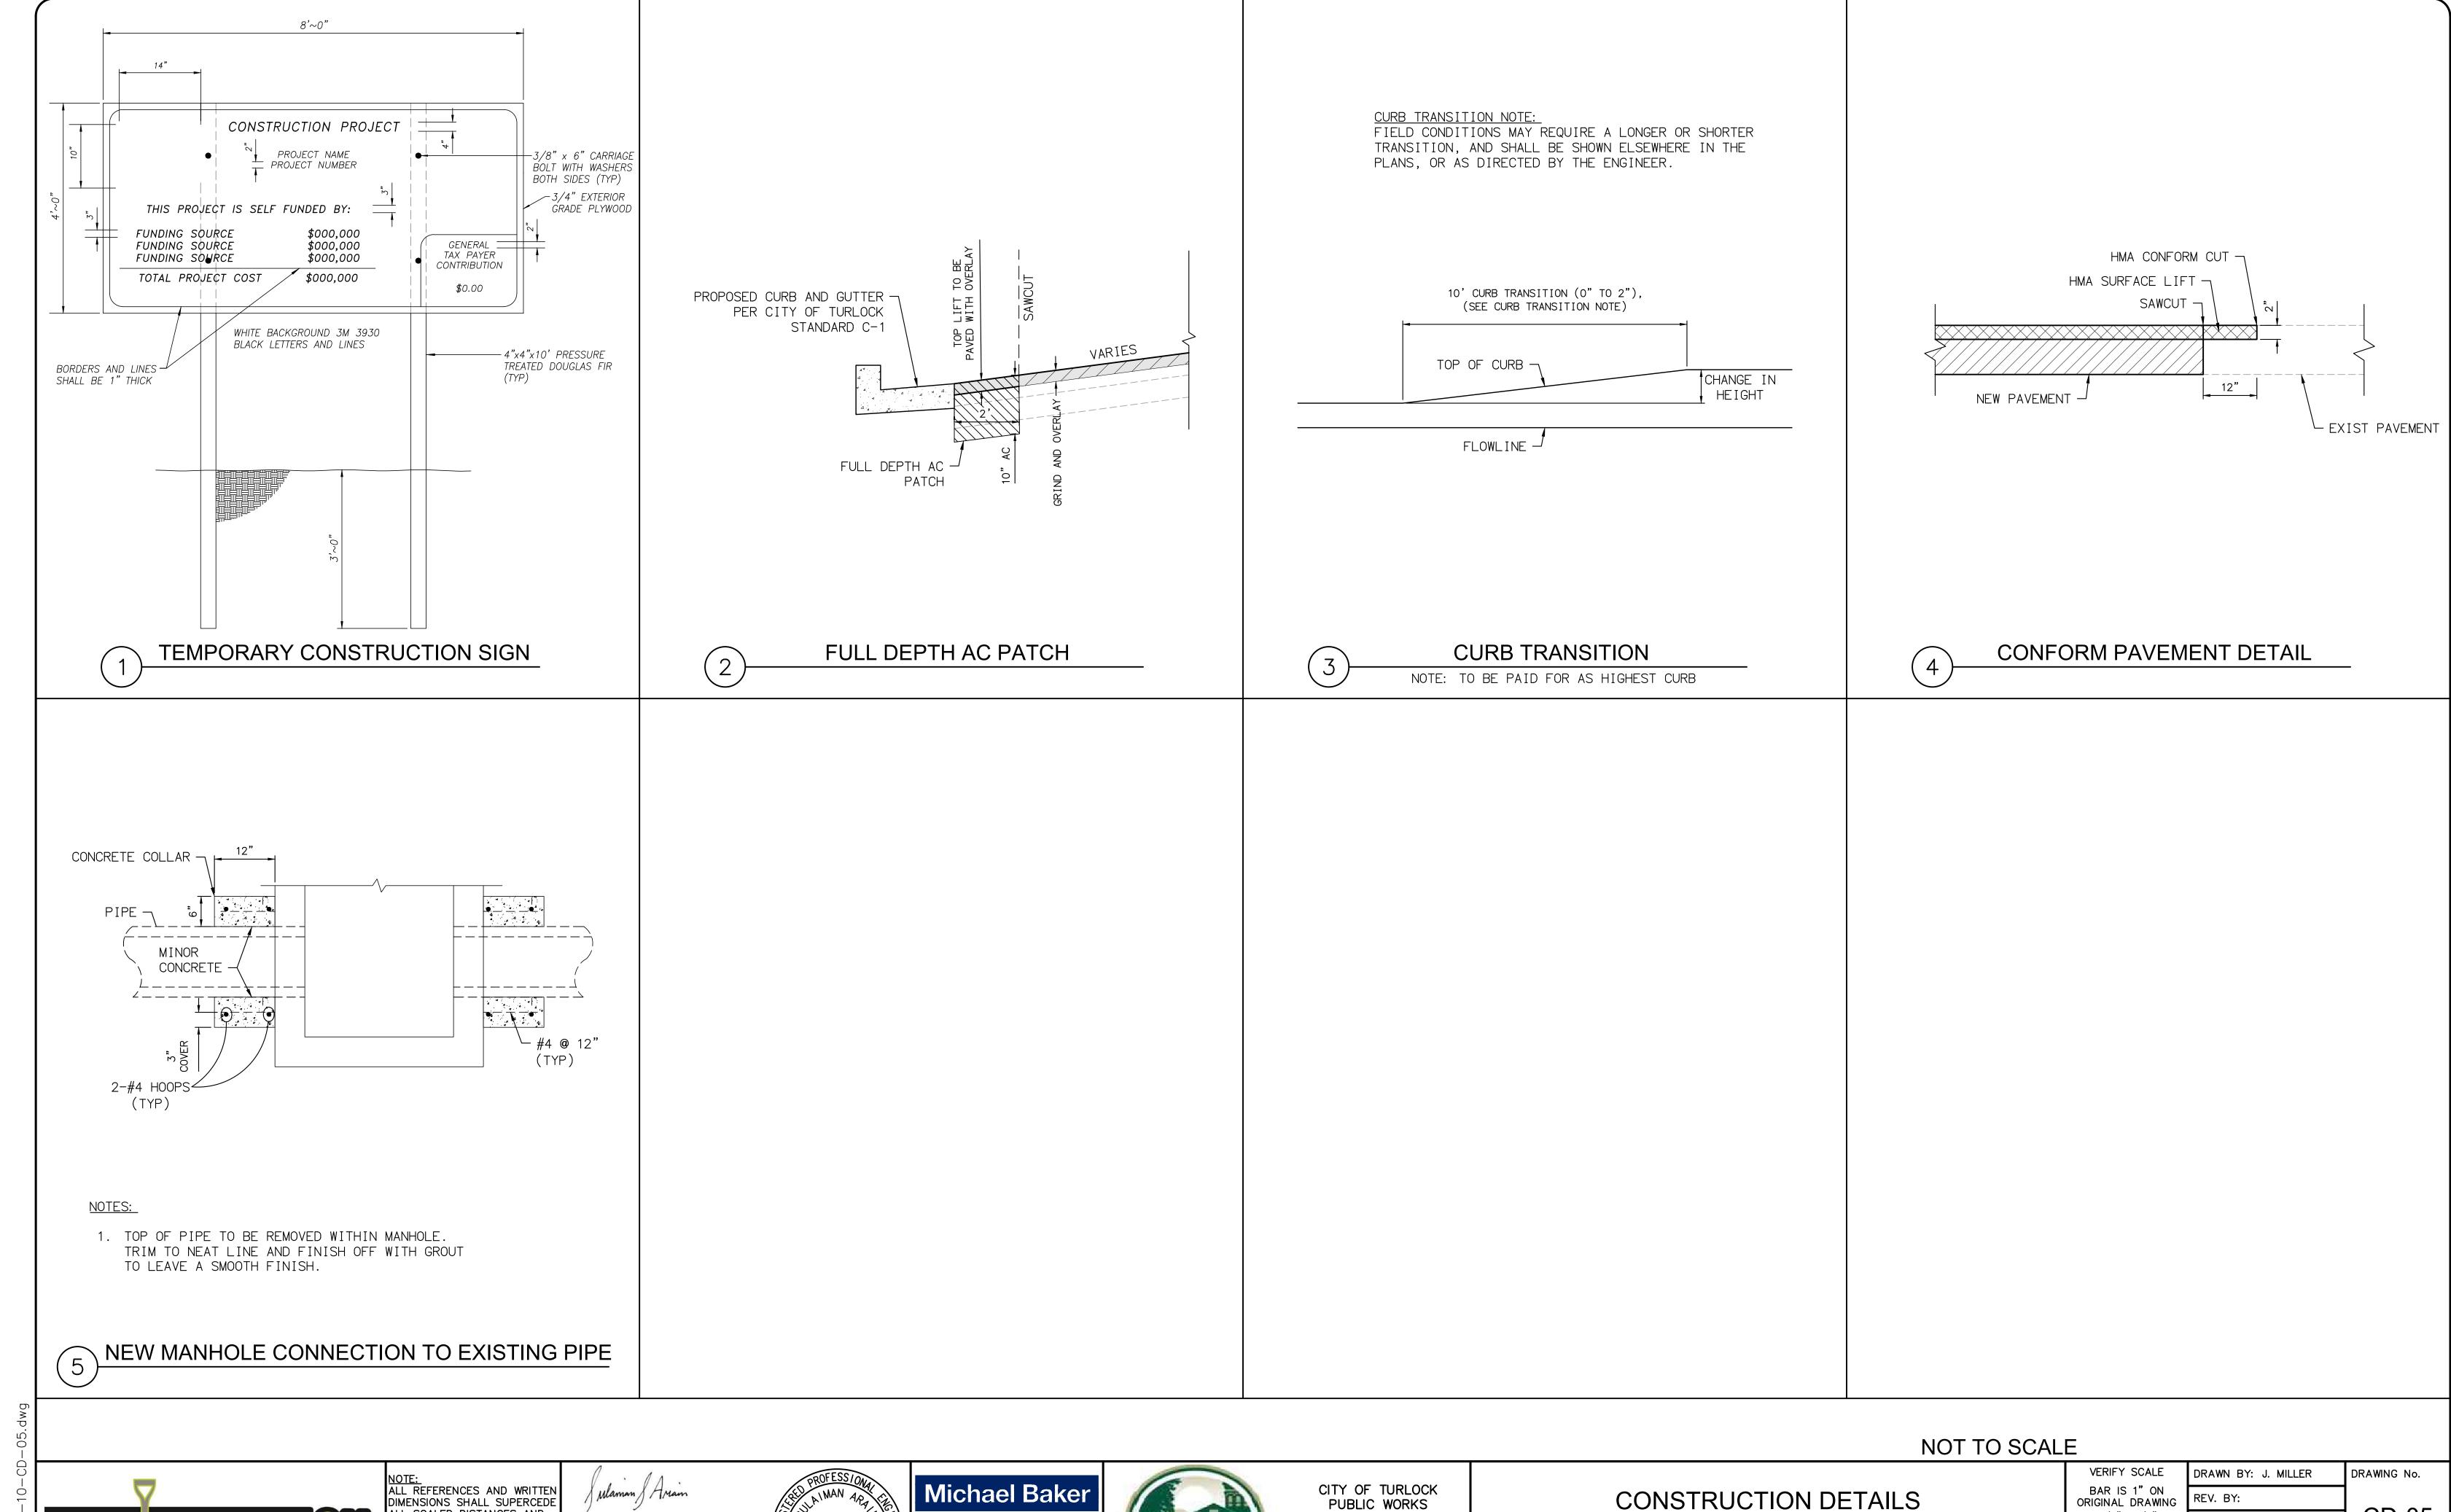


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PLANS APPROVAL DATE

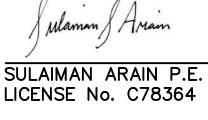



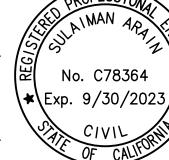

CITY OF TURLOCK PUBLIC WORKS DEPARTMENT ENGINEERING DIVISION 156 S. BROADWAY, SUITE 150 (209) 668-5520

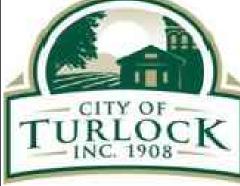CAPITAL PROJECT No. 22-001 CITYWIDE STREET RECONSTRUCTION AND IMPROVEMENT PROJECT

VERIFY SCALE
BAR IS 1" ON ORIGINAL DRAWING
1/4" 3/4"
0 1"
1/2"
IE NOT ONE INOU
IF NOT ONE INCH
ON THIS SHEET,


RAWN BY:	J. MILLER	DRAWING No.
REV. BY:		00.05
CH. BY:	S. ARAIN	CD-05
ATE:	08/29/2022	SHEET:
SCALE:	AS SHOWN	
		24 OF 29


MBI PROJECT No. 187020


Before You Dig

- 1. ELEVATIONS SHOWN INDICATE PAVEMENT ELEVATION UNLESS OTHERWISE NOTED.
- 2. FOR CURB RAMP LAYOUT INFORMATION SEE L-02.
- 3. FOR RIGHT OF WAY INFORMATION SEE SHEET L-02.

		CURVE DATA T	ABLE	
NO.	RADIUS	DELTA	TANGENT	LENGTH
1	25.00'	089 ° 59'58.05"	25.00'	39.27

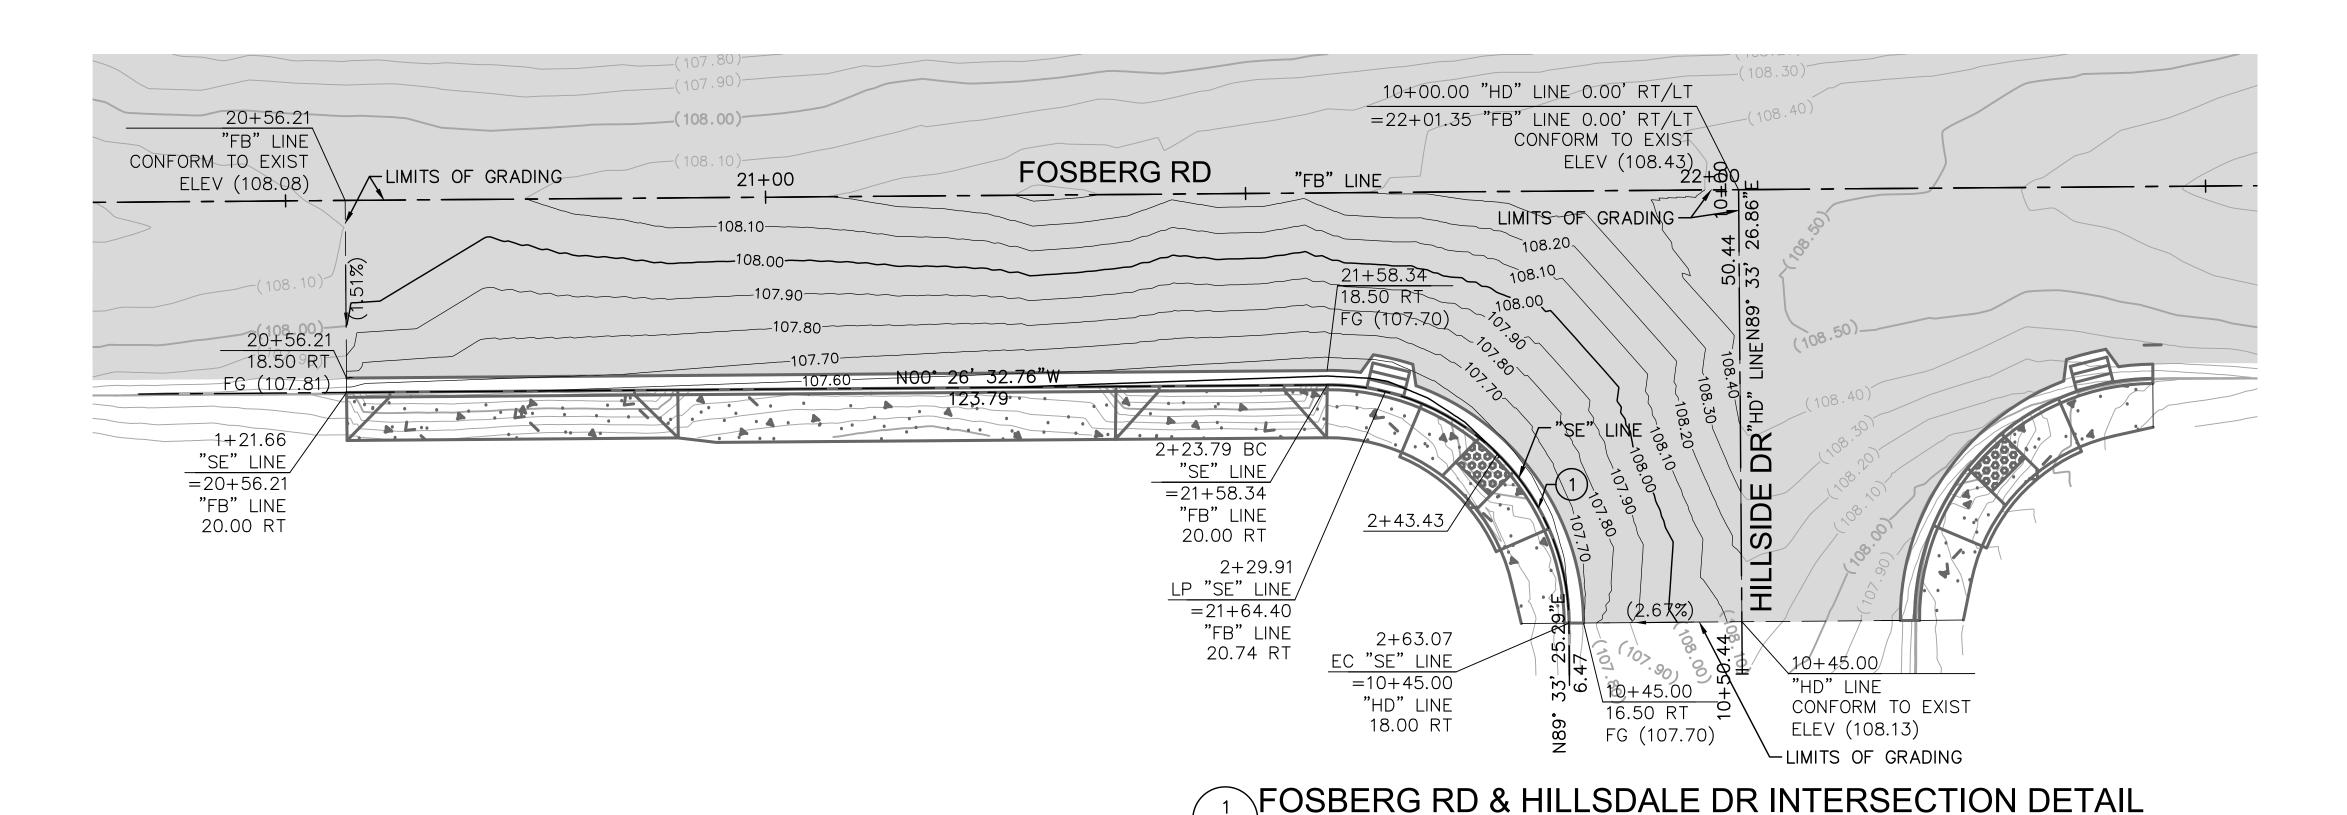

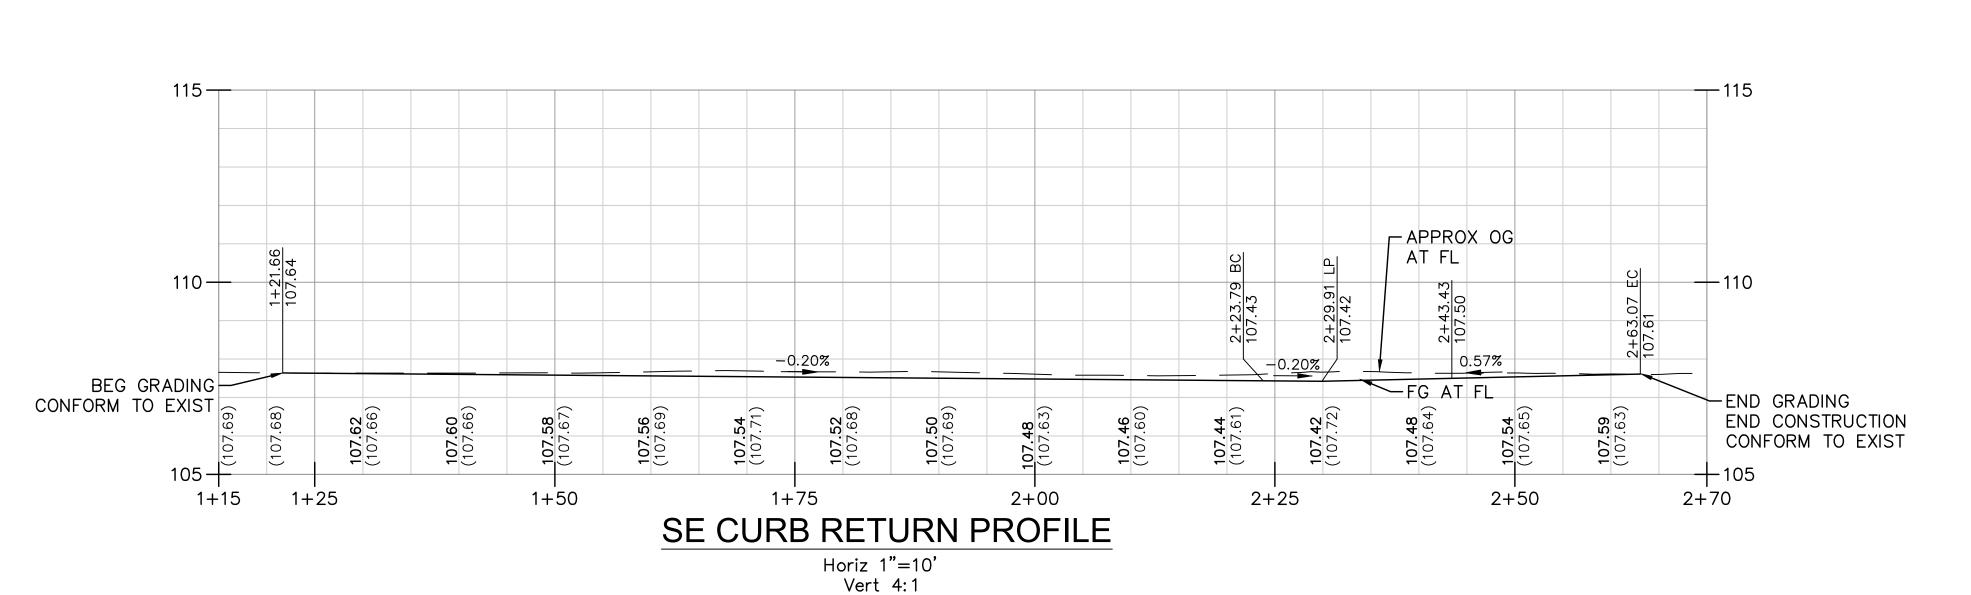

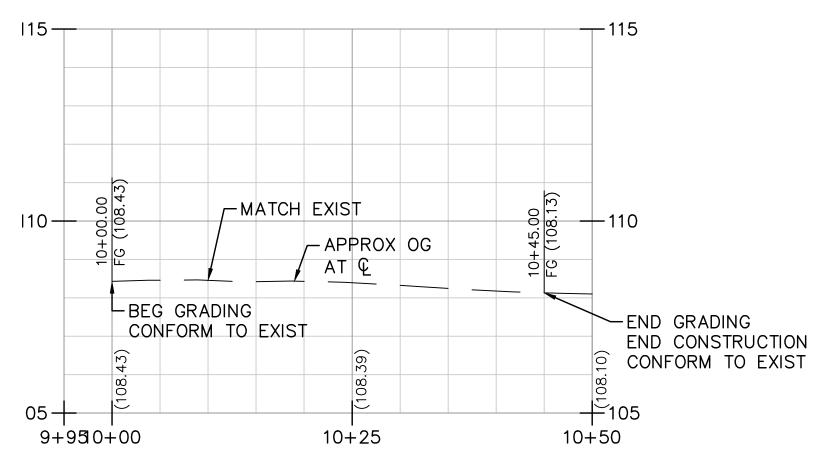


HILLSDALE CENTERLINE PROFILE

Horiz 1"=10'
Vert 4:1



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PRIOR TO THE COMMENCEMENT

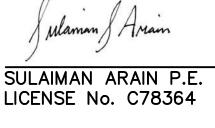

PLANS APPROVAL DATE

PROFESS/ONAL PROF

Michael Baker
INTERNATIONAL
500 YGNACIO VALLEY RD
SUITE 300
WALNUT CREEK, CA 94596
(925) 906-1460



CITY OF TURLOCK
PUBLIC WORKS
DEPARTMENT
ENGINEERING DIVISION
156 S. BROADWAY,
SUITE 150
(209) 668-5520

1" = 10'

CONSTRUCTION DETAILS INTERSECTION


CAPITAL PROJECT No. 22-001 CITYWIDE STREET RECONSTRUCTION AND IMPROVEMENT PROJECT

VERIFY S	SCALE
BAR IS ORIGINAL D	
1/4" 3	3/4"
0	1"
1/2	
IF NOT ON ON THIS ADJUST S ACCORDI	SHEET, SCALES


DRAWN BY:	J. MILLER	DRAWING No.
REV. BY:		
CH. BY:	S. ARAIN	CD-06
DATE:	08/29/2022	SHEET:
SCALE:	AS SHOWN	
		l 25 OF 29

MBI PROJECT No. 187020

22-001-P3-10-CD-06.dw

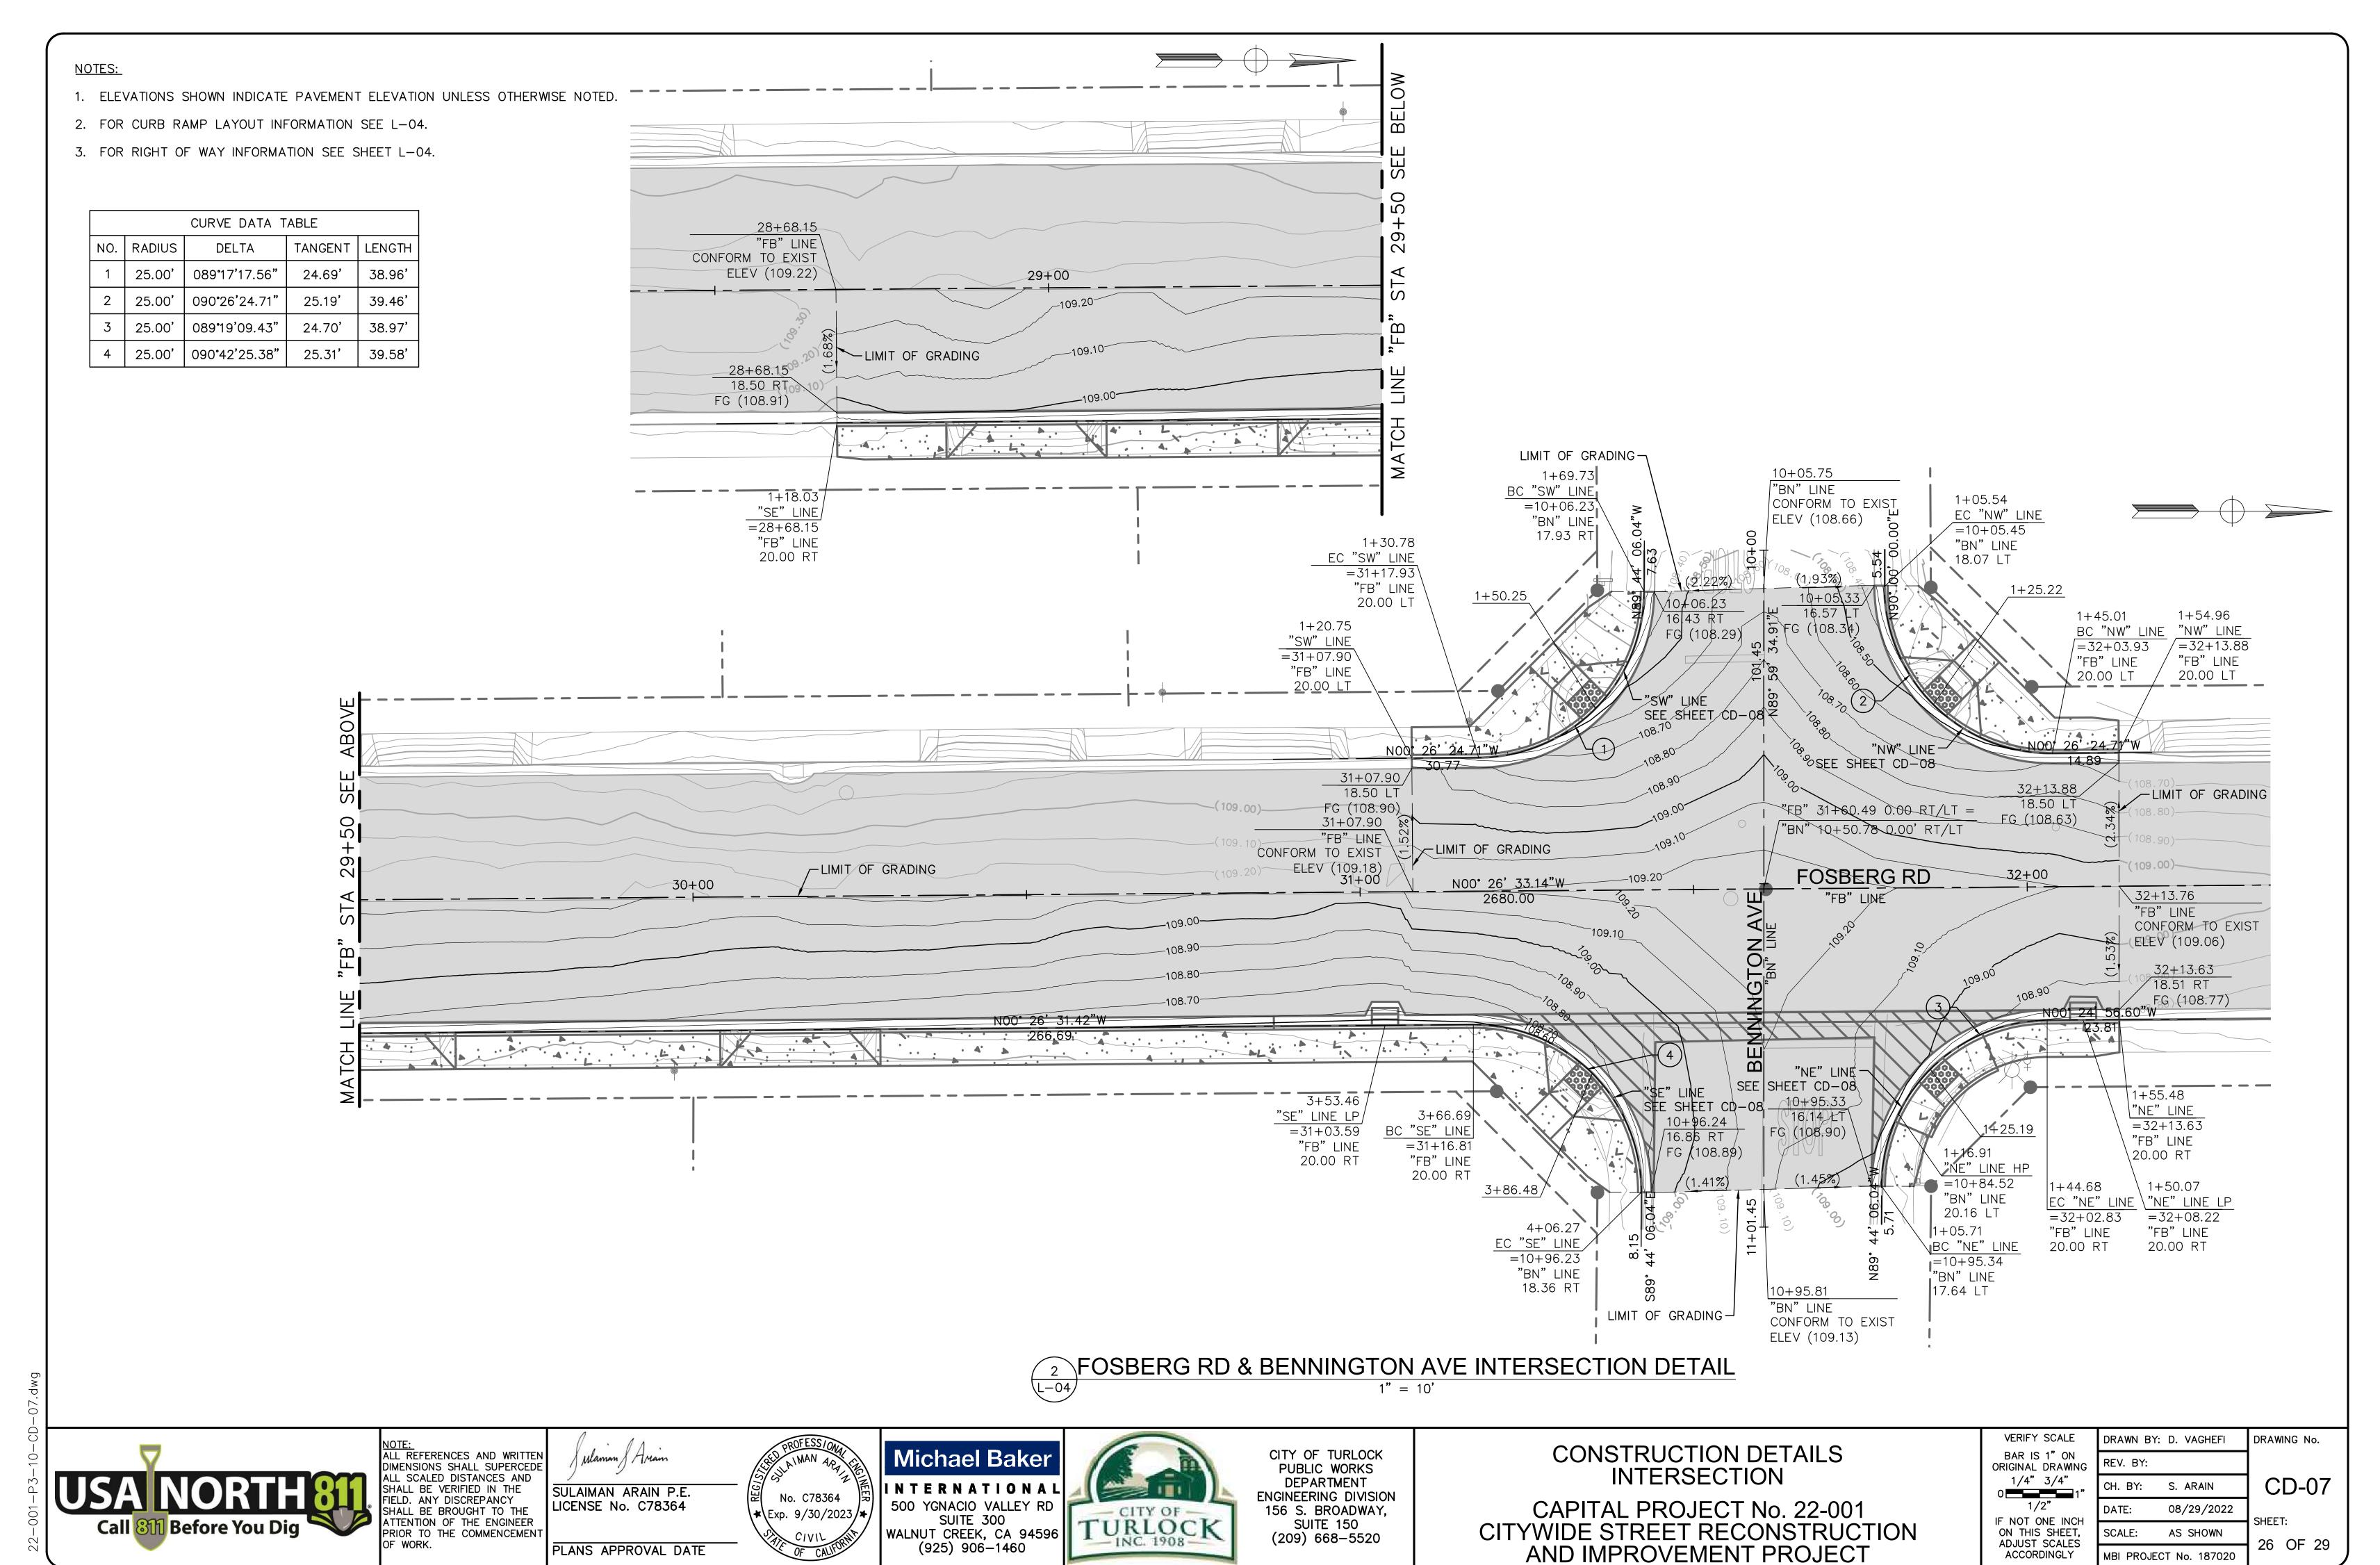



- 1. FOR CURB RAMP LAYOUT INFORMATION SEE L-04.
- 2. SEE SHEET CD-07 FOR FOSBERG RD AND BENNINGTON AVE GRADING DETAIL.

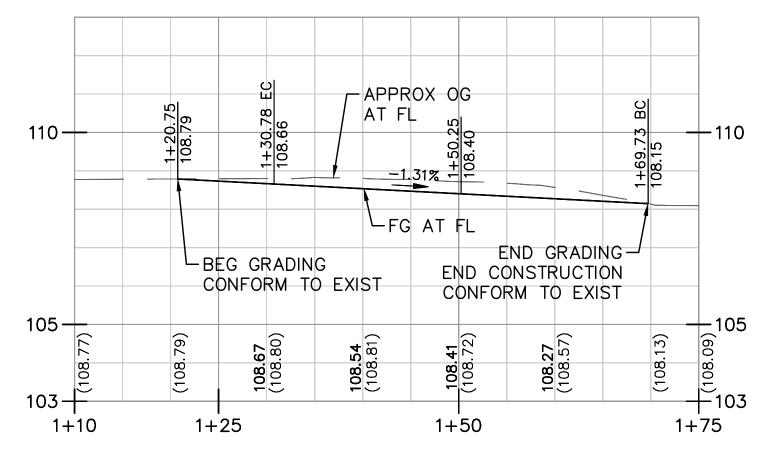

SW CURB RETURN PROFILE


Horiz 1"=10'
Vert 4:1

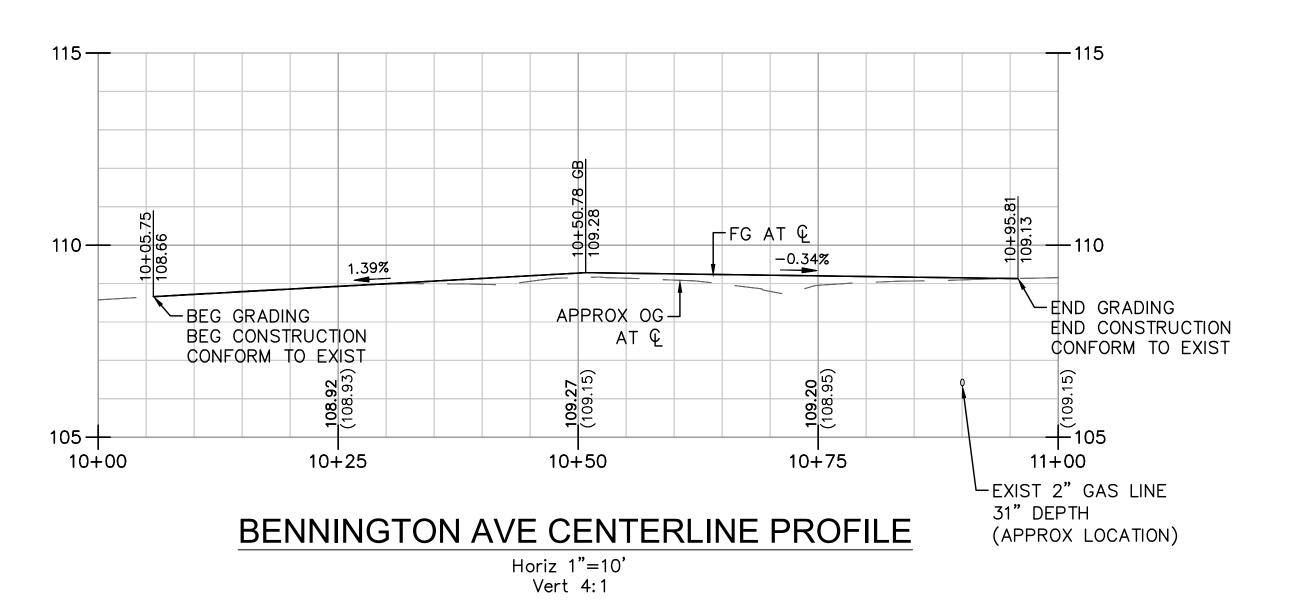

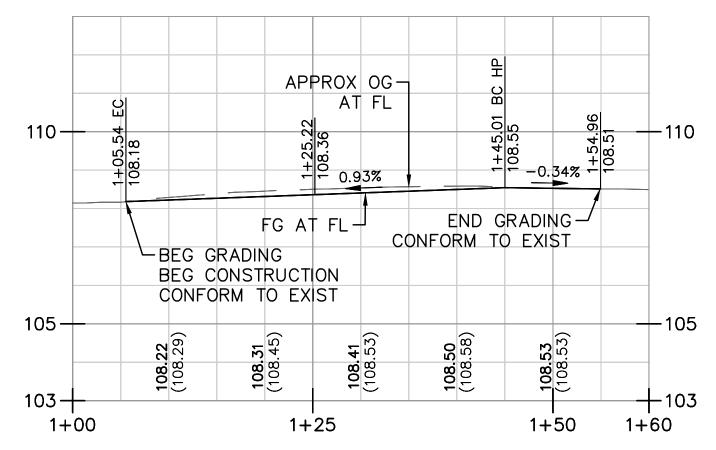


NW CURB RETURN PROFILE

Horiz 1"=10' Vert 4:1

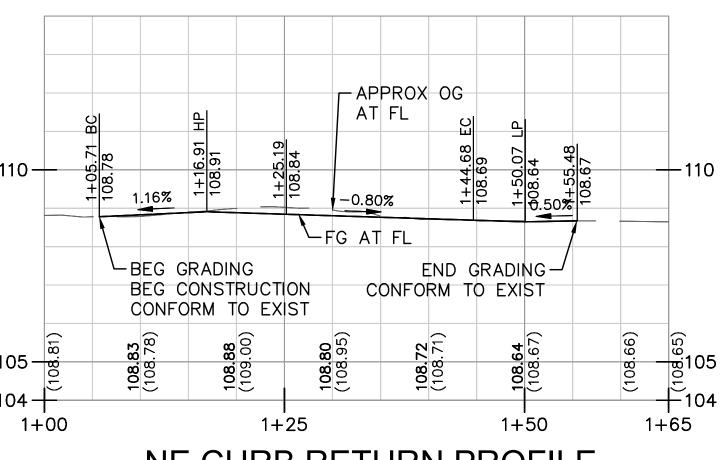

NE CURB RETURN PROFILE


Horiz 1"=10'
Vert 4:1

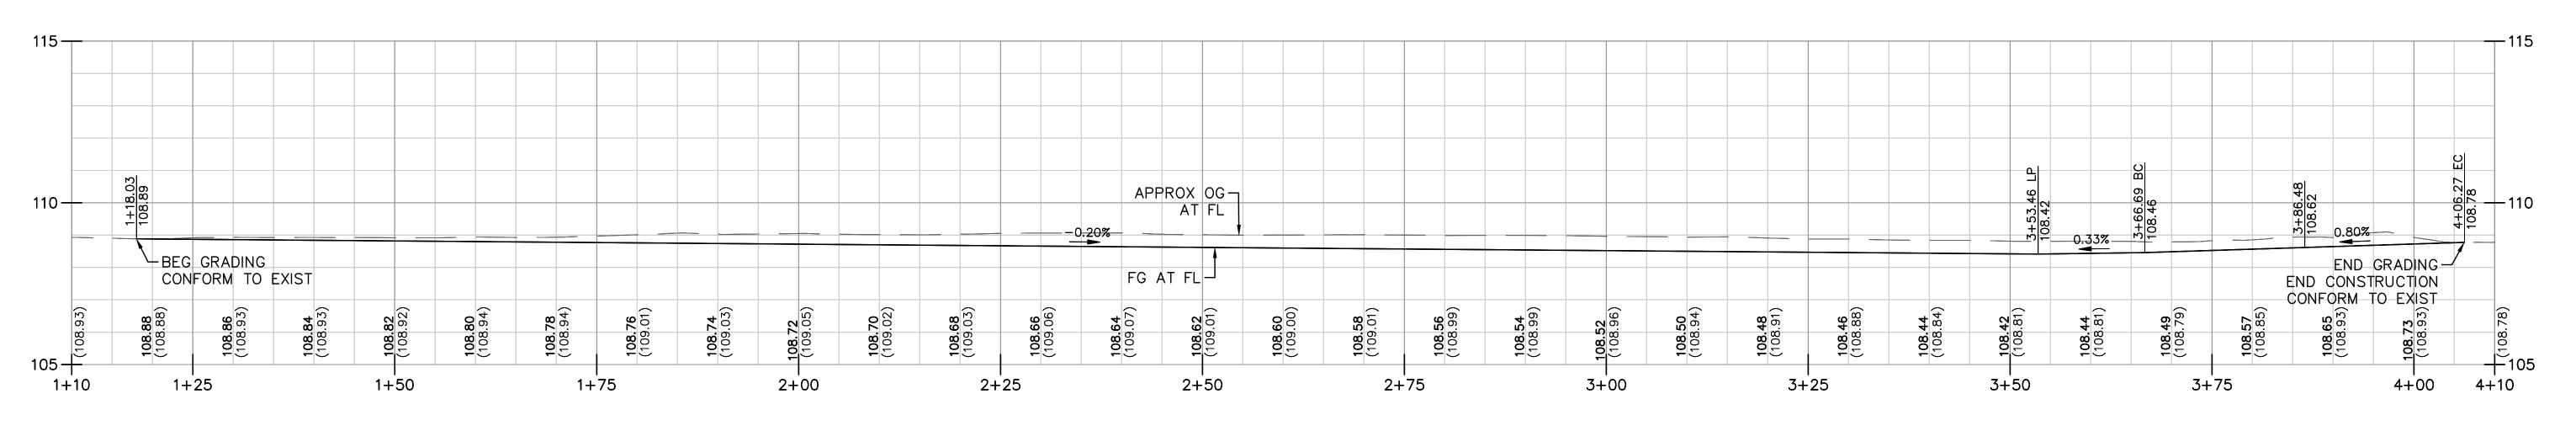

SE CURB RETURN PROFILE Horiz 1"=10' Vert 4:1




NOTE:
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DIMENSIONS SHALL SUPERCEDE
ALL SCALED DISTANCES AND
SHALL BE VERIFIED IN THE
FIELD. ANY DISCREPANCY
SHALL BE BROUGHT TO THE
ATTENTION OF THE ENGINEER
PRIOR TO THE COMMENCEMENT

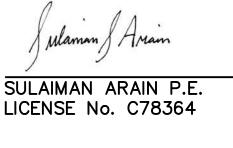

PLANS APPROVAL DATE

PROFESS/ONAL PROFE

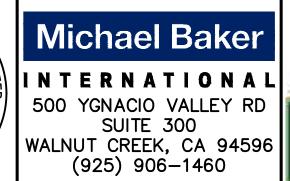



CITY OF TURLOCK
PUBLIC WORKS
DEPARTMENT
ENGINEERING DIVISION
156 S. BROADWAY,
SUITE 150
(209) 668-5520

CONSTRUCTION DETAILS INTERSECTION


CAPITAL PROJECT No. 22-001 CITYWIDE STREET RECONSTRUCTION AND IMPROVEMENT PROJECT

VERIFY SCALE	
BAR IS 1" ON ORIGINAL DRAWING	ľ
1/4" 3/4"	I
1/2"	ľ
IF NOT ONE INCH ON THIS SHEET, ADJUST SCALES	

ACCORDINGLY

		_
DRAWN BY:	D. VAGHEFI	DRAWING No.
REV. BY:		
CH. BY:	S. ARAIN	CD-08
DATE:	08/29/2022	SHEET:
SCALE:	AS SHOWN	27 OF 29
MBI PROJEC	T No. 187020	21 OF 29

- 1. ELEVATIONS SHOWN INDICATE PAVEMENT ELEVATION UNLESS OTHERWISE NOTED.
- 2. FOR CURB RAMP LAYOUT INFORMATION SEE L-04.
- 3. FOR RIGHT OF WAY INFORMATION SEE SHEET L-04.

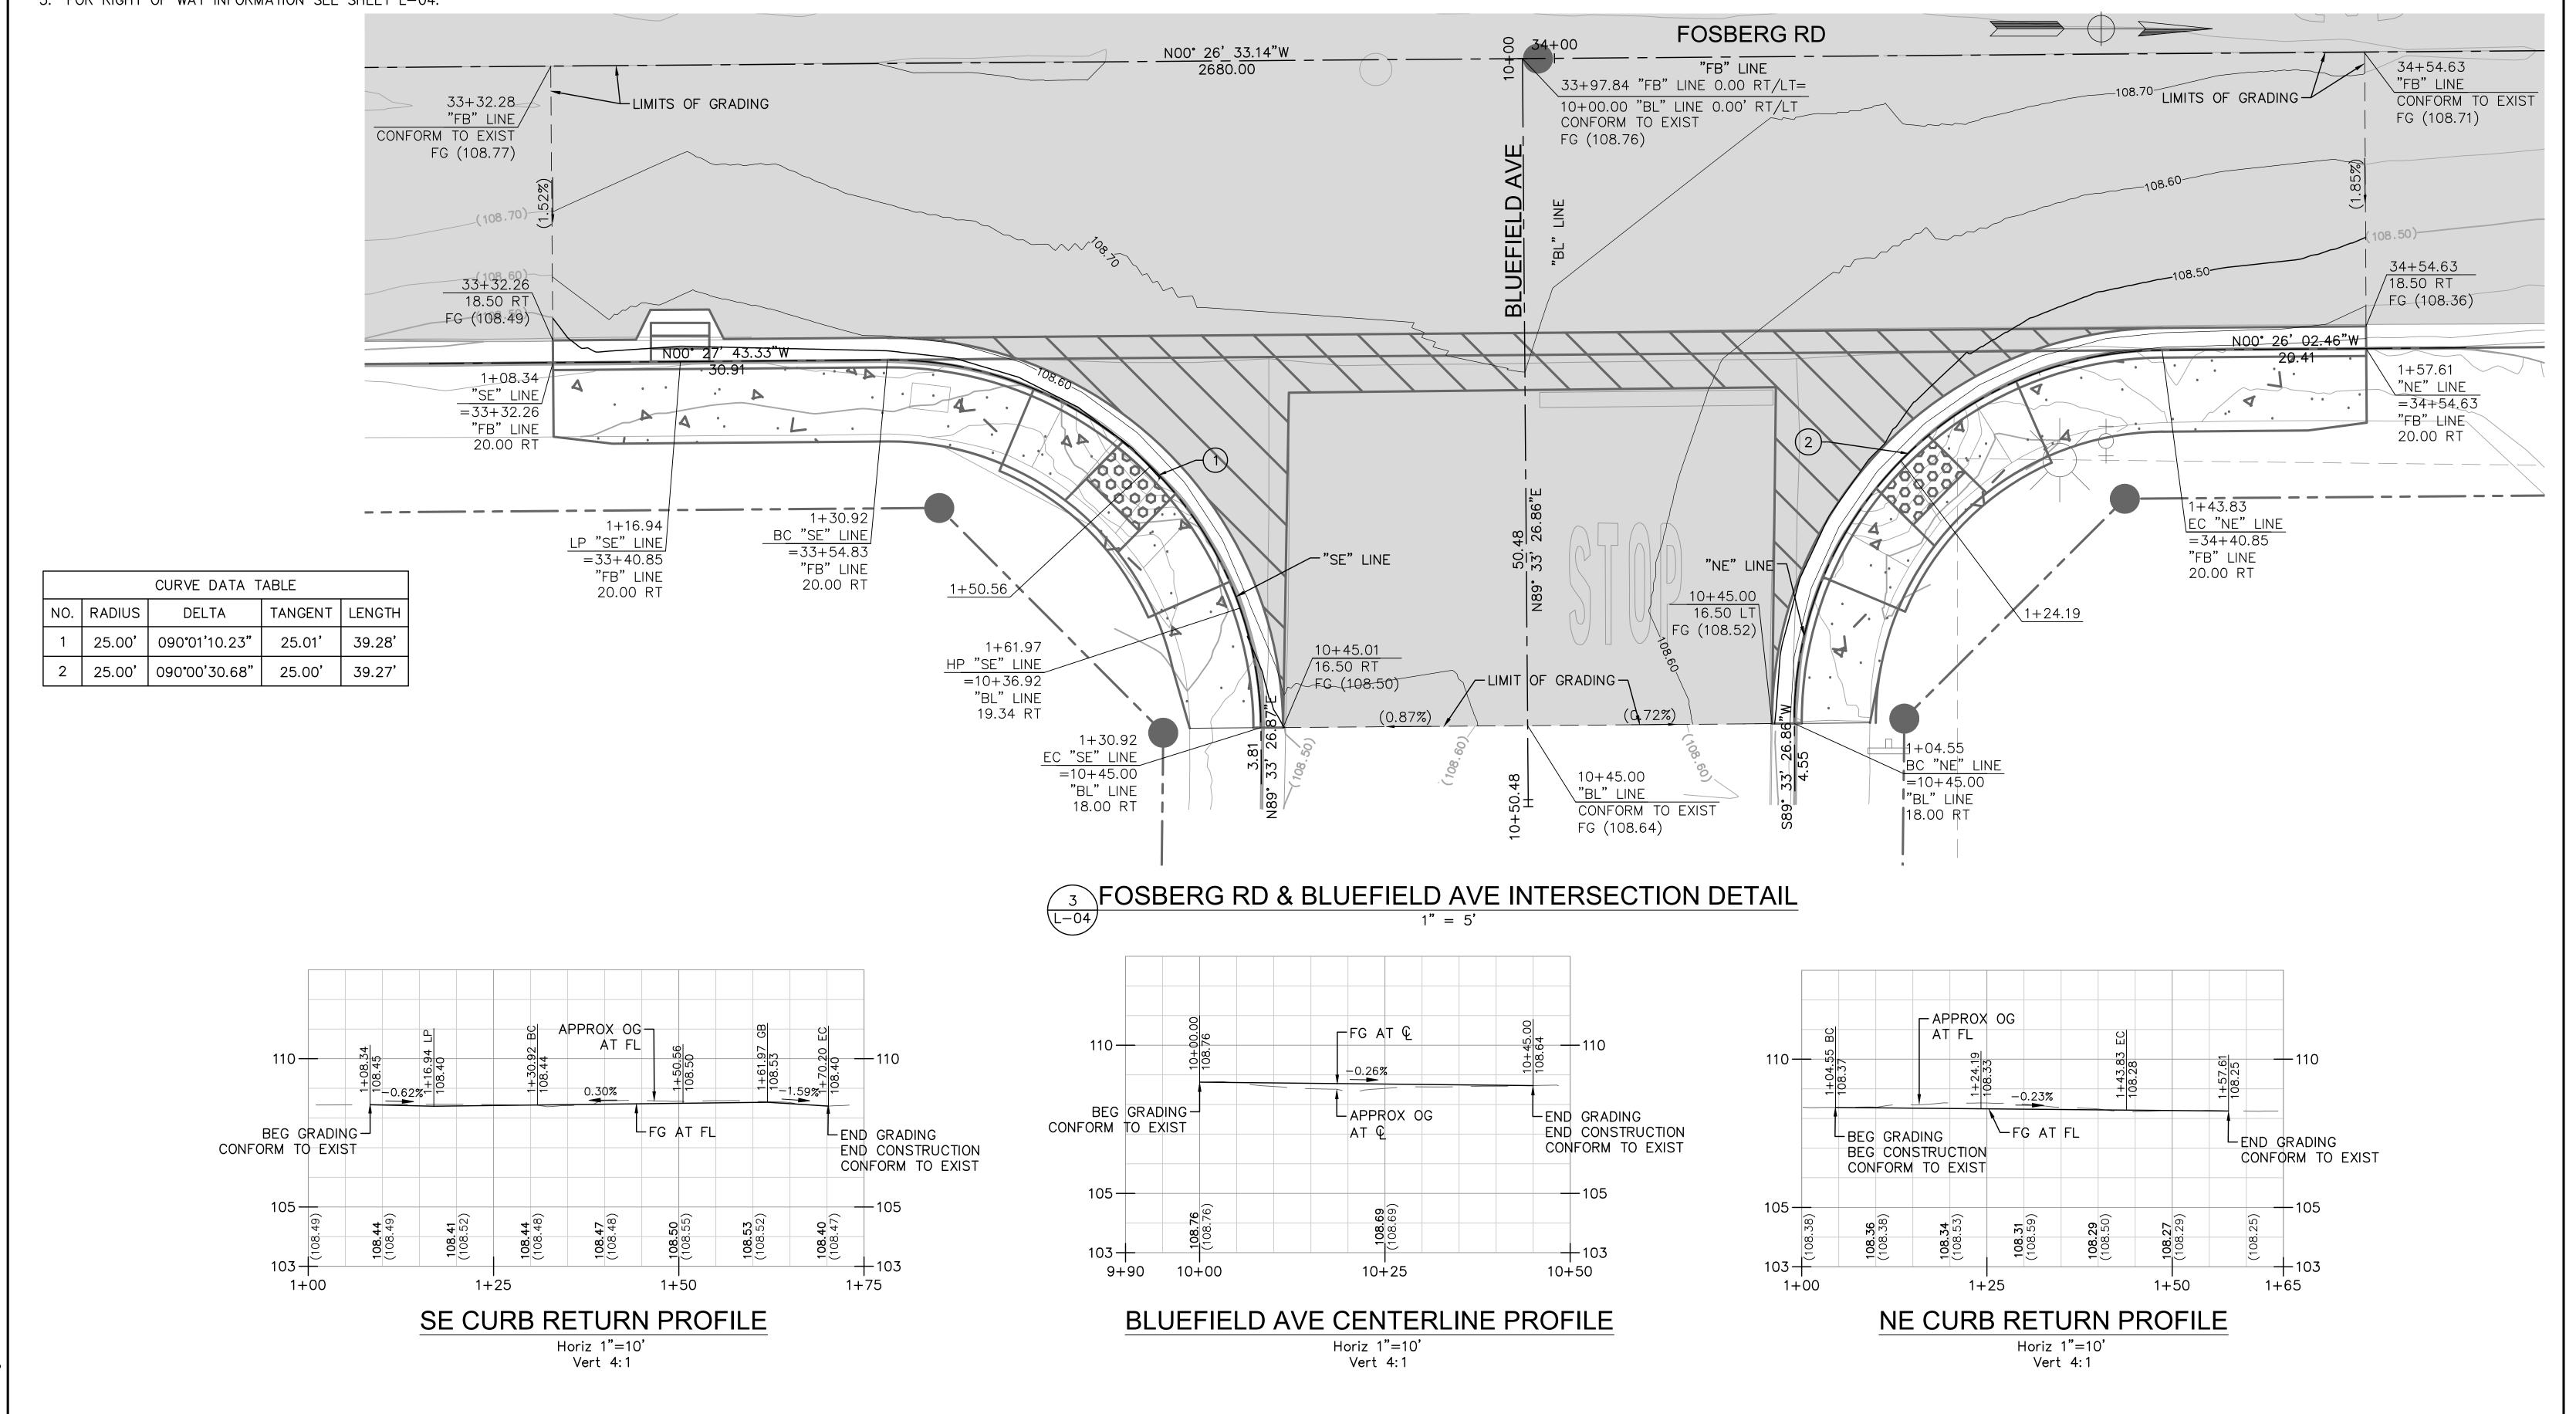

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PRIOR TO THE COMMENCEMENT

OF WORK.

Maman & Ariam SULAIMAN ARAIN P.E. LICENSE No. C78364

PLANS APPROVAL DATE

No. C78364

★Exp. 9/30/2023

Michael Baker 500 YGNACIO VALLEY RD SUITE 300 WALNUT CREEK, CA 94596 (925) 906-1460



CITY OF TURLOCK PUBLIC WORKS DEPARTMENT ENGINEERING DIVISION 156 S. BROADWAY, SUITE 150 (209) 668-5520

CONSTRUCTION DETAILS **INTERSECTION**

CAPITAL PROJECT No. 22-001 CITYWIDE STREET RECONSTRUCTION AND IMPROVEMENT PROJECT

VERIFY SCALE
BAR IS 1" ON ORIGINAL DRAWING
1/4" 3/4"
01" 1"
1/2
IF NOT ONE INCH ON THIS SHEET,

ACCORDINGLY

DRAWN BY: J. MILLER DRAWING No. REV. BY: CD-09 CH. BY: S. ARAIN 08/29/2022 DATE: SHEET: AS SHOWN SCALE: 28 OF 29 MBI PROJECT No. 187020

PAVEMENT	QUAN	TITIES	
SHEET ID	REMOVE AC PAVEMENT AND BASE	HOT MIX ASPHALT (TYPE A)	AGGREGATE BASE
	CY	TON	CY
L-01	529	545	260
L-02	337	724	61
L-03	666	745	359
L-04	674	786	490
TOTAL	2204	2800	1169

REMOVE EXIST CURB AND GUTTER AOVE EXISTING (DRIVEWAY/SIDEWALK) REMOVE EXISTING VALLEY GUTTER NOR CONCRETE (CURB AND FLATWORK) CONCRETE (SIDEWALK AND FLATWORK) REMOVE EXISTING VALLEY GUTTER)			
MOVE EXISTIN VE EXISTIN R CONCRETE CONCRETE		IES	
REMC REMCVE MINOR CON	SHEET ID	MINOR CONCRE	CONCRETE
LF SF SF LF SF SF		LF SF S	SF
L-01 114 568 0 114 628 108	L-01	114 628 1	80
L-02 303 1244 0 214 996 608	L-02	214 996 6	808
L-03 369 1747 0 315 1675 385	L-03	315 1675 3	885
L-04 440 1960 874 416 2230 168	L-04	416 2230 1	68
TOTAL 1226 5519 874 1059 5529 1269	TC	1059 5529 12	269

			ST	RIPIN	G QUA	NTITI	ES					
SHEET ID	THERMOPLASTIC STRIPING (DETAIL 1)	THERMOPLASTIC STRIPING (DETAIL 22)	THERMOPLASTIC STRIPING (DETAIL 38)	THERMOPLASTIC STRIPING (DETAIL 12" STOP BAR)	THERMOPLASTIC PAVEMENT MARKINGS (WHITE "CONTINENTAL" CROSSWALK)	THERMOPLASTIC PAVEMENT MARKINGS (WHITE)	PAVEMENT MARKER (TYPE BB)	PAINT EXISTING CURB	INSTALL SIGN PANEL (STREET NAME 42" X 9")	INSTALL SIGN PANEL (STREET NAME 48" X 9")	REMOVE EXISTING CROSSWALK BY SANDBLASTING	REMOVE EXISTING PAVEMENT MARKING BY SANDBLASTING
	LF	LF	LF	LF	SF	SF	EA	LF	EA	EA	LF	EA
SS-01 TO SS-02	1160	1126	78	179	1251	262	5	427	3	3	340	2
TOTAL	1160	1126	78	179	1251	262	5	427	3	3	340	2

U	TILITY	' QUAI	VTITIE	S		
SHEET ID	ADJUST SDMH RIM TO GRADE	ADJUST SSMH RIM TO GRADE	ADJUST WATER VALVE TO GRADE	ADJUST GV BOX TO GRADE	ADJUST COMMUNICATION BOX TO GRADE	ADJUST SURVEY MONUMENT COVER TO GRADE
	EA	EA	EA	EA	EA	EA
L-01	2	1	4	0	0	5
L-02	2	2	5	0	1	10
L-03	2	3	4	1	0	10
L-04	2	3	8	1	0	14
TOTAL	8	9	21	2	1	39

DRAINAGE QUANTITIES					
SHEET ID	REMOVE EXIST CATCH BASIN	STORM DRAIN MANHOLE (60")	STORM DRAIN CATCH BASIN (SD-1)	STORM DRAIN PIPE (12" RCP)	
	EA	EA	EA	EA	
DU-01	1	0	3	74	
DU-02	0	1	3	142	
TOTAL	1	1	6	216	

FENCE QUANTITIES		
SHEET ID	RESET FENCE	
	LF	
L-01	34	
TOTAL	34	

TRAFFIC SIGNAL			
SHEET ID	TRAFFIC SIGNAL INTERSECTION LOOP DETECTORS		
L-01	2		
L-02	0		
L-03	0		
L-04	8		
TOTAL	10		



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PLANS APPROVAL DATE

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CITY OF TURLOCK
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SUMMARY OF QUANTITIES

CAPITAL PROJECT No. 22-001 CITYWIDE STREET RECONSTRUCTION AND IMPROVEMENT PROJECT

VERIFY SCALE BAR IS 1" ON ORIGINAL DRAWING 1/4" 3/4" 0 1" 1/2" IF NOT ONE INCH ON THIS SHEET, ADJUST SCALES ACCORDINGLY

DRAWN BY: J. MILLER DRAWING No. REV. BY: CH. BY: S. ARAIN 08/29/2022 SCALE:

Q-01 AS SHOWN 29 OF 29 MBI PROJECT No. 187020